

DEJARDIN ADDITION/RENOVATION

CLACKAMAS COMMUNITY COLLEGE


19600 MOLALLA AVE. OREGON CITY, OR 97045 SCHEMATIC DESIGN AUGUST 23,2017

mahlum

71 COLUMBIA | FLOOR 4 **SEATTLE** WA 98104 (206) 441-4151 OFFICE (206) 441-0478 FAX

1231 NW HOYT | SUITE 102 **PORTLAND** OR 97209 (503) 224-4032 OFFICE (503) 224-0918 FAX

MAHLUM ARCHITECTS INC

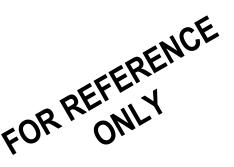



CLACKAMAS COMMUNITY COLLEGE DEJARDIN ADDITION/RENOVATION

19600 MOLALLA AVE. OREGON CITY, OR 97045

ISSUE: AUGUST 23,2017
ISSUE: SCHEMATIC DESIGN

PROJECT NO: 2017 A

DRAWN BY:


CHECKED BY:

COPYRIGHT MAHLUM ARCHITECTS, INC. 2011 ORIGINAL SHEET SIZE: 3

A COVER SHEET

EXHIBIT F

G-001

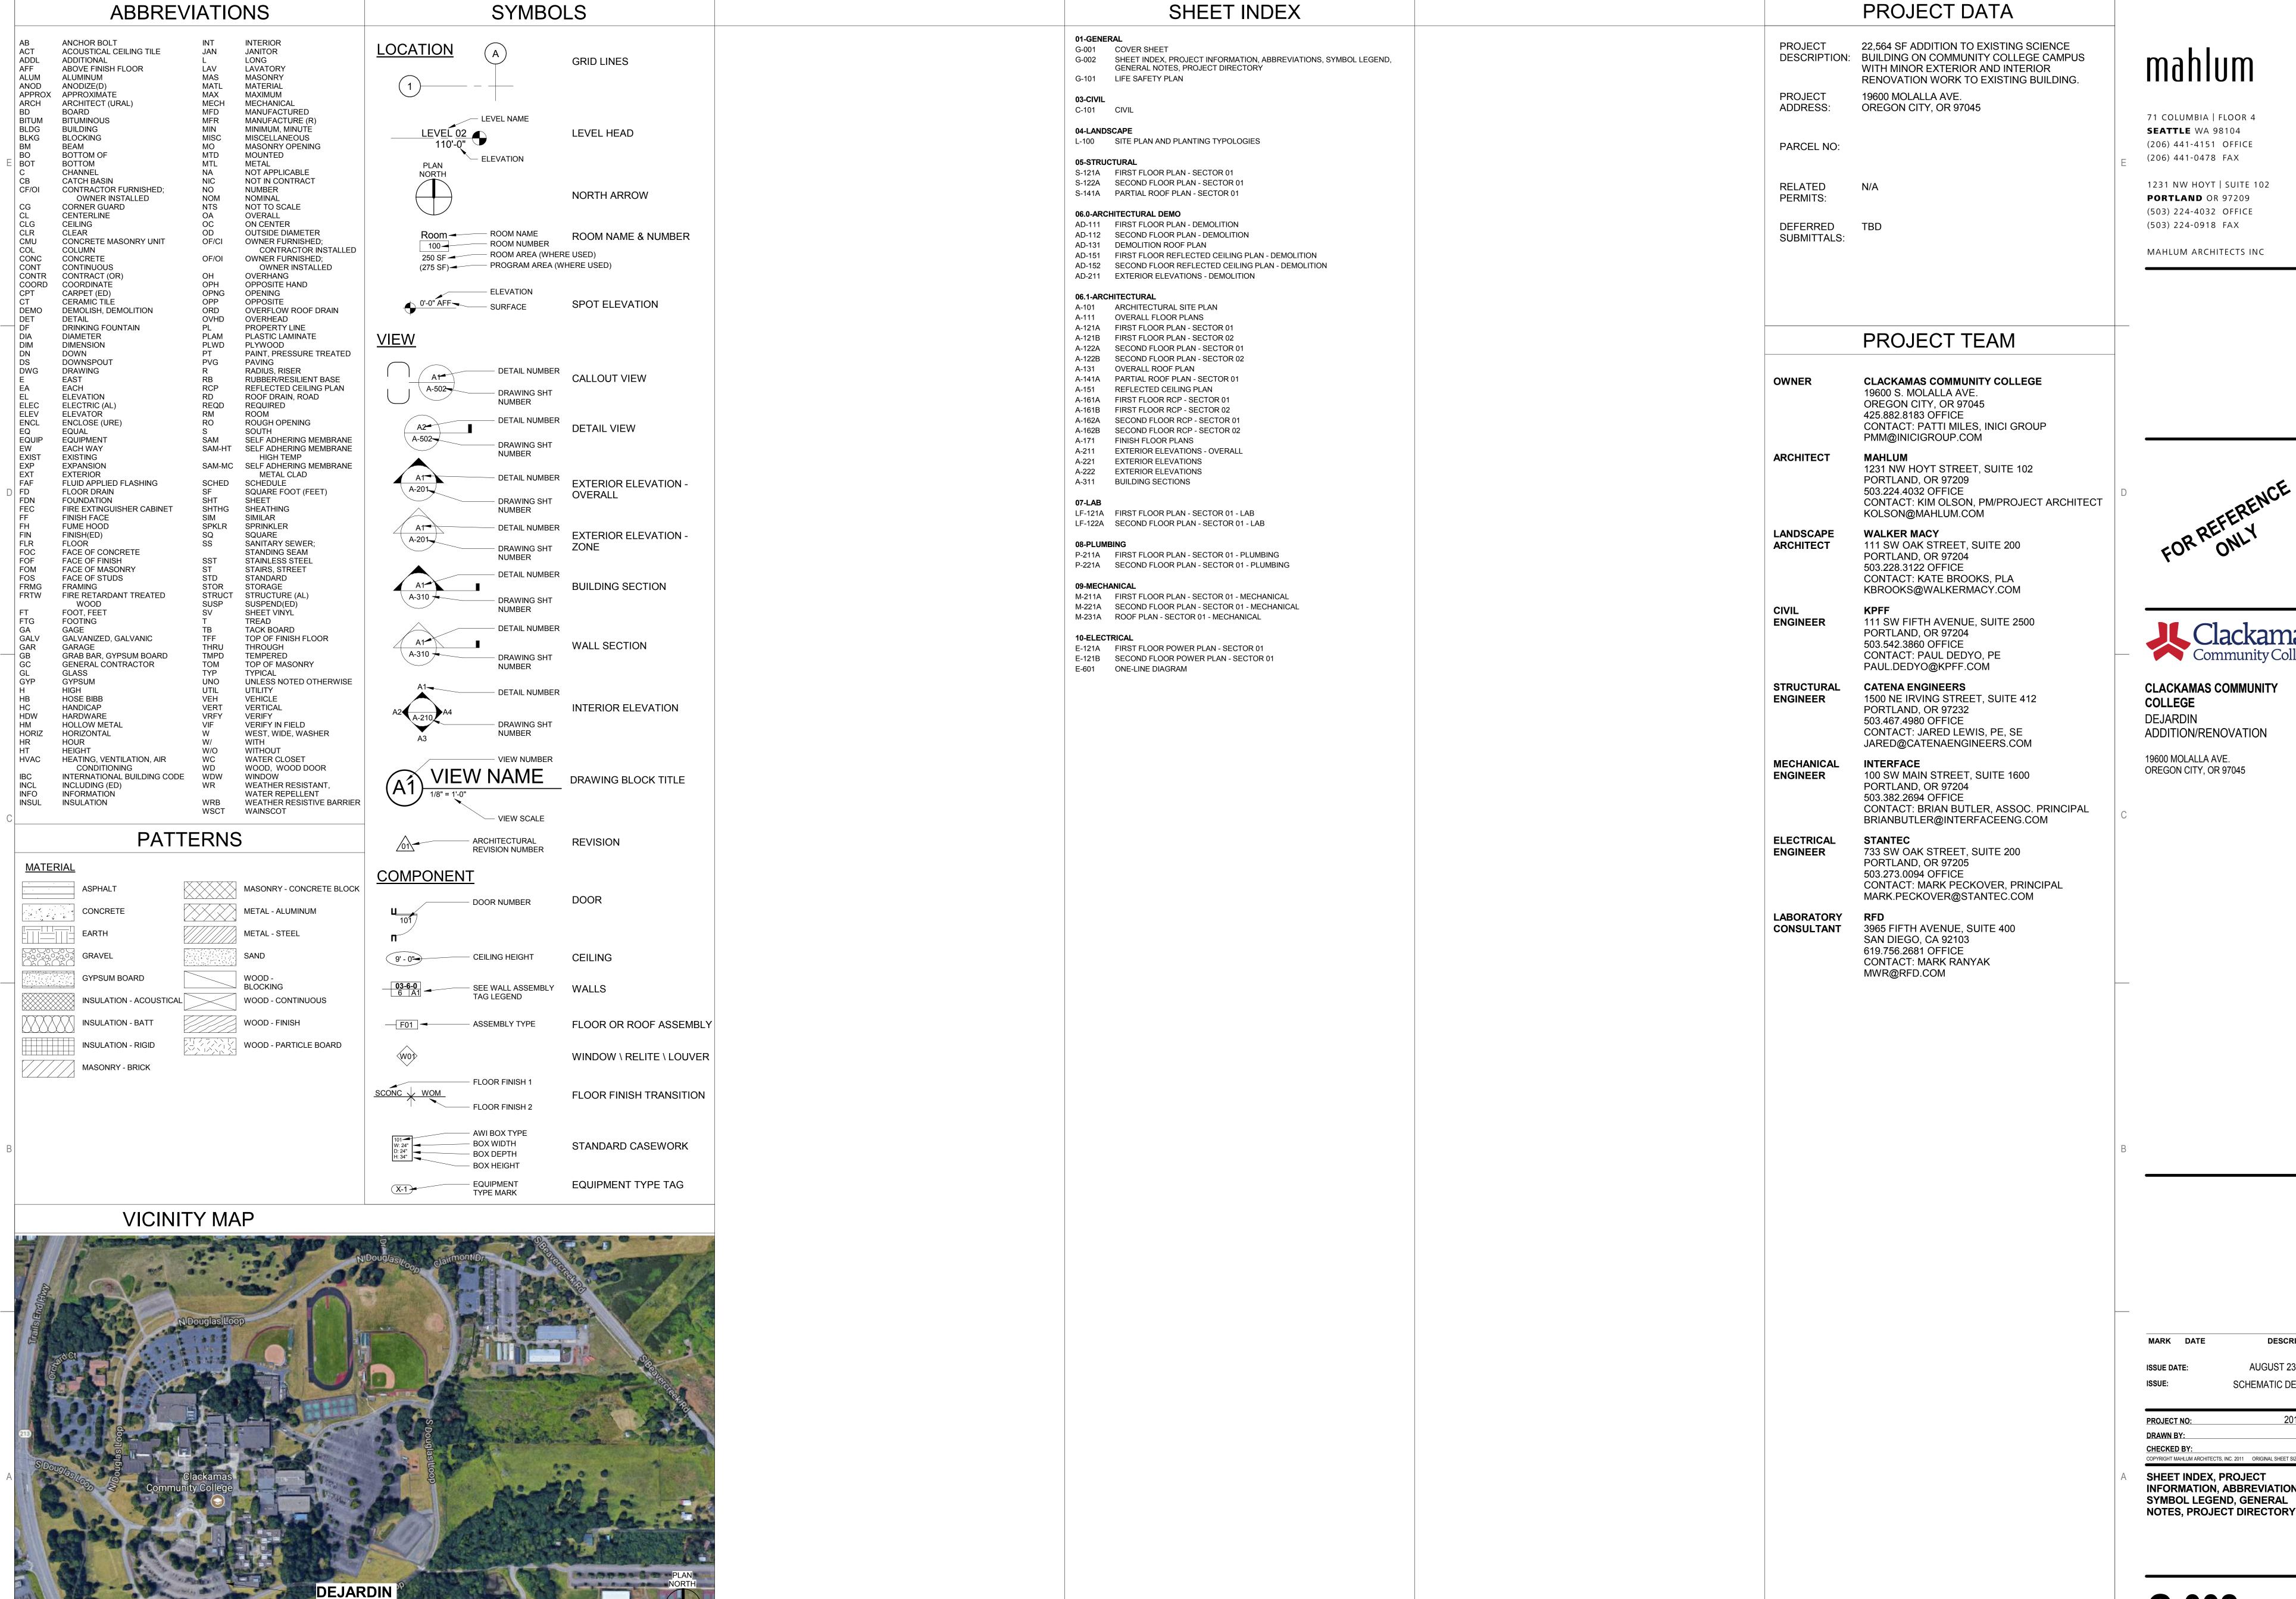

ADDITION &

RENOVATION

71 COLUMBIA | FLOOR 4 **SEATTLE** WA 98104 (206) 441-4151 OFFICE (206) 441-0478 FAX

1231 NW HOYT | SUITE 102 PORTLAND OR 97209 (503) 224-4032 OFFICE

MAHLUM ARCHITECTS INC

MARK DATE

AUGUST 23,2017 SCHEMATIC DESIGN

DESCRIPTION

2017401

PROJECT NO: DRAWN BY:

COPYRIGHT MAHLUM ARCHITECTS, INC. 2011 ORIGINAL SHEET SIZE: 30"x42" SHEET INDEX, PROJECT INFORMATION, ABBREVIATIONS, SYMBOL LEGEND, GENERAL

G-002

CODE SUMMARY

REFERENCE CODES

OREGON STRUCTURAL SPECIALTY CODE, 2014 EDITION (BASED ON THE 2009 IBC WITH OREGON AMENDMENTS)

OREGON ENERGY EFFICIENCY SPECIALTY CODE, 2014 EDITION (BASED ON THE 2009 IECC WITH OREGON AMENDMENTS)

OREGON PLUMBING SPECIALTY CODE, 2014 EDITION (BASED ON THE 2009 UPC WITH OREGON AMENDMENTS)

OREGON ELECTRICAL SPECIALTY CODE, 2014 EDITION (BASED ON THE 2014 EDITION OF THE NFPA 70 NATIONAL ELECTRICAL CODE)

OREGON ELEVATOR SPECIALTY CODE, 2011 EDITION OREGON FIRE CODE, 2014 EDITION

(BASED ON THE 2012 INTERNATIONAL FIRE CODE)

GENERAL REFERENCES:

ICC/ANSI A117.1-2009 ACCESSIBLE AND USABLE BUILDINGS AND FACILITIES AMERICAN NATIONAL STANDARD, 2009 EDITION

NATIONAL FIRE PROTECTION ASSOCIATION STANDARDS REFERENCED IN OREGON STATE STATUES AND REGULATIONS

DEFERRED SUBMITTALS

PER OSSC SECTION 107.3.4.2, THE FOLLOWING ITEMS HAVE BEEN IDENTIFIED AS DEFERRED SUBMITTALS FOR THIS PROJECT:

- 1. FALL ARREST/SAFETY RESTRAINT SYSTEM 2. CURTAIN WALL, WINDOW WALL, AND OTHER GLAZING SYSTEMS
- SKYLIGHTS 4. MECHANICAL, ELECTRICAL, PLUMBING AND LAB EQUIPMENT ANCHORAGE AND
- BRACING, INCLUDING SEISMIC. 5. SPECIALTY CEILINGS AND SUSPENDED CEILING DESIGN 6. FIRE SPRINKLER SYSTEM
- 7. TEMPERATURE CONTROL OR BUILDING ENERGY MANAGEMENT SYSTEMS 8. FIRE ALARM SYSTEM
- 9. ELECTRONIC SECURITY SYSTEM 10. LIGHTING CONTROL 11. FIRE STOPPING

ZONING

THE FOLLOWING SUMMARIZES A PRELIMINARY REVIEW OF THE PROJECT CRITERIA FOR ZONING, BASED ON THE OREGON CITY TITLE XVII OF THE MUNICIPAL CODE.

PROJECT ADDRESS 19600 SOUTH MOLALLA AVENUE, OREGON CITY, OREGON 97045

NORTH OF SOUTH DOUGLAS LOOP, WEST OF DEJARDIN HALL, SOUTH OF ROOK HALL

ZONE DESIGNATION - INSTITUTIONAL DISTRICT

MAXIMUM BUILDING HEIGHT SECTION 17.39.050-A:

WITHIN 100 FEET OF A DISTRICT BOUNDARY = 35 FEET ELSEWHERE: 70 FEET

DEJARDIN ADDITION IS GREATER THAN 100 FEET OF A DISTRICT BOUNDARY. MAXIMUM BUILDING HEIGHT PER ZONING = 70 FEET.

MECHANICAL

MAXIMUM BUILDING AREA

MINIMUM BUILDING SETBACKS

PUBLIC RIGHT OF WAY = 0 FEET MINIMUM/5 FEET MAXIMUM PRIVATE PROPERTY LINES = 25 FEET

PARKING REQUIREMENTS

CONFIRM TO EXISTING CAMPUS WIDE PARKING PLAN

OREGON ENERGY EFFICIENCY CODE

SECTION 502: BUILDING ENVELOPE REQUIREMENTS

INSULATION AND FENESTRATION CRITERIA
THE BUILDING THERMAL ENVELOPE OPAQUE ASSEMBLIES SHALL MEET THE REQUIREMENTS OF TABLE 502.1.1 AND SECTION 502.2. FENESTRATION SHALL MEET THE REQUIREMENTS OF SECTION

BUILDING ENVELOPE REQUIREMENTS: OPAQUE ASSEMBLIES

ROOFS
INSULATION ENTIRELY ABOVE DECK
R-20ci

WALLS, ABOVE GRADE METAL FRAMED R-13 + R-7.5ci

SLAB-ON-GRADE FLOORS No Requirement HEATED SLABS R-15 for 24 inches below

BUILDING ENVELOPE REQUIREMENTS: FENESTRATION

VERTICAL FENESTRATION 30% MAXIMUM OF ABOVE-GRADE WALL

SHGC - ALL FRAME TYPES

FENESTRATION TYPE U-FACTOR METAL FRAMED, WITH OR WITHOUT THERMAL BREAK: FIXED: INCLUDING CURTAIN WALL / STOREFRONT ENTRANCE DOORS ALL OTHER

FIRE AND LIFE SAFETY

CHAPTER 3: USE & OCCUPANCY CLASSIFICATION

SECTION 302: CLASSIFICATION STRUCTURES OR PORTIONS OF STRUCTURES SHALL BE CLASSIFIED WITH RESPECT TO OCCUPANCY IN

SECTION 304: BUSINESS GROUP B

ONE OR MORE OF THE GROUPS LISTED IN THIS SECTION.

EDUCATIONAL OCCUPANCIES FOR STUDENTS ABOVE THE 12TH GRADE

CHAPTER 5: GENERAL BUILDING HEIGHTS AND AREAS

SECTION 503: GENERAL THE BUILDING HEIGHT AND AREA SHALL NOT EXCEED THE LIMITS SPECIFIED IN TABLE 503 BASED ON THE TYPE OF CONSTRUCTION AS DETERMINED BY SECTION 602 AND THE OCCUPANCIES AND THE OCCUPANCIES AS DETERMINED BY SECTION 302 EXCEPT AS MODIFIED HEREAFTER

BUILDING OCCUPANCY PER CHAPTER 3: CONSTRUCTION TYPE PER CHAPTER 6:

PER TABLE 503:

ALLOWABLE BUILDING HEIGHT: ALLOWABLE STORIES: ALLOWABLE AREA PER STORY:

SECTION 504: BUILDING HEIGHT

THE BUILDING HEIGHT PERMITTED BY TABLE 503 SHALL BE INCREASED IN ACCORDANCE WITH SECTIONS

9,000 SQUARE FEET

41'-0" @ EXISTING = OK

WHERE A BUILDING IS EQUIPPED THROUGHOUT WITH AN APPROVED AUTOMATIC SPRINKLER SYSTEM IN ACCORDANCE WITH 903.3.1.1, THE VALUE SPECIFIED IN TABLE 503 FOR MAXIMUM BUILDING HEIGHT IS

INCREASED BY 20 FEET AND THE MAXIMUM NUMBER OF STORIES IS INCREASED BY ONE. THIS BUILDING TO HAVE AUTOMATIC SPRINKLER SYSTEM IN ACCORDANCE WITH 903.3.1.1

ALLOWABLE BUILDING HEIGHT FOR DEJARDIN: 60'-0 ALLOWABLE STORIES FOR DEJARDIN:

ACTUAL HEIGHT FOR DEJARDIN:

32'-8" @ NEW = OK **ACTUAL STORIES FOR DEJARDIN:**

FIRE AND LIFE SAFETY (CONTINUED)

SECTION 506: BUILDING AREA MODIFICATIONS

THE BUILDING AREAS LIMITED BY TABLE 503 SHALL BE PERMITTED TO BE INCREASED DUE TO FRONTAGE AND AUTOMATIC SRPINKLER SYSTEM PROTECTION IN ACCORDANCE WITH EQUATION 5-1:

 $Aa = \{At + [At x | f] + [At x | s]\} WHERE:$

Aa = ALLOWABLE BUILDING AREA PER STORY (SF)

At = TABULAR BUILDING AREA PER STORY IN ACCORDANCE WITH TABLE 503

AREA INCREASE FACTOR DUE TO FRONTAGE AS CALCULATED IN ACCORDANCE WITH SECTION 506.2

AREA INCREASE DUE TO SPRINKLER PROTECTION AS CALCULATED IN ACCORDANCE WITH 506.3

506.2 FRONTAGE INCREASE

If = [F/P - 0.25]W/30 WHERE:

If = AREA INCREASE DUE TO FRONTAGE

F = BUILDING HAVING PERIMETER THAT FRONTS ON A PUBLIC WAY OR OPEN SPACE HAVING 20 FEET OPEN MINIMUM WIDTH.

P = PERIMETER OF ENTIRE BUILDING

W = WIDTH OF PUBLIC WAY OR OPEN SPACE (FEET) IN ACCORDANCE WITH SECTION 506.2.1

DEJARDIN: If = [936/936 - 0.25]30/30 = .75

506.3 AUTOMATIC SPRINKLER SYSTEM INCREASE
WHERE A BUILDING IS EQUIPPED THROUGHOUT WITH AN APPROVED AUTOMATIC SPRINKLR SYSTEM IN ACCORDANCE WITH 903.3.1.1, THE BUILDING AREA LIMITATION IN TABLE 503 IS PERMITTED TO BE INCREASED BY AN ADDITIONAL 200 PERCENT (Is = 2) FOR BUILDINGS WITH MORE THAN ONE STORY ABOVE GRADE PLANE.

DEJARDIN CALCULATION: BUILDING IS FULLY SPRINKLERED: Is = 2

FULL DEJARDIN CALCULATION:

 $Aa = \{9,000 + [9,000 \times .75] + [9,000 \times 2]\}$

Aa = 9,000 + [6,750] + [18,000] = 33,750 SF ACTUAL AREA FOR DEJARDIN AT LARGEST FLOOR = 20,827

20,827 < 33,750 = OK

CHAPTER 6: TYPES OF CONSTRUCTION

SECTION 602: CONSTRUCTION CLASSIFICATION BUILDINGS AND STRUCTURE ERECTED OR TO BE ERECTED, ALTERED, OR EXTENDED IN HEIGHT OR AREA SHALL BE CLASSIFIED IN ONE OF THE FIVE CONSTRUCTION TYPES DEFINED IN SECTIONS 602.2 THROUGH 602.5. THE BUILDING ELEMENTS SHALL HAVE A FIRE RESISTANCE RATING NOT LESS THAN THAT SPECIFIED IN TABLE 602. WHERE REQUIRED TO HAVE A FIRE RESISTANCE RATING BY TABLE 601, BUILDING ELEMENTS SHALL COMPLY WITH THE APPLICABLE PROVISIONS OF SECTION 703.2.

602.5
TYPE V CONSTRUCTION IS THAT TYPE OF CONSTRUCTION IN WHICH THE STRUCTURAL ELEMENTS, EXTERIOR WALLS, AND INTERIOR WALLS ARE OF ANY MATERIALS PERMITTED BY THIS CODE.

TABLE 601: REQUIRED FIRE RESISTANCE RATING BUILDING ELEMENT

STRUCTURAL FRAME BEARING WALLS INTERIOR

EXTERIOR NONBEARING WALLS AND PARTITIONS INTERIOR

FLOOR CONSTRUCTION

TABLE 602: REQUIRED FIRE RESISTANCE RATING FOR EXTERIOR WALLS WHERE FIRE SEPARATION DISTANCE IS GREATER OR EQUAL TO 30 FEET, FIRE RESISTANCE IS NOT REQUIRED FOR

CHAPTER 8: INTERIOR FINISHES

TABLE 803.9: INTERIOR WALL AND CEILING FINISH REQUIREMENTS BY OCCUPANCY (SPRINKLERED)

INTERIOR EXIT STAIRWAYS, INTERIOR EXIT RAMPS, AND EXIT PASSAGE WAYS: CORRIDORS AND ENCLOSURE FOR EXIT ACCESS STAIRWAYS AND RAMPS: ROOMS AND ENCLOSED SPACES:

CHAPTER 10: MEANS OF EGRESS

SECTION 1004: OCCUPANT LOAD

1004.1 DESIGN OCCUPANT LOAD
IN DETERMINING MEANS OF EGRESS REQUIREMENTS, THE NUMBER OF OCCUPANTS FOR WHOM MEANS OF EGRESS FACILITIES SHALL BE PROVIDED SHALL BE DETERMINED IN ACCORDANCE WITH THIS SECTION.

TABLE 1004.1.2 MAXIMUM FLOOR AREA ALLOWANCES PER OCCUPANT

ACCESSORY STORAGE AREAS MECHANICAL EQUIPMENT ROOM

ASSEMBLY WITHOUT FIXED SEATS 15 NET UNCONCENTRATED **BUSINESS AREAS** 100 GROSS

50 NET **VOCATIONAL AREAS CLASSROOM AREAS** 20 NET

SECTION 1005: MEANS OF EGRESS SIZING

ALL PORTIONS OF THE MEANS OF EGRESS SYSTEM SHALL BE SIZED IN ACCORDANCE WITH THIS SECTION.

1005.3.1 STAIRWAYS
THE CAPACITY, IN INCHES, OF MEANS OF EGRESS STAIRWAYS SHALL BE CALCULATED BY MULTIPLYING THE OCCUPANT LOAD SERVED BY SUCH STAIRWAY BY A MEANS OF EGRESS CAPACITY FACTOR OF 0.3 INCHES PER

EXCEPTION: FOR OTHER THAN GROUP H AND I-2 OCCUPANCIES, THE CAPACITY, IN INCHES, OF MEANS OF EGRESS STAIRWAYS SHALL BE CALCULATED BY MULTIPLYING THE OCCUPANT LOAD SERVED BY SUCH STAIRWAY BY A MEANS OF EGRESS CAPACITY FACTOR OF 0.2 INCH PER OCCUPANT IN BUILDINGS EQUIPPED THROUGHOUT WITH AN AUTOMATIC SPRINKLER SYSTEM AND AN EMERGENCY VOICE/ALARM COMMUNICATION

1005.3.2 OTHER EGRESS COMPONENTS
THE CAPACITY, IN INCHES, OF MEANS OF EGRESS COMPONENTS OTHER THAN STAIRWAYS SHALL BE SHALL BE CALCULATED BY MULTIPLYING THE OCCUPANT LOAD SERVED BY SUCH COMPONENT BY A MEANS OF EGRESS CAPACITY FACTOR OF 0.2 INCHES.

EXCEPTION: FOR OTHER THAN H AND I-2 OCCUPANCIES, THE CAPACITY IN INCHES OF MEANS OF EGRESS COMPONENTS OTHER THAN STAIRWAYS SHALL BE CALCULATED BY MULTIPLYING THE OCCUPANT LOAD SERVED BY SUCH COMPONENT BY A MEANS OF EGRESS WITH AN AUTOMATIC SPRINKLER SYSTEM AND AN EMERGENCY VOICE/ALARM COMMUNICATION SYSTEM.

SECTION 1009: STAIRWAYS 1009.3 EXIT ACCESS STAIRWAYS

SECTION 1014: EXIT ACCESS

DISTANCES IN TABLE 1014.3.

FLOOR OPENINGS BETWEEN STORIES CREATED BY EXIT ACCESS STAIRWAYS SHALL BE ENCLOSED. EXCEPTION 1: IN OTHER THAN GROUP I-2 AND I-3 OCCUPANCIES, EXIT ACCESS STAIRWAYS THAT SERVE, OR ATMOSPHERICALLY COMMUNICATE BETWEEN ONLY TWO STORIES ARE NOT REQUIRED TO BE ENCLOSED.

1014.3 COMMON PATH OF EGRESS TRAVEL THE COMMON PATH OF EGRESS TRAVEL SHALL NOT EXCEED THE COMMON PATH OF EGRESS TRAVEL

TABLE 1014.3 COMMON PATH OF EGRESS TRAVEL B OCCUPANCIES IN A FULLY SPRINKLERED BUILDING HAVE A COMMON PATH MAXIMUM OF 100 FEET.

SECTION 1015: EXIT AND EXIT ACCESS DOORWAYS 1015.1 EXITS OR EXIT ACCESS DOORWAYS FROM SPACES

1. THE OCCUPANT LOAD OF THE SPACE EXCEEDS ONE OF THE VALUES IN TABLE 1015.1.

TABLE 1015.1 SPACES WITH ONE EXIT OR EXIT ACCESS DOORWAY OCCUPANCY MAXIMUM OCCUPANT LOAD

WHERE THE TWO EXITS OR EXIT ACCESS DOORWAYS ARE REQUIRED FROM ANY PORTION OF THE EXIT ACCESS, THE EXIT DOORS OR EXIT ACCESS DOORWAYS SHALL BE PLACED A DISTANCE APART EQUAL TO NOT LESS THAN ONE-HALF OF THE LENGTH OF THE MAXIMUM OVERALL DIAGONAL DIMENSION OF THE AREA TO BE SERVED. EXCEPTION: WHERE A BUILDING IS EQUIPPED THROUGHOUT WITH AN AUTOMATIC SPRINKLER SYSTEM IN ACCORDANCE WITH SECTION 903.3.1.1. THE SEPARATION DISTANCE OF THE EXIT DOORS OR EXIT ACCESSSES

DOORWAYS SHALL NOT BE LESS THAN ONE-THIRD OF THE LENGTH OF THE MAXIMUM OVERALL DIAGONAL

DIMENSION OF THE AREA SERVED.

SECTION 1016 EXIT ACCESS TRAVEL DISTANCE EXIT ACCESS TRAVEL DISTANCE SHALL NOT EXCEED THE VALUES GIVEN IN TABLE 1016.2.

TABLE 1016.2 EXIT ACCESS TRAVEL DISTANCE WITH SPRINKLER SYSTEM OCCUPANCY

SECTION 1018: CORRIDORS

BUSINESS

WHERE MORE THAN ONE EXIT OR EXIT ACCESS DOORWAY IS REQUIRED, THE EXIT ACCESS SHALL BE ARRANGED SUCH THAT THERE ARE NO DEAD ENDS IN CORRIDORS MORE THAN 20 FEET IN LENGTH.

EXCEPTION: IN OCCUPANCIES IN GROUPS B, E, F, I-1, M, R-1, R-2, R-4, S, AND U, WHERE THE BUILDING IS EQUIPPED THROUGHOUT WITH AN AUTOMATIC SPRINKLER SYSTEM IN ACCORDANCE WITH SECTION 903.3.1.1 THE LENGTH OF DEAD-END CORRIDORS SHALL NOT EXCEED 50 FEET.

CHAPTER 29: PLUMBING SYSTEMS

ADDITION REQUIRES (MINIMUM):

SECTION 2902 MINIMUM PLUMBING FACILITIES

2902.1 MINIMUM NUMBER OF FIXTURES
PLUMBING FIXTURES SHALL BE PROVIDED FOR THE TYPE OF OCCUPANCY OR USE OF SPACE IN RELATION TO

TABLE 2902.1 MINIMUM NUMBER OF REQUIRED PLUMBING FIXTURES CLASSIFICATION

AND 1 PFR 50 FOR THE

REMAINDER EXCEEDING 50

WATER CLOSETS 1 PER 40 FOR THE FIRST 1 PER 25 FOR THE FIRST 50

DEJARDIN CALCULATION: TOTAL BUILDING OCCUPANTS = 679

680/2 = 340 PER GENDER 8 WCS ARE REQUIRED PER GENDER **6 LAVATORIES ARE REQUIRED PER GENDER**

80 AND 1 PER 80 FOR THE

2 FEMALE

2 MALE

REMAINDER EXCEEDING 80

EXISTING BUILDING INCLUDES: 4 FEMALE 3 MALE + 2 URINALS 4 MALE 1 UNISEX 1 UNISEX

3 MALE + 4 URINALS

LIFE SAFETY PLAN LEGEND

OCCUPANCY

LOAD TAG

REQUIRED


AT STAIRS


NON-STAIR LOCATIONS

EGRESS DISTRIBUTION





WHERE PERMITTED

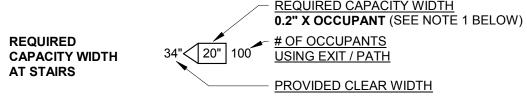

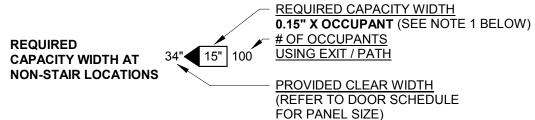

1. BASED ON EGRESS CAPACITY FACTOR EXCEPTION IBC 1005.3.1 WITH AUTOMATIC SPRINKLER SYSTEM (IBC 903.3.1.1 OR 903.3.1.2) AND AN EMERGENCY VOICE/ALARM COMMUNICATION SYSTEM (IBC 907.5.2.2)

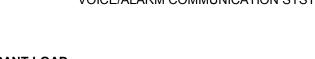

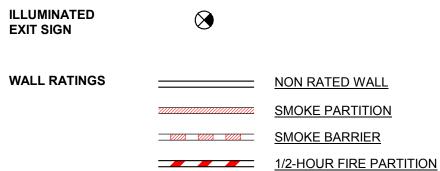

1-HOUR FIRE PARTITION

1-HOUR FIRE BARRIER

MORE NOTES

2-HOUR FIRE BARRIER 3-HOUR FIRE BARRIER RATING VARIES - SEE PLAN FOR

XX' TRAVEL DISTANCE PATH OF **EGRESS**

71 COLUMBIA | FLOOR 4

(206) 441-4151 OFFICE

1231 NW HOYT | SUITE 102

SEATTLE WA 98104

(206) 441-0478 FAX

PORTLAND OR 97209

(503) 224-4032 OFFICE


MAHLUM ARCHITECTS INC


(503) 224-0918 FAX



CLACKAMAS COMMUNITY COLLEGE DEJARDIN ADDITION/RENOVATION


19600 MOLALLA AVE. OREGON CITY, OR 97045

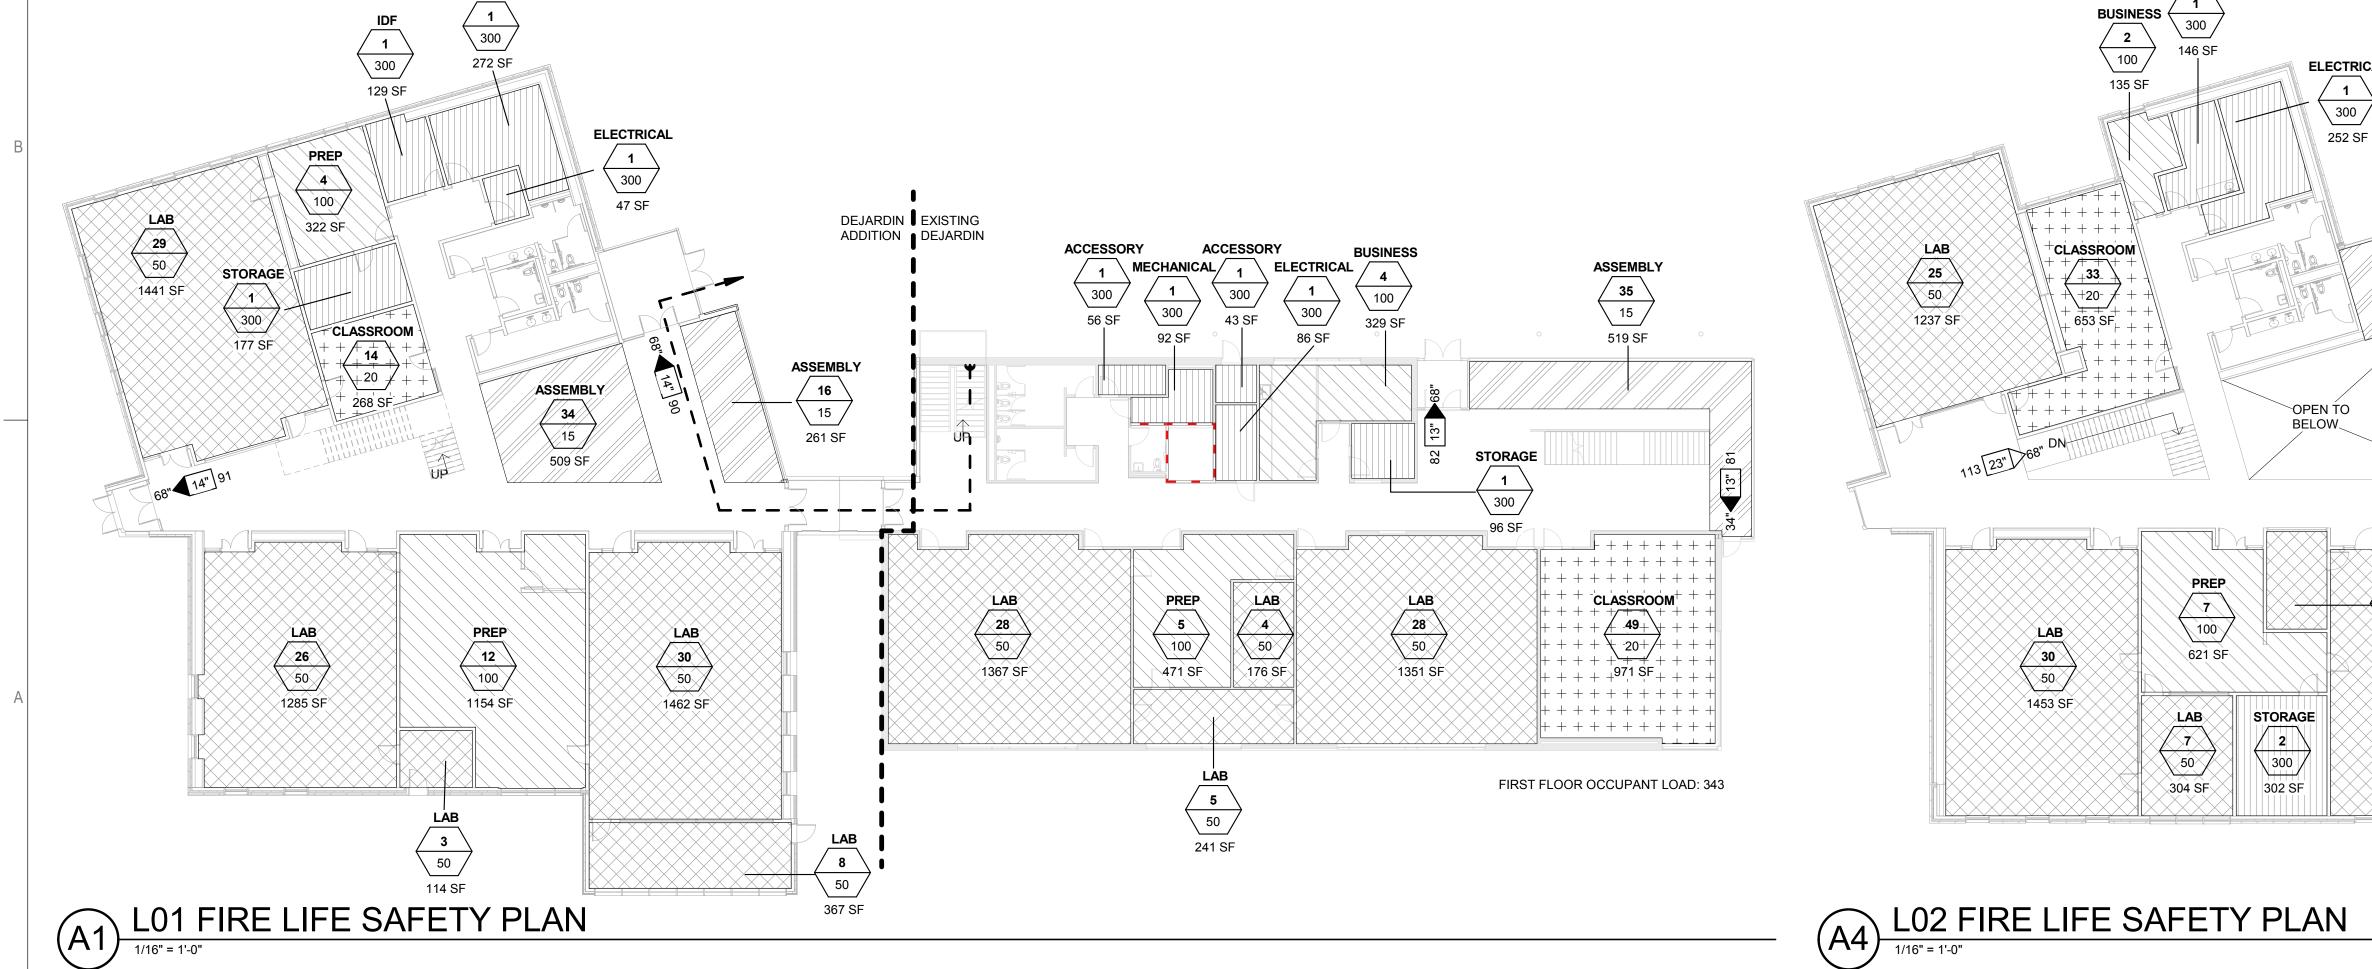

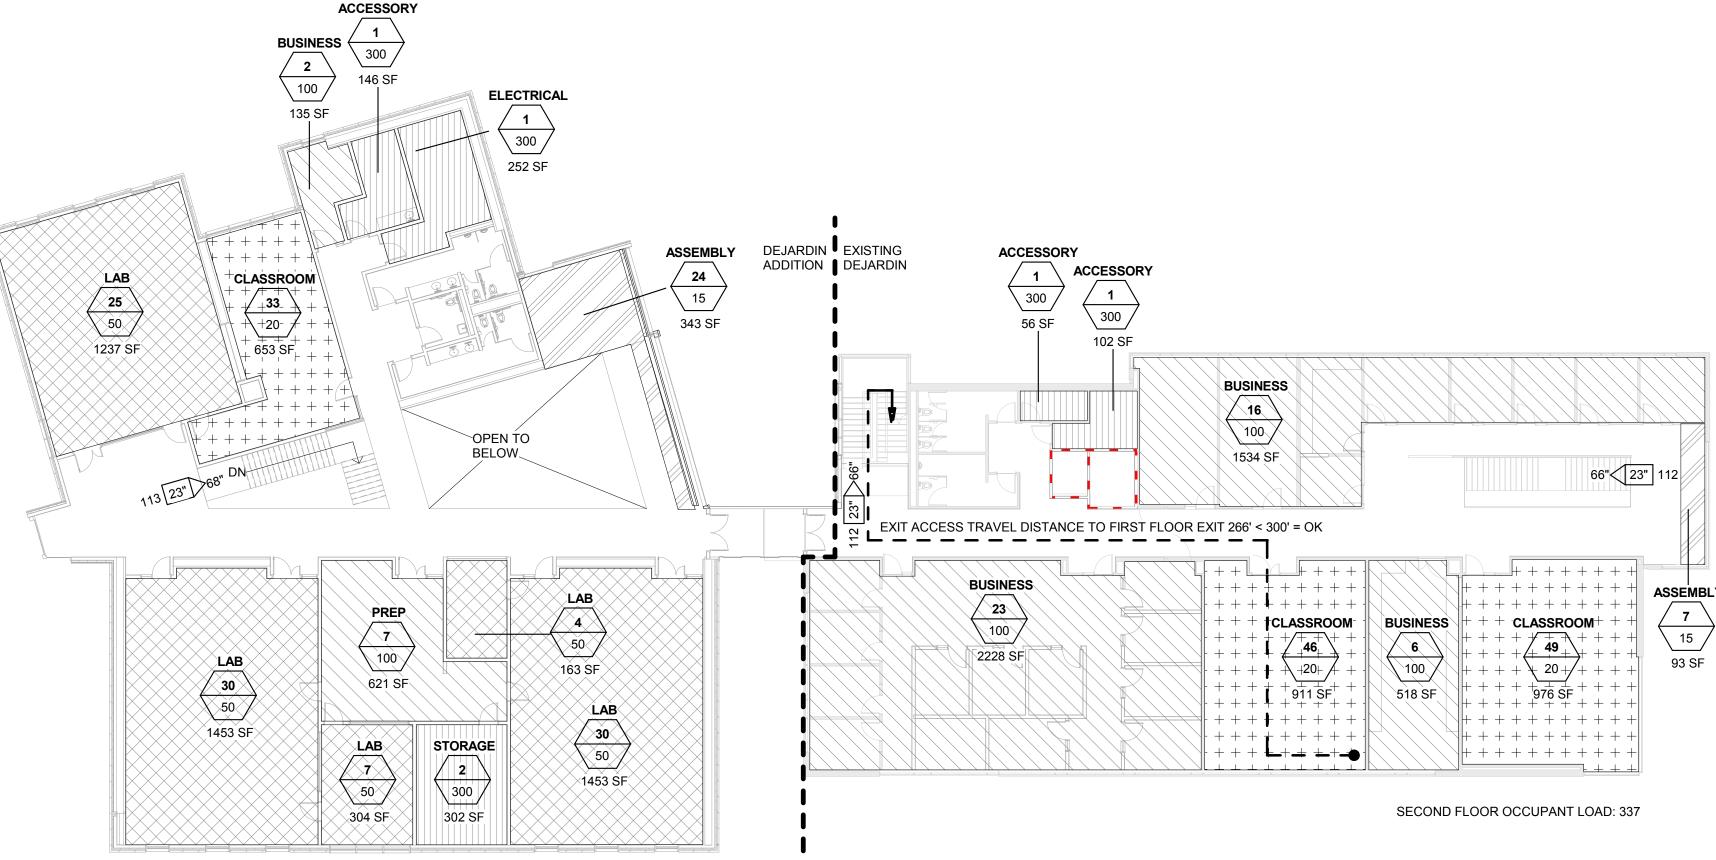



G-101

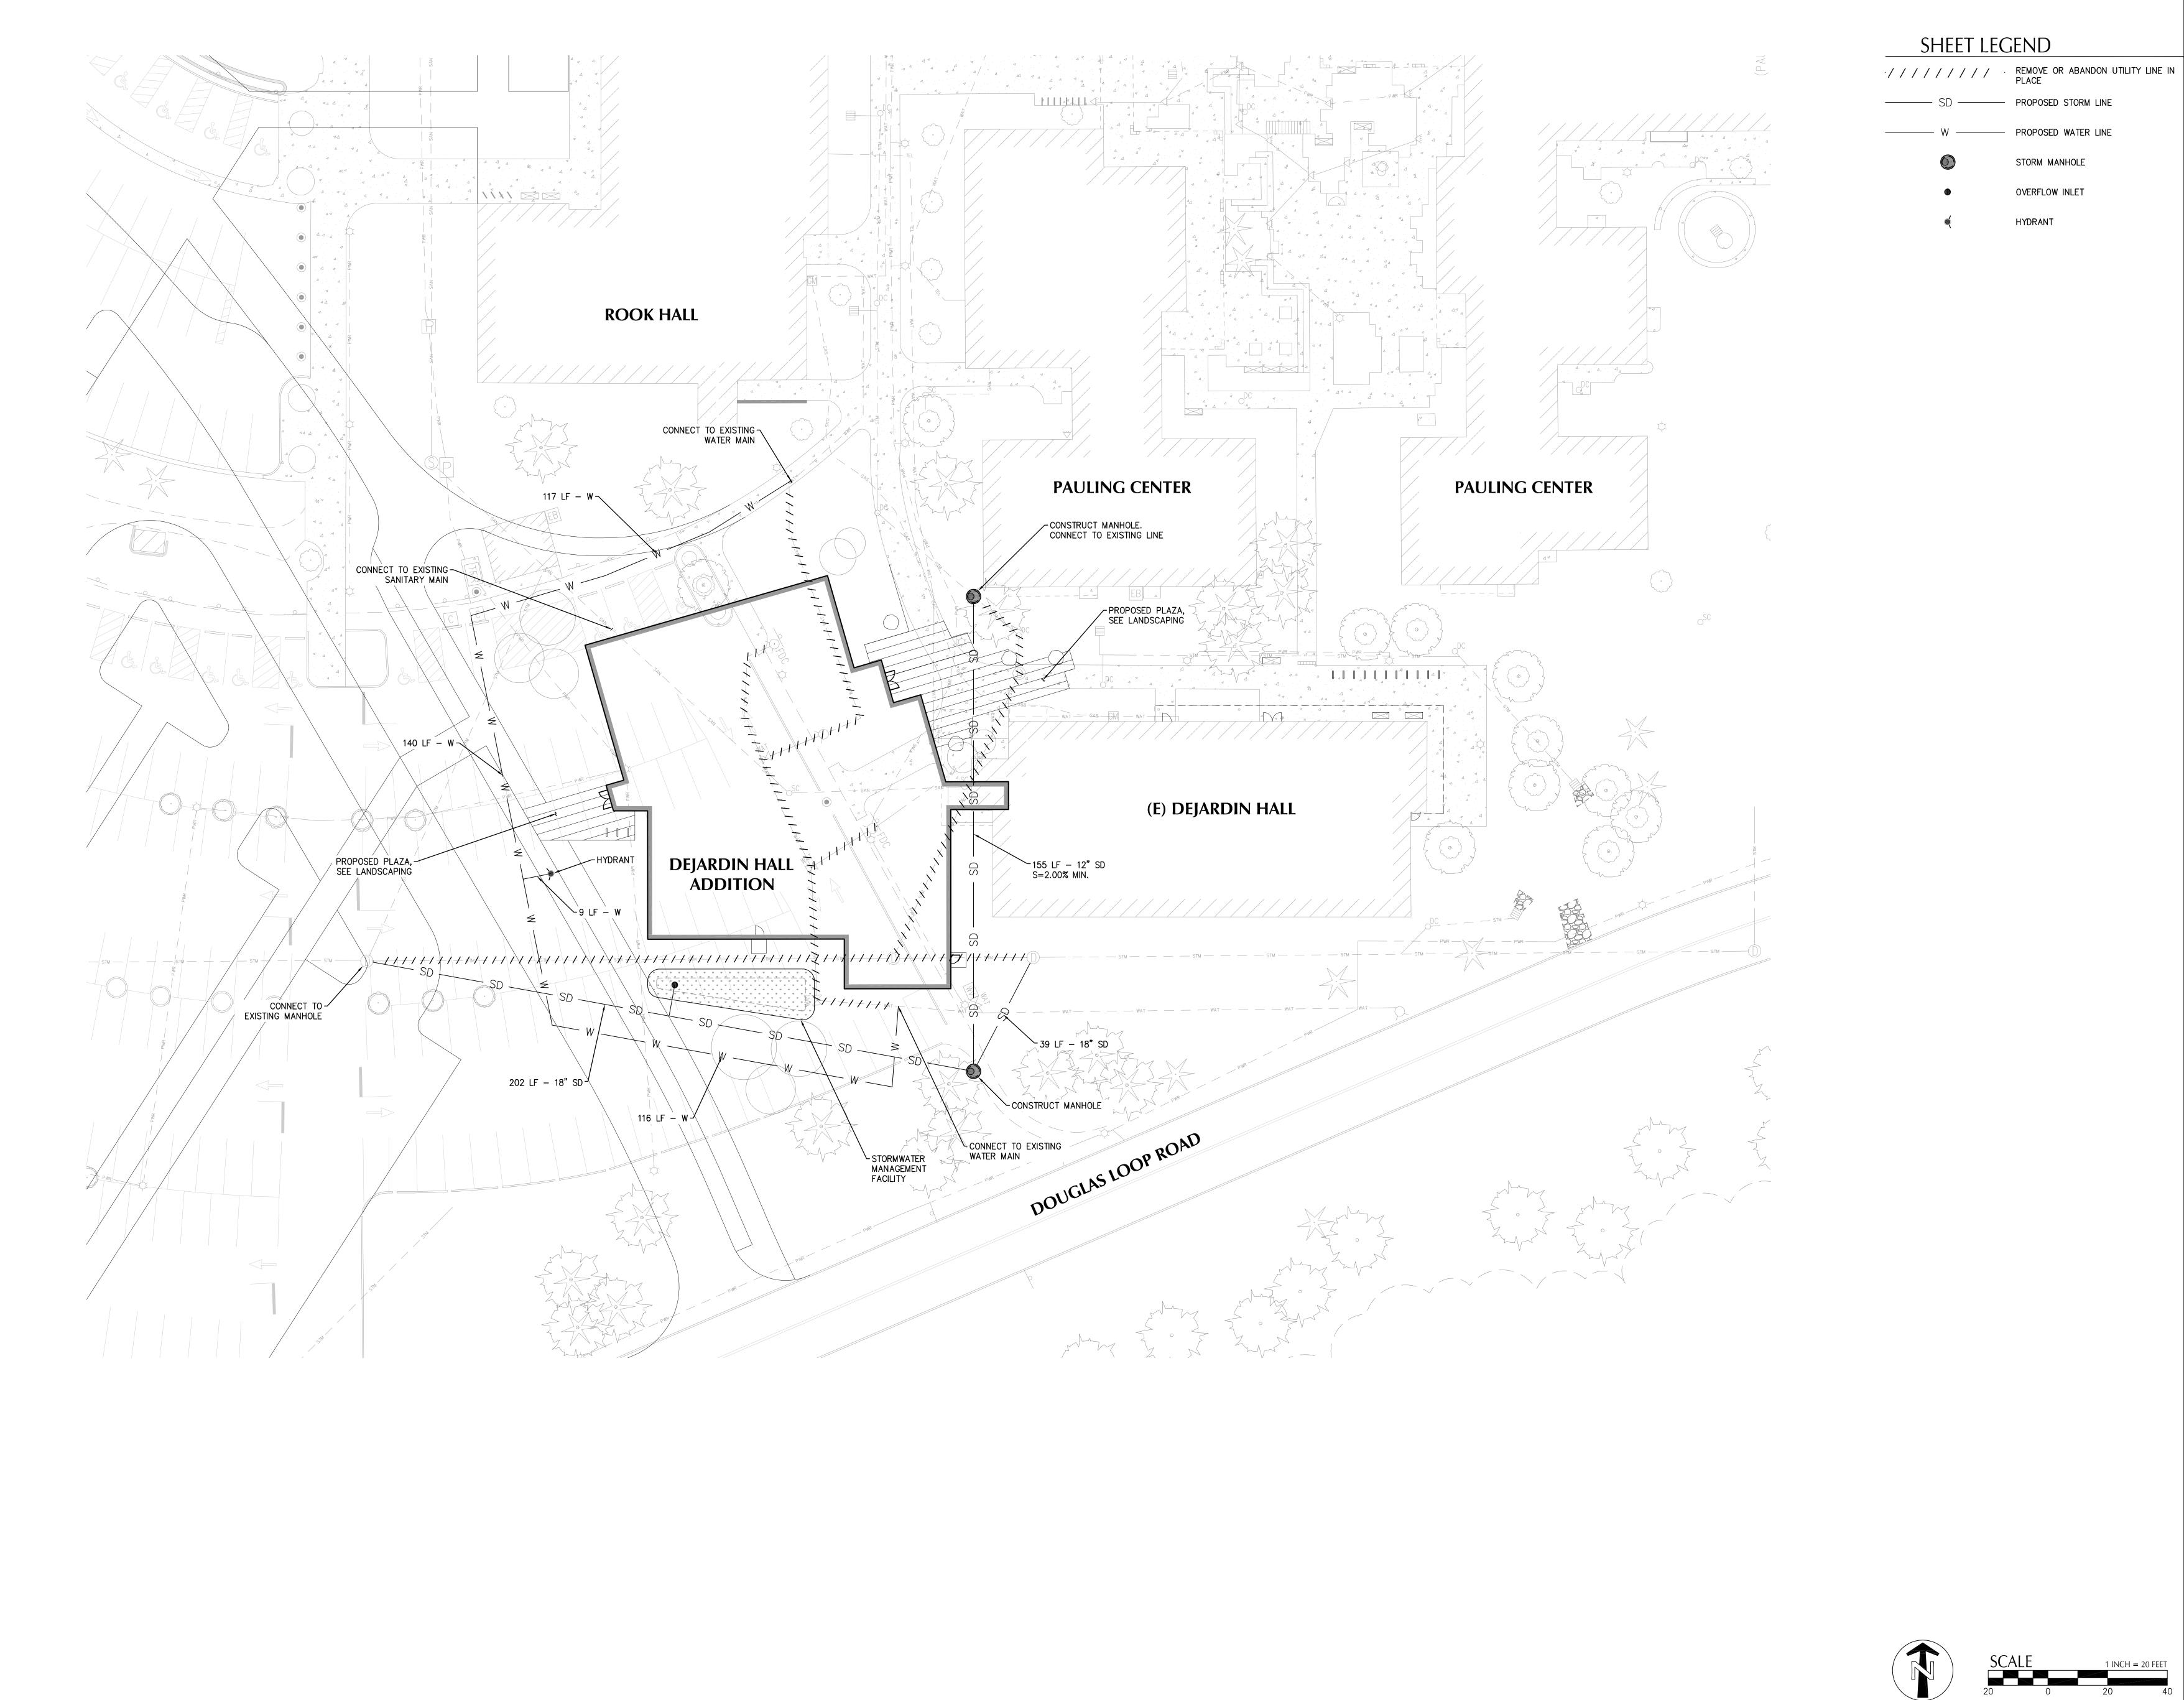

71 COLUMBIA | FLOOR 4 SEATTLE WA 98104

(206) 441-4151 OFFICE

(503) 224-4032 OFFICE (503) 224-0918 FAX

(206) 441-0478 FAX 1231 NW HOYT | SUITE 102 PORTLAND OR 97209

MAHLUM ARCHITECTS INC







CLACKAMAS COMMUNITY COLLEGE DEJARDIN

ADDITION/RENOVATION

19600 MOLALLA AVE. OREGON CITY, OR 97045

SCHEMATIC DESIGN

KPFF COPYRIGHT MAHLUM ARCHITECTS, INC. 2011 ORIGINAL SHEET SIZE: 30"x42"





mahlum

71 COLUMBIA | FLOOR 4 SEATTLE WA 98104 (206) 441-4151 OFFICE

1231 NW HOYT | SUITE 102 PORTLAND OR 97209 (503) 224-4032 OFFICE

WALKER MACY

111 SW OAK, SUITE 200 PORTLAND, OR 97204 503-228-3122



CLACKAMAS COMMUNITY COLLEGE DEJARDIN ADDITION/RENOVATION


19600 MOLALLA AVE. OREGON CITY, OR 97045

DESCRIPTION MARK DATE AUGUST 23,2017 SCHEMATIC DESIGN

PROJECT NO: DRAWN BY: CHECKED BY: KB
COPYRIGHT MAHLUM ARCHITECTS, INC. 2011 ORIGINAL SHEET SIZE: 30"x42"

SITE PLAN AND PLANTING TYPOLOGIES

L-100

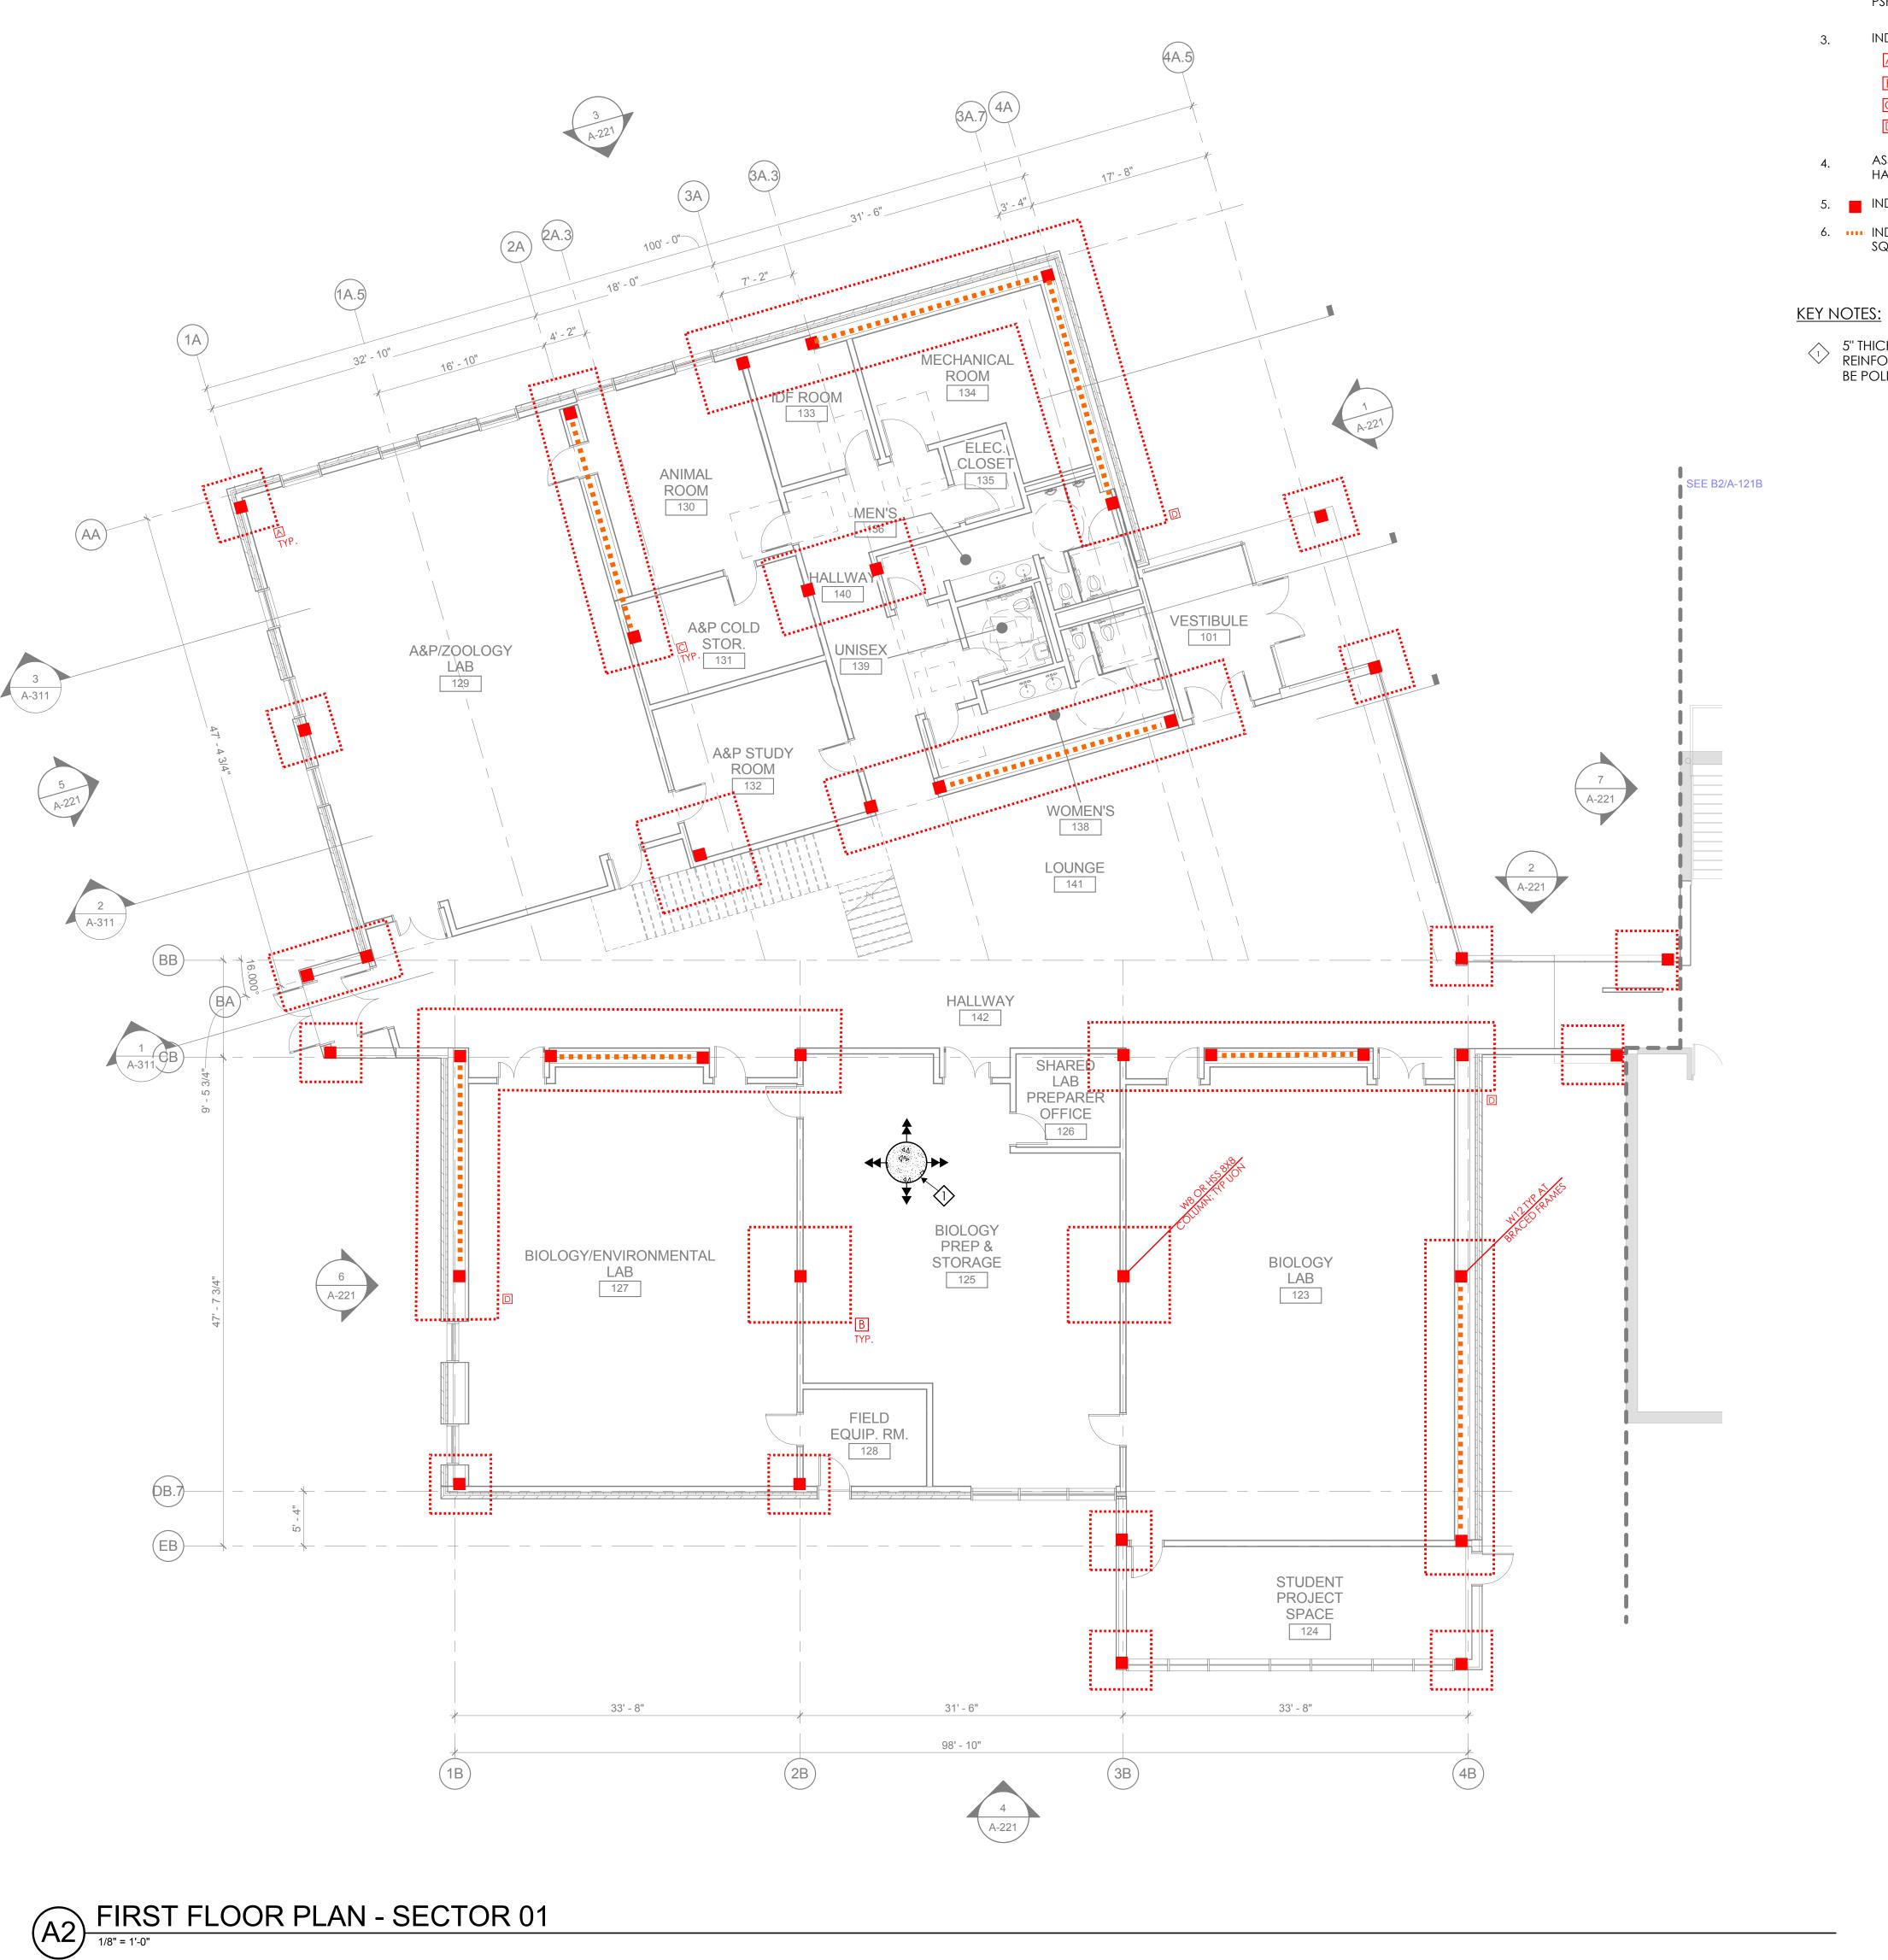

PLAN NOTES:

- REFERENCE THE WRITTEN STRUCTURAL NARRATIVE FOR ADDITIONAL INFORMATION.
- FOOTING SIZES BASED UPON AN ALLOWABLE BEARING PRESSURE FOR D+L OF 3,000 PSF PER SITE-SPECIFIC DRAFT GEOTECHNICAL REPORT BY GRI.
- INDICATES SPREAD OR STRIP FOOTINGS AS FOLLOWS:
 - A 6'-0" x 6'-0" x 2'-0" TYPICAL AT PERIMETER COLUMNS U.O.N. B 10'-0" x 10'-0" x 2'-0" TYPICAL AT INTERIOR COLUMNS U.O.N.
 - 6'-0" WIDE x 2'-0" DEEP TYPICAL AT BRACE FRAMES U.O.N. D 8'-0" WIDE x 2'-0" DEEP
- ASSUME ALL SPREAD FOOTINGS TO HAVE 90 PCY REINF. AND ALL BRACED FRAMES HAVE 175 PCY RENF. w/ $f'c = 4,000 \, PSI$
- 5. INDICATES STEEL WIDE FLANGE OR HSS COLUMN; REF PLAN.
- 6. INDICATES BUCKLING-RESTRAINED BRACED FRAME w/ 4 in^2 CORE AND 10" SQUARE CASING

5" THICK CONCRETE SLAB ON GRADE W/ #4 AT 12"o.c. EACH WAY AT MID-DEPTH. REINFORCING SPACING CAN BE INCREASED TO 16"o.c. WHERE FLOORS WILL NOT BE POLISHED.




71 COLUMBIA | FLOOR 4 SEATTLE WA 98104 (206) 441-4151 OFFICE (206) 441-0478 FAX

1231 NW HOYT | SUITE 102 PORTLAND OR 97209 (503) 224-4032 OFFICE

(503) 224-0918 FAX

MAHLUM ARCHITECTS INC



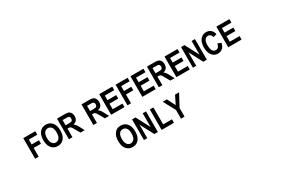




CLACKAMAS COMMUNITY COLLEGE DEJARDIN ADDITION/RENOVATION

(E) 19600 MOLALLA AVE. HALLWAYOREGON CITY, OR 97045

DESCRIPTION AUGUST 23,2017 SCHEMATIC DESIGN

2017401

FIRST FLOOR PLAN - SECTOR 01

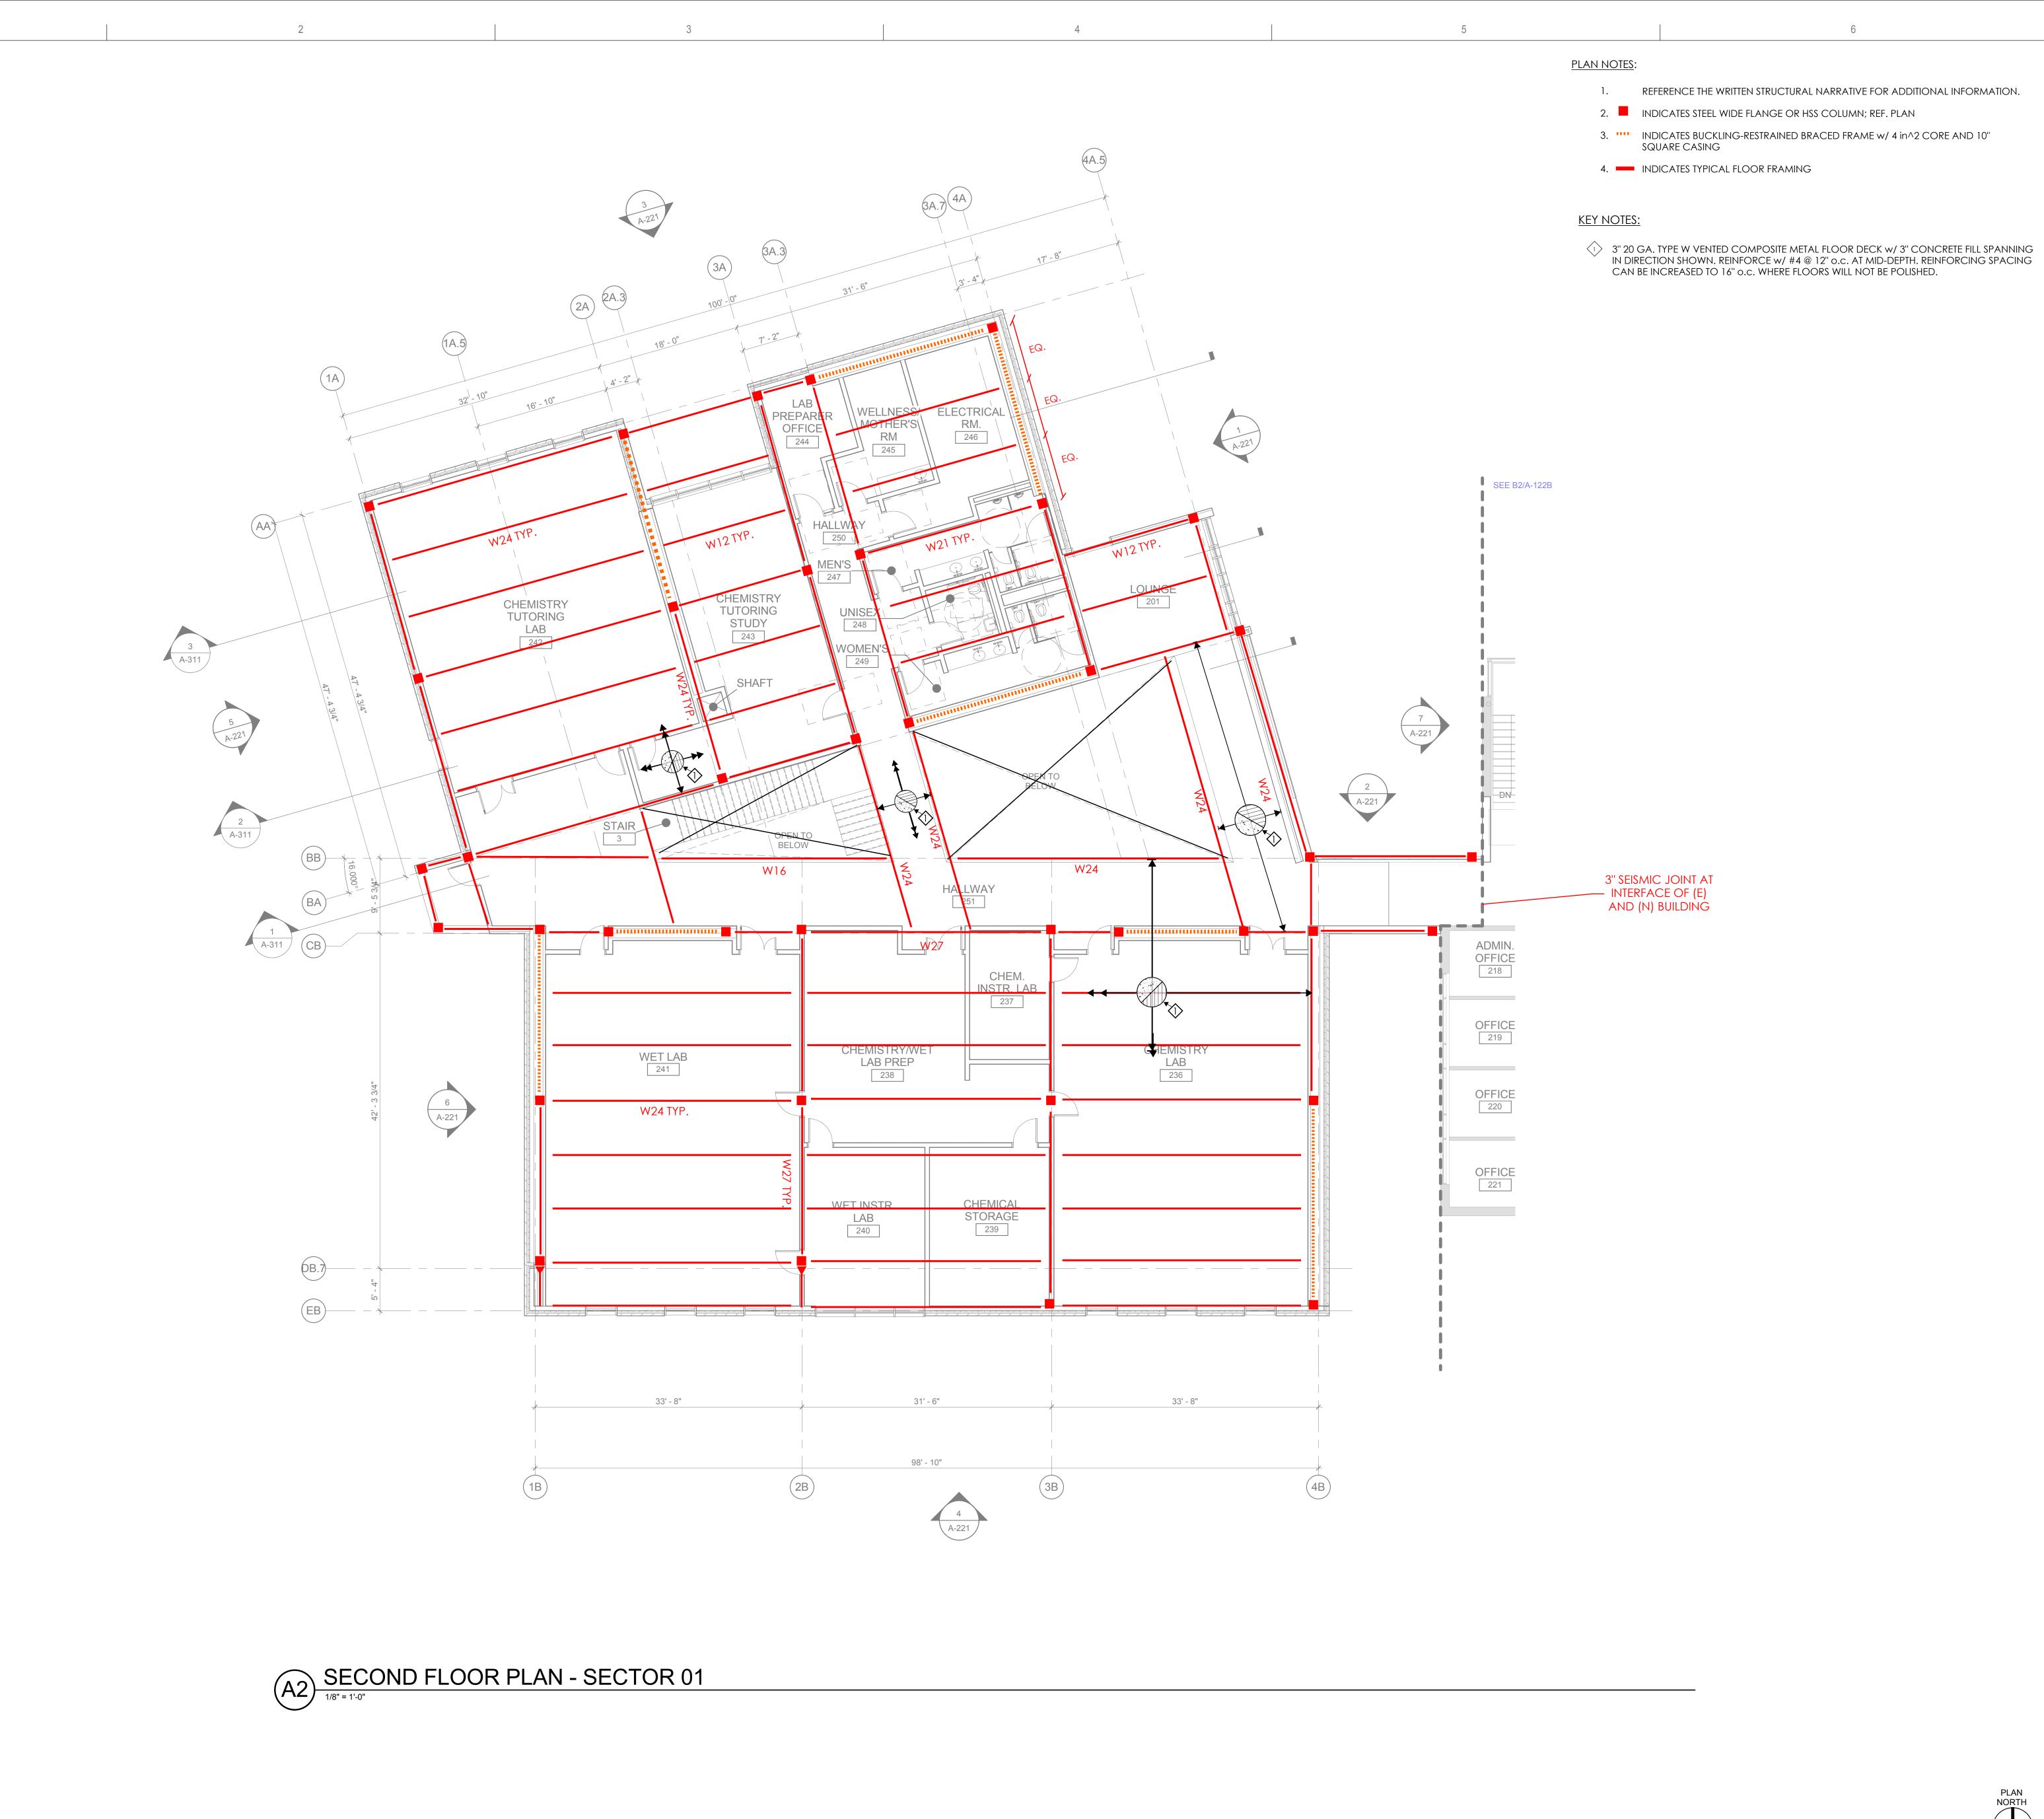



71 COLUMBIA | FLOOR 4 SEATTLE WA 98104

(206) 441-4151 OFFICE

(503) 224-4032 OFFICE

(503) 224-0918 FAX

(206) 441-0478 FAX 1231 NW HOYT | SUITE 102 PORTLAND OR 97209

MAHLUM ARCHITECTS INC







CLACKAMAS COMMUNITY COLLEGE DEJARDIN ADDITION/RENOVATION

19600 MOLALLA AVE. OREGON CITY, OR 97045


DESCRIPTION

AUGUST 23,2017 SCHEMATIC DESIGN

2017401 Checker COPYRIGHT MAHLUM ARCHITECTS, INC. 2011 ORIGINAL SHEET SIZE: 30"x42"

SECOND FLOOR PLAN - SECTOR



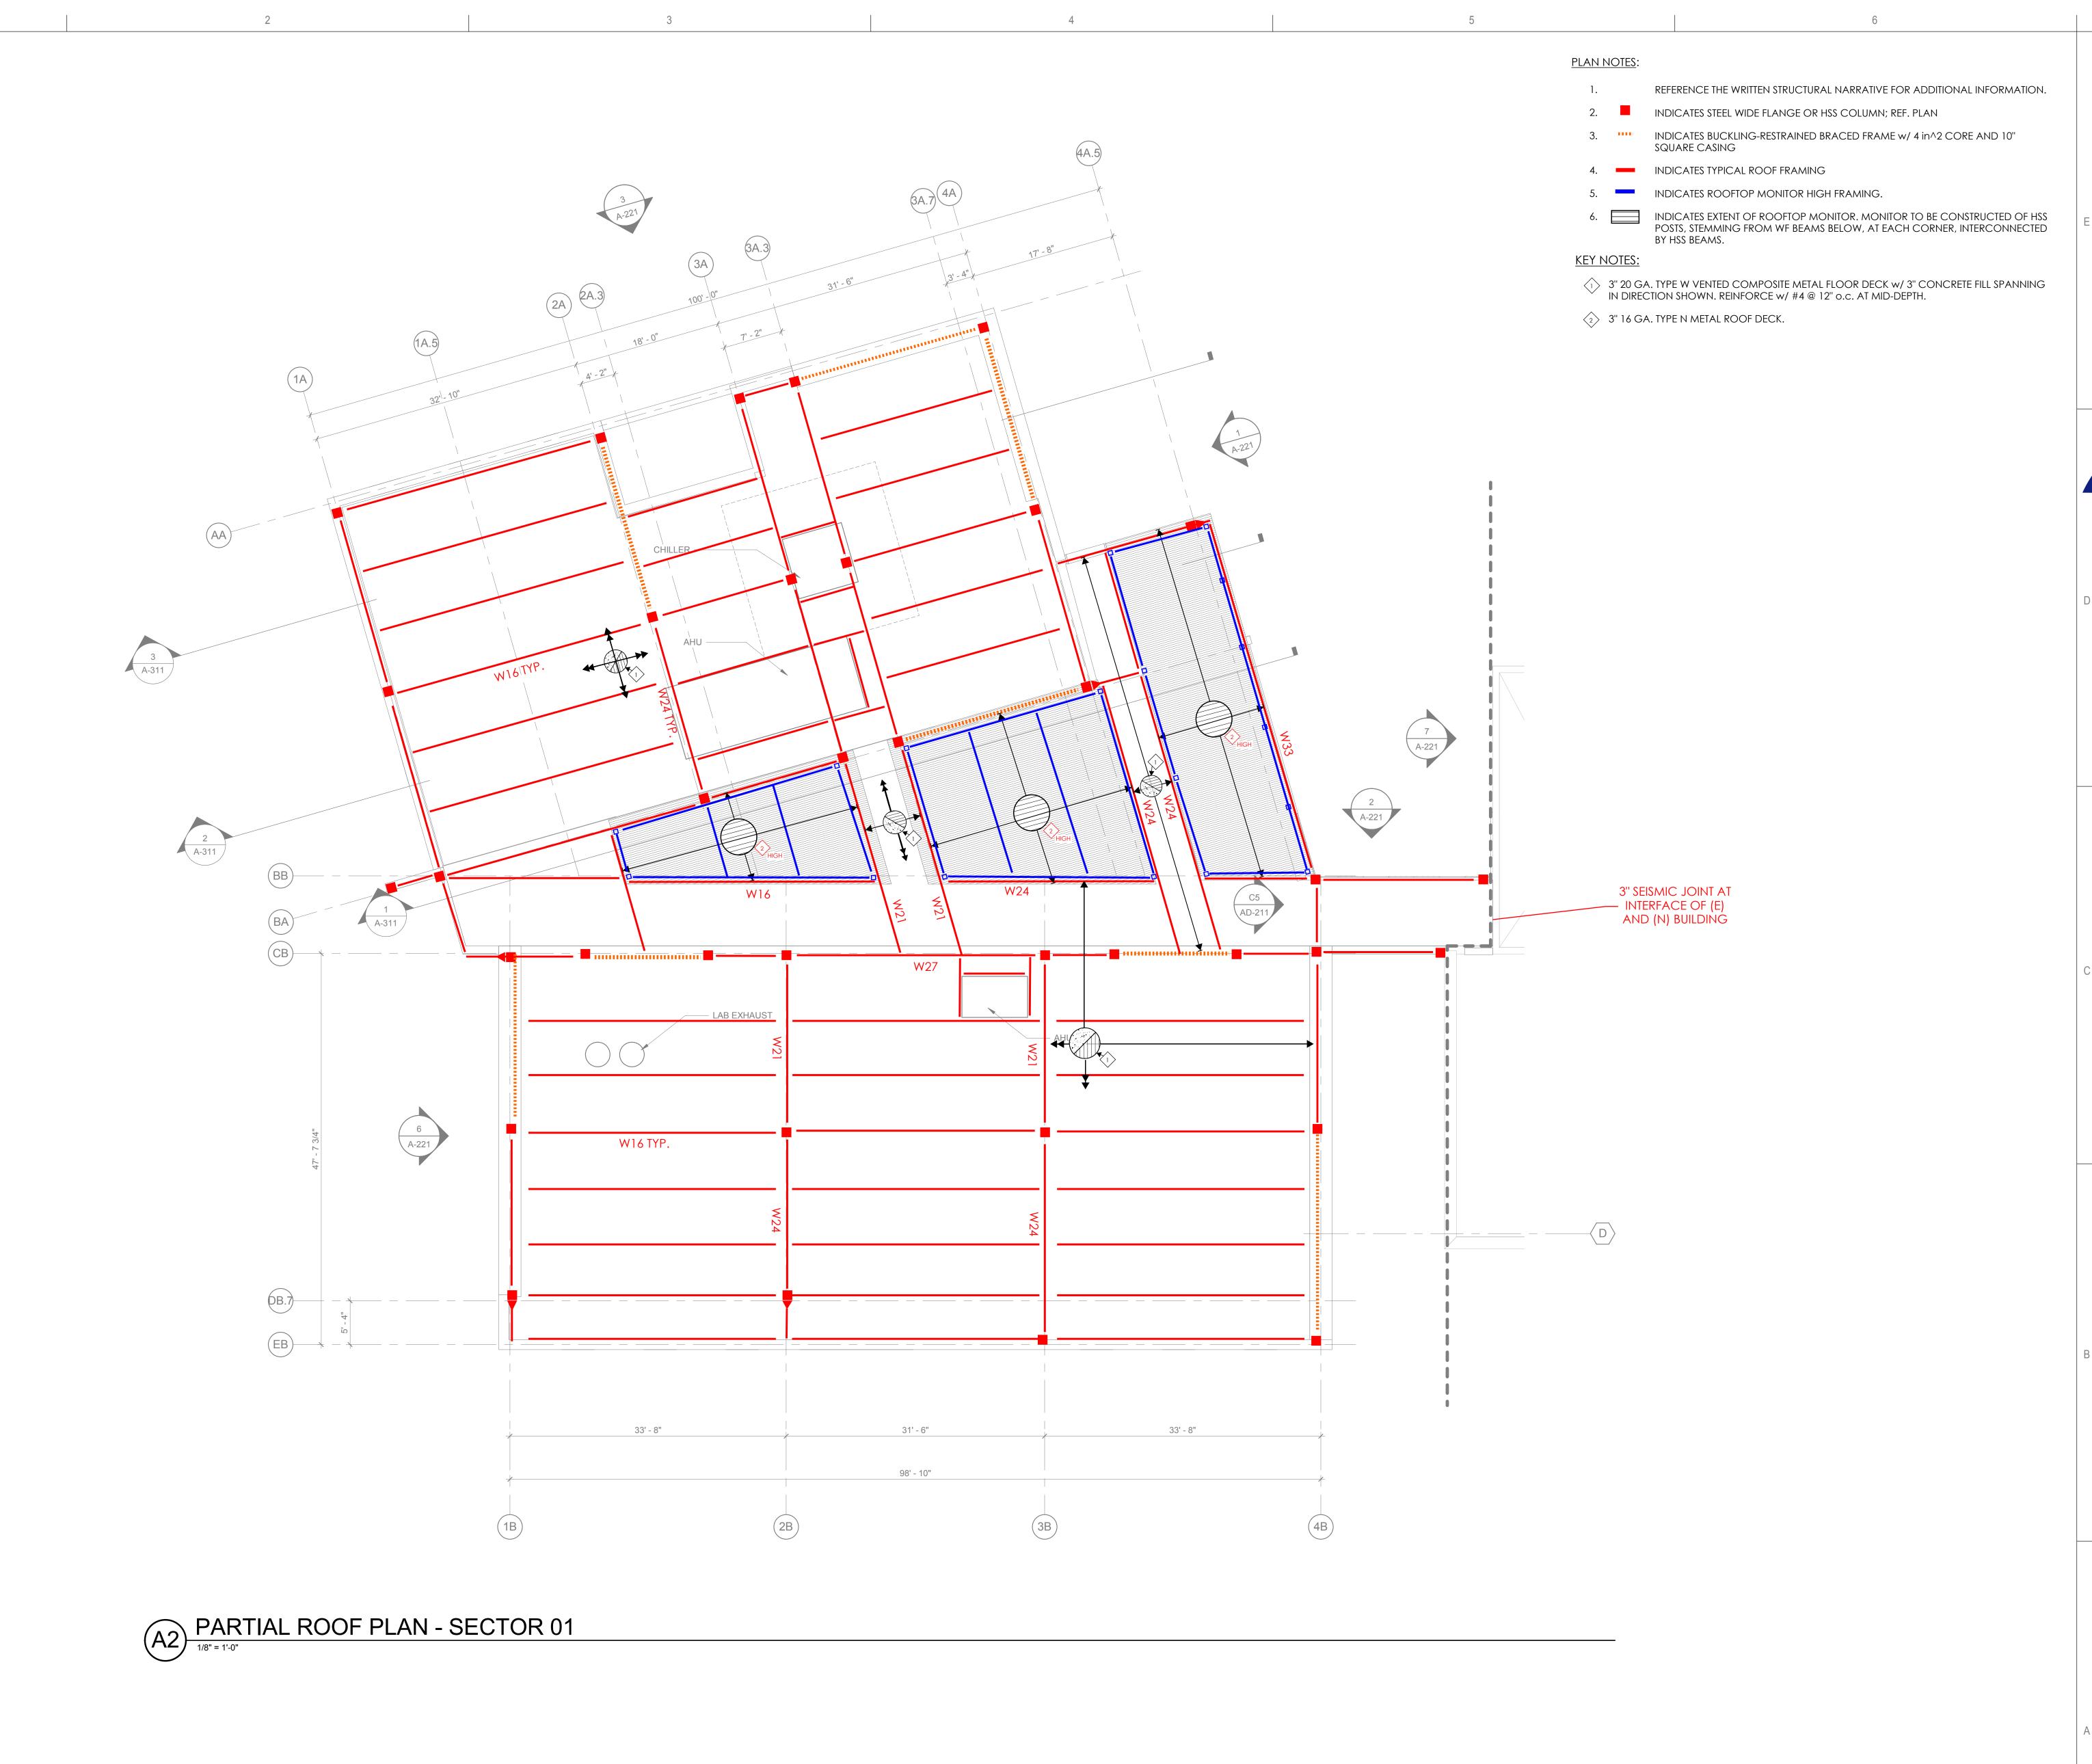

mahlum

71 COLUMBIA | FLOOR 4

SEATTLE WA 98104 (206) 441-4151 OFFICE (206) 441-0478 FAX 1231 NW HOYT | SUITE 102

PORTLAND OR 97209

(503) 224-4032 OFFICE (503) 224-0918 FAX

MAHLUM ARCHITECTS INC

catena consulting engineers





CLACKAMAS COMMUNITY COLLEGE DEJARDIN ADDITION/RENOVATION

19600 MOLALLA AVE. OREGON CITY, OR 97045

ARK DATE DESCRIPTION

ISSUE DATE: AUGUST 23,2017
ISSUE: SCHEMATIC DESIGN

PROJECT NO: 2017401


DRAWN BY: Author

CHECKED BY: Checker

COPYRIGHT MAHLUM ARCHITECTS, INC. 2011 ORIGINAL SHEET SIZE: 30"x42"

PARTIAL ROOF PLAN - SECTOR 01

S-141A

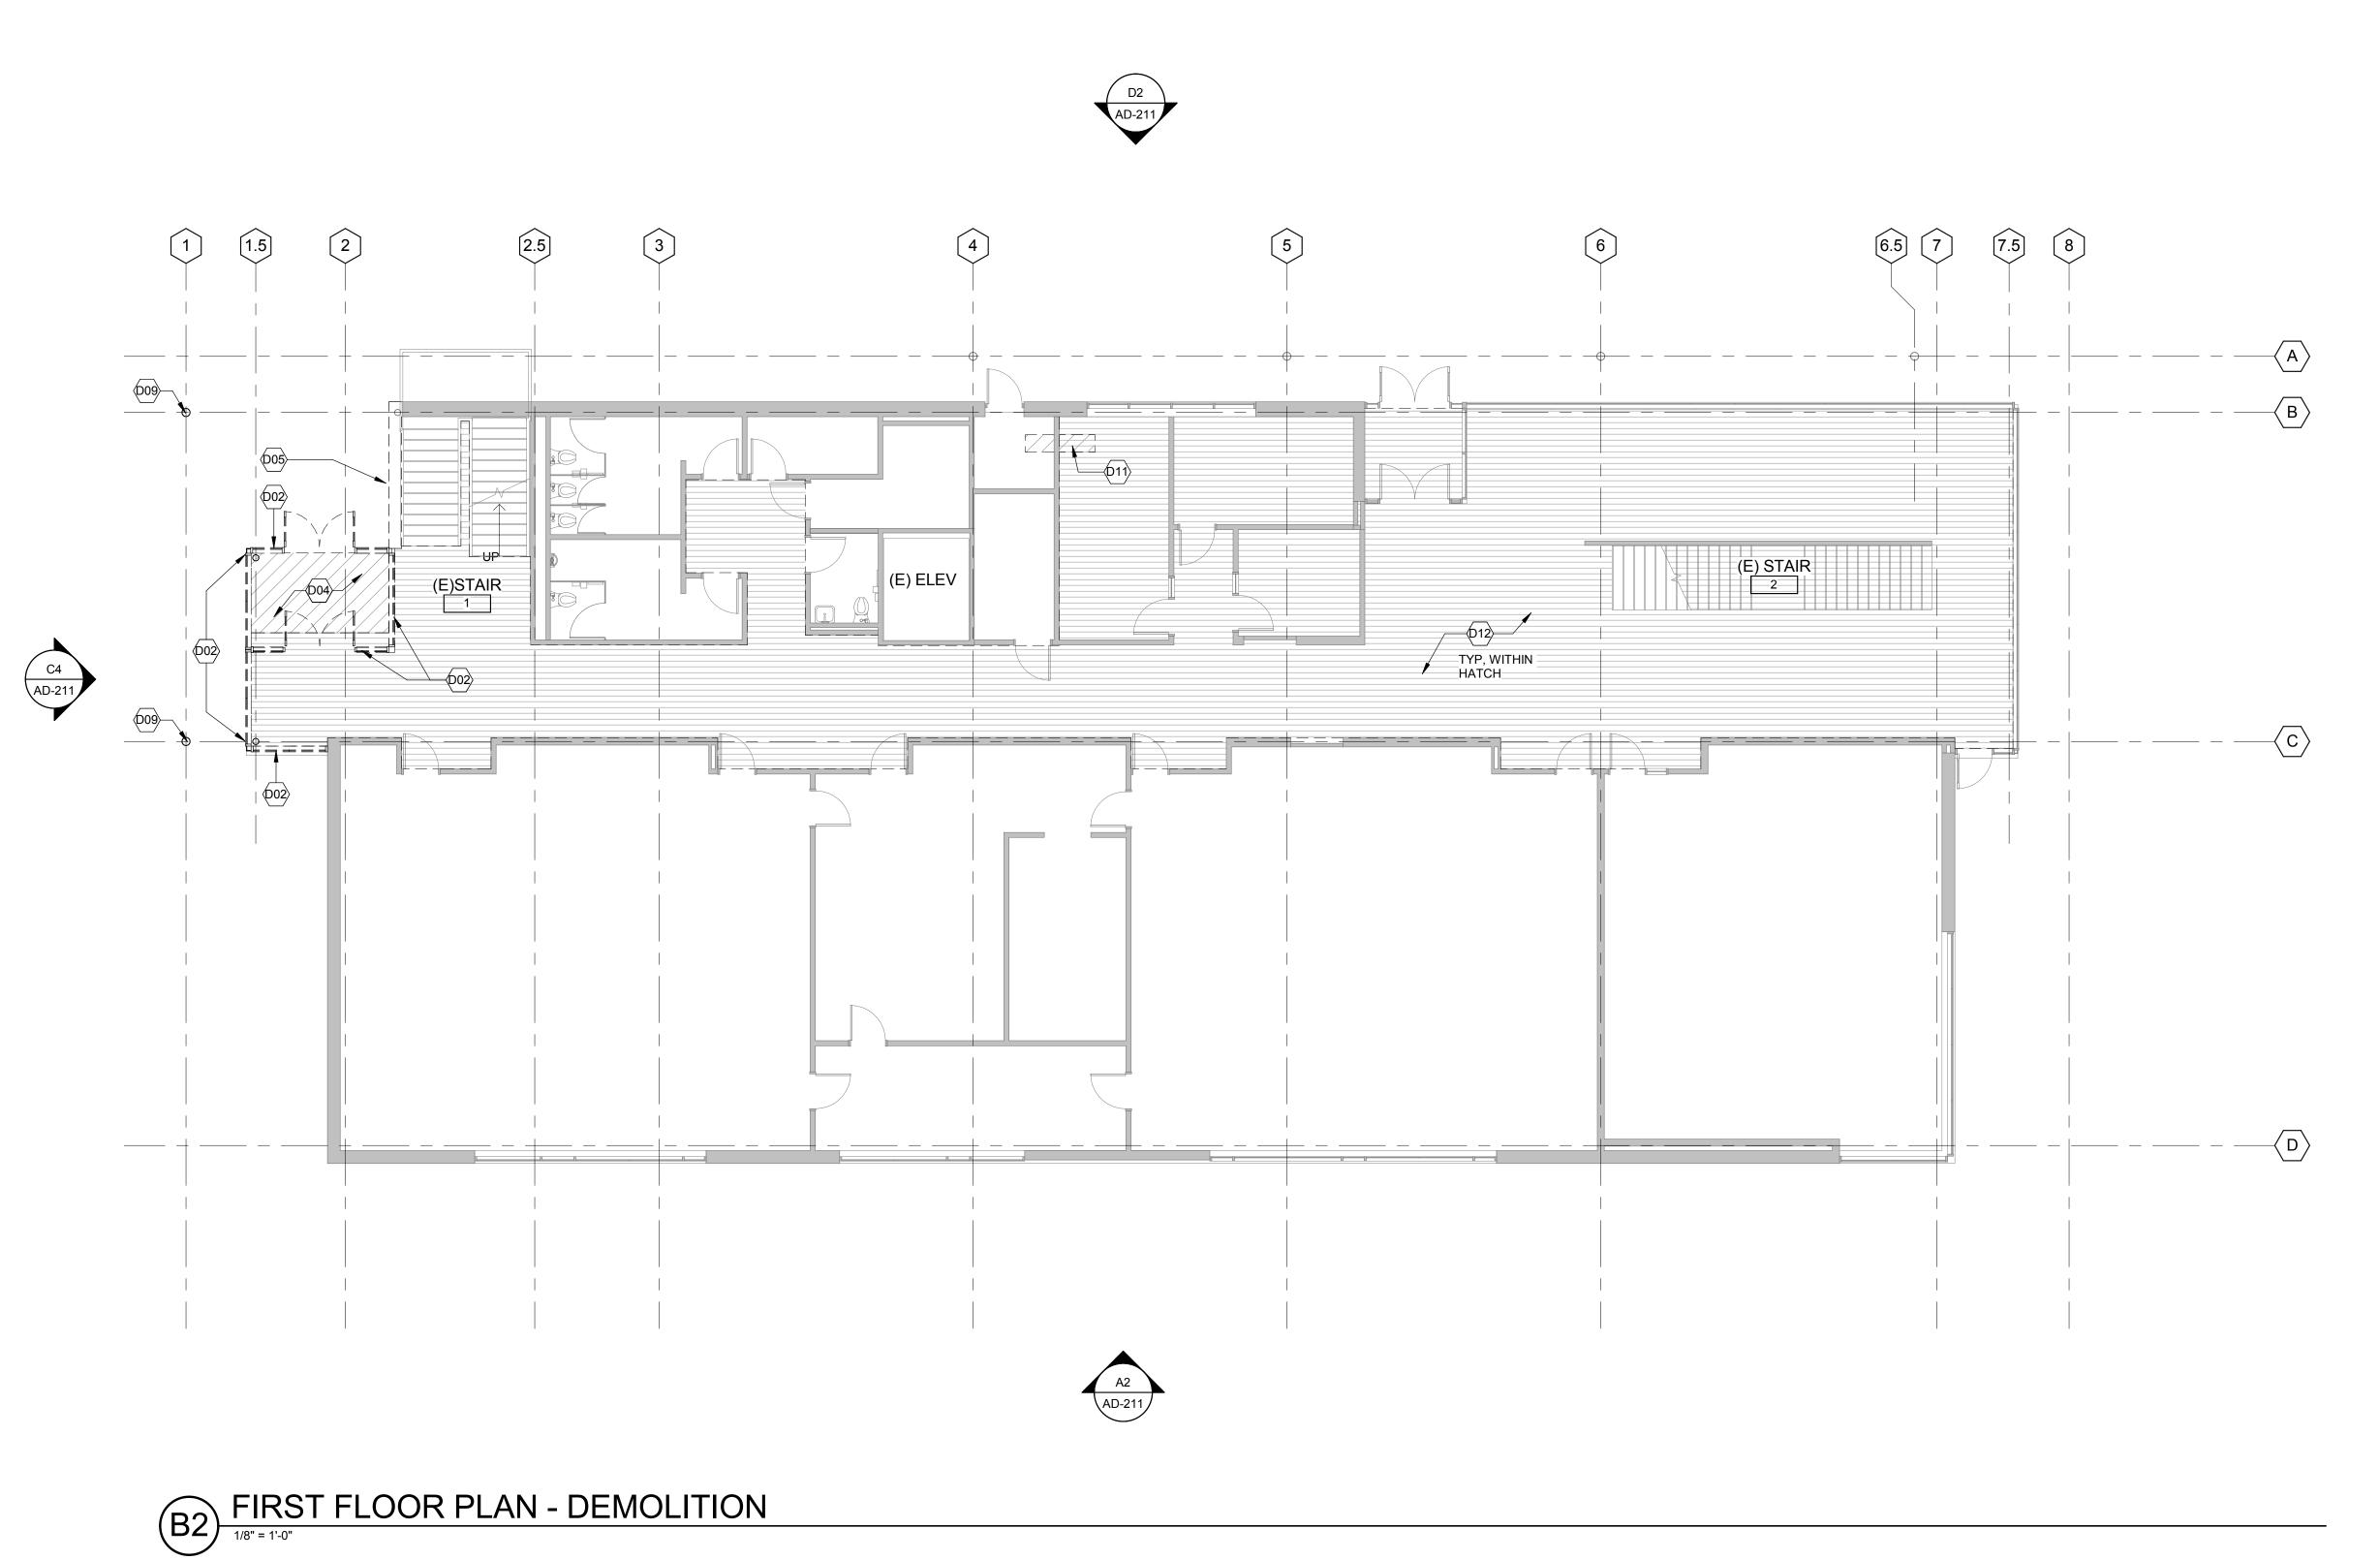

 ITEMS NOTED FOR REMOVAL ARE INDICATED TO ESTABLISH GENERAL SCOPE OF DEMOLITION. CONTRACTOR SHALL VERIFY EXISTING CONDITIONS IN THE FIELD AND PROVIDE ADDITIONAL DEMOLITION AS NECESSARY TO COMPLETE AND COORDINATE THE WORK.
 EXISTING CEILINGS TO REMAIN, U.N.O.

mahlum

71 COLUMBIA | FLOOR 4 **SEATTLE** WA 98104 (206) 441-4151 OFFICE (206) 441-0478 FAX

1231 NW HOYT | SUITE 102 PORTLAND OR 97209 (503) 224-4032 OFFICE

MAHLUM ARCHITECTS INC

(503) 224-0918 FAX

DEMO SYMBOL LEGEND

DEMO WALL

DEMO DOOR

DEMO SLAB

DEMO FLOORING

DEMO ACOUSTIC CEILING
TILE AND GRID

KEYNOTES

NUMBER

DEMO GYP CEILING AS REQUIRED FOR NEW SPRINKLER MAIN FROM EXISTING RISER ROOM

DU2

DEMO STOREFRONT WINDOWS, DOORS, AND CONCRETE CURBS

DU3

DEMO AREA OF ROOF AND ROOF FRAMING, SOFFIT, AND LIGHTING

DU4

DEMO AREA OF CONCRETE SLAB

DU5

DEMO MASONRY VENEER. WALL FRAMING AND SHEATHING TO REMAIN

DU7

DEMO AREA OF GYPSUM BOARD CEILING

DU8

REMOVE AND SALVAGE DOOR, FRAMING, AND RELITE FOR RE-USE

DU9

DEMO COLUMN

D10

DEMOLISH ACOUSTIC CEILING TILES/GRID

D11

DEMO SLAB AS REQUIRED TO CONNECT WASTE LINE FROM NEW SINK

REMOVE EXISTING FLOORING AND PREPARE SLAB FOR NEW FLOOR FINISH

FOR REFERENCE



CLACKAMAS COMMUNITY COLLEGE DEJARDIN ADDITION/RENOVATION

19600 MOLALLA AVE. OREGON CITY, OR 97045

MARK DATE

SSUE DATE: AUGUST 23,2017
SSUE: SCHEMATIC DESIGN

DESCRIPTION

PROJECT NO: 2017401


DRAWN BY: KF

CHECKED BY: KO

COPYRIGHT MAHLUM ARCHITECTS, INC. 2011 ORIGINAL SHEET SIZE: 30"x42"

FIRST FLOOR PLAN -DEMOLITION

PLAN NORTH

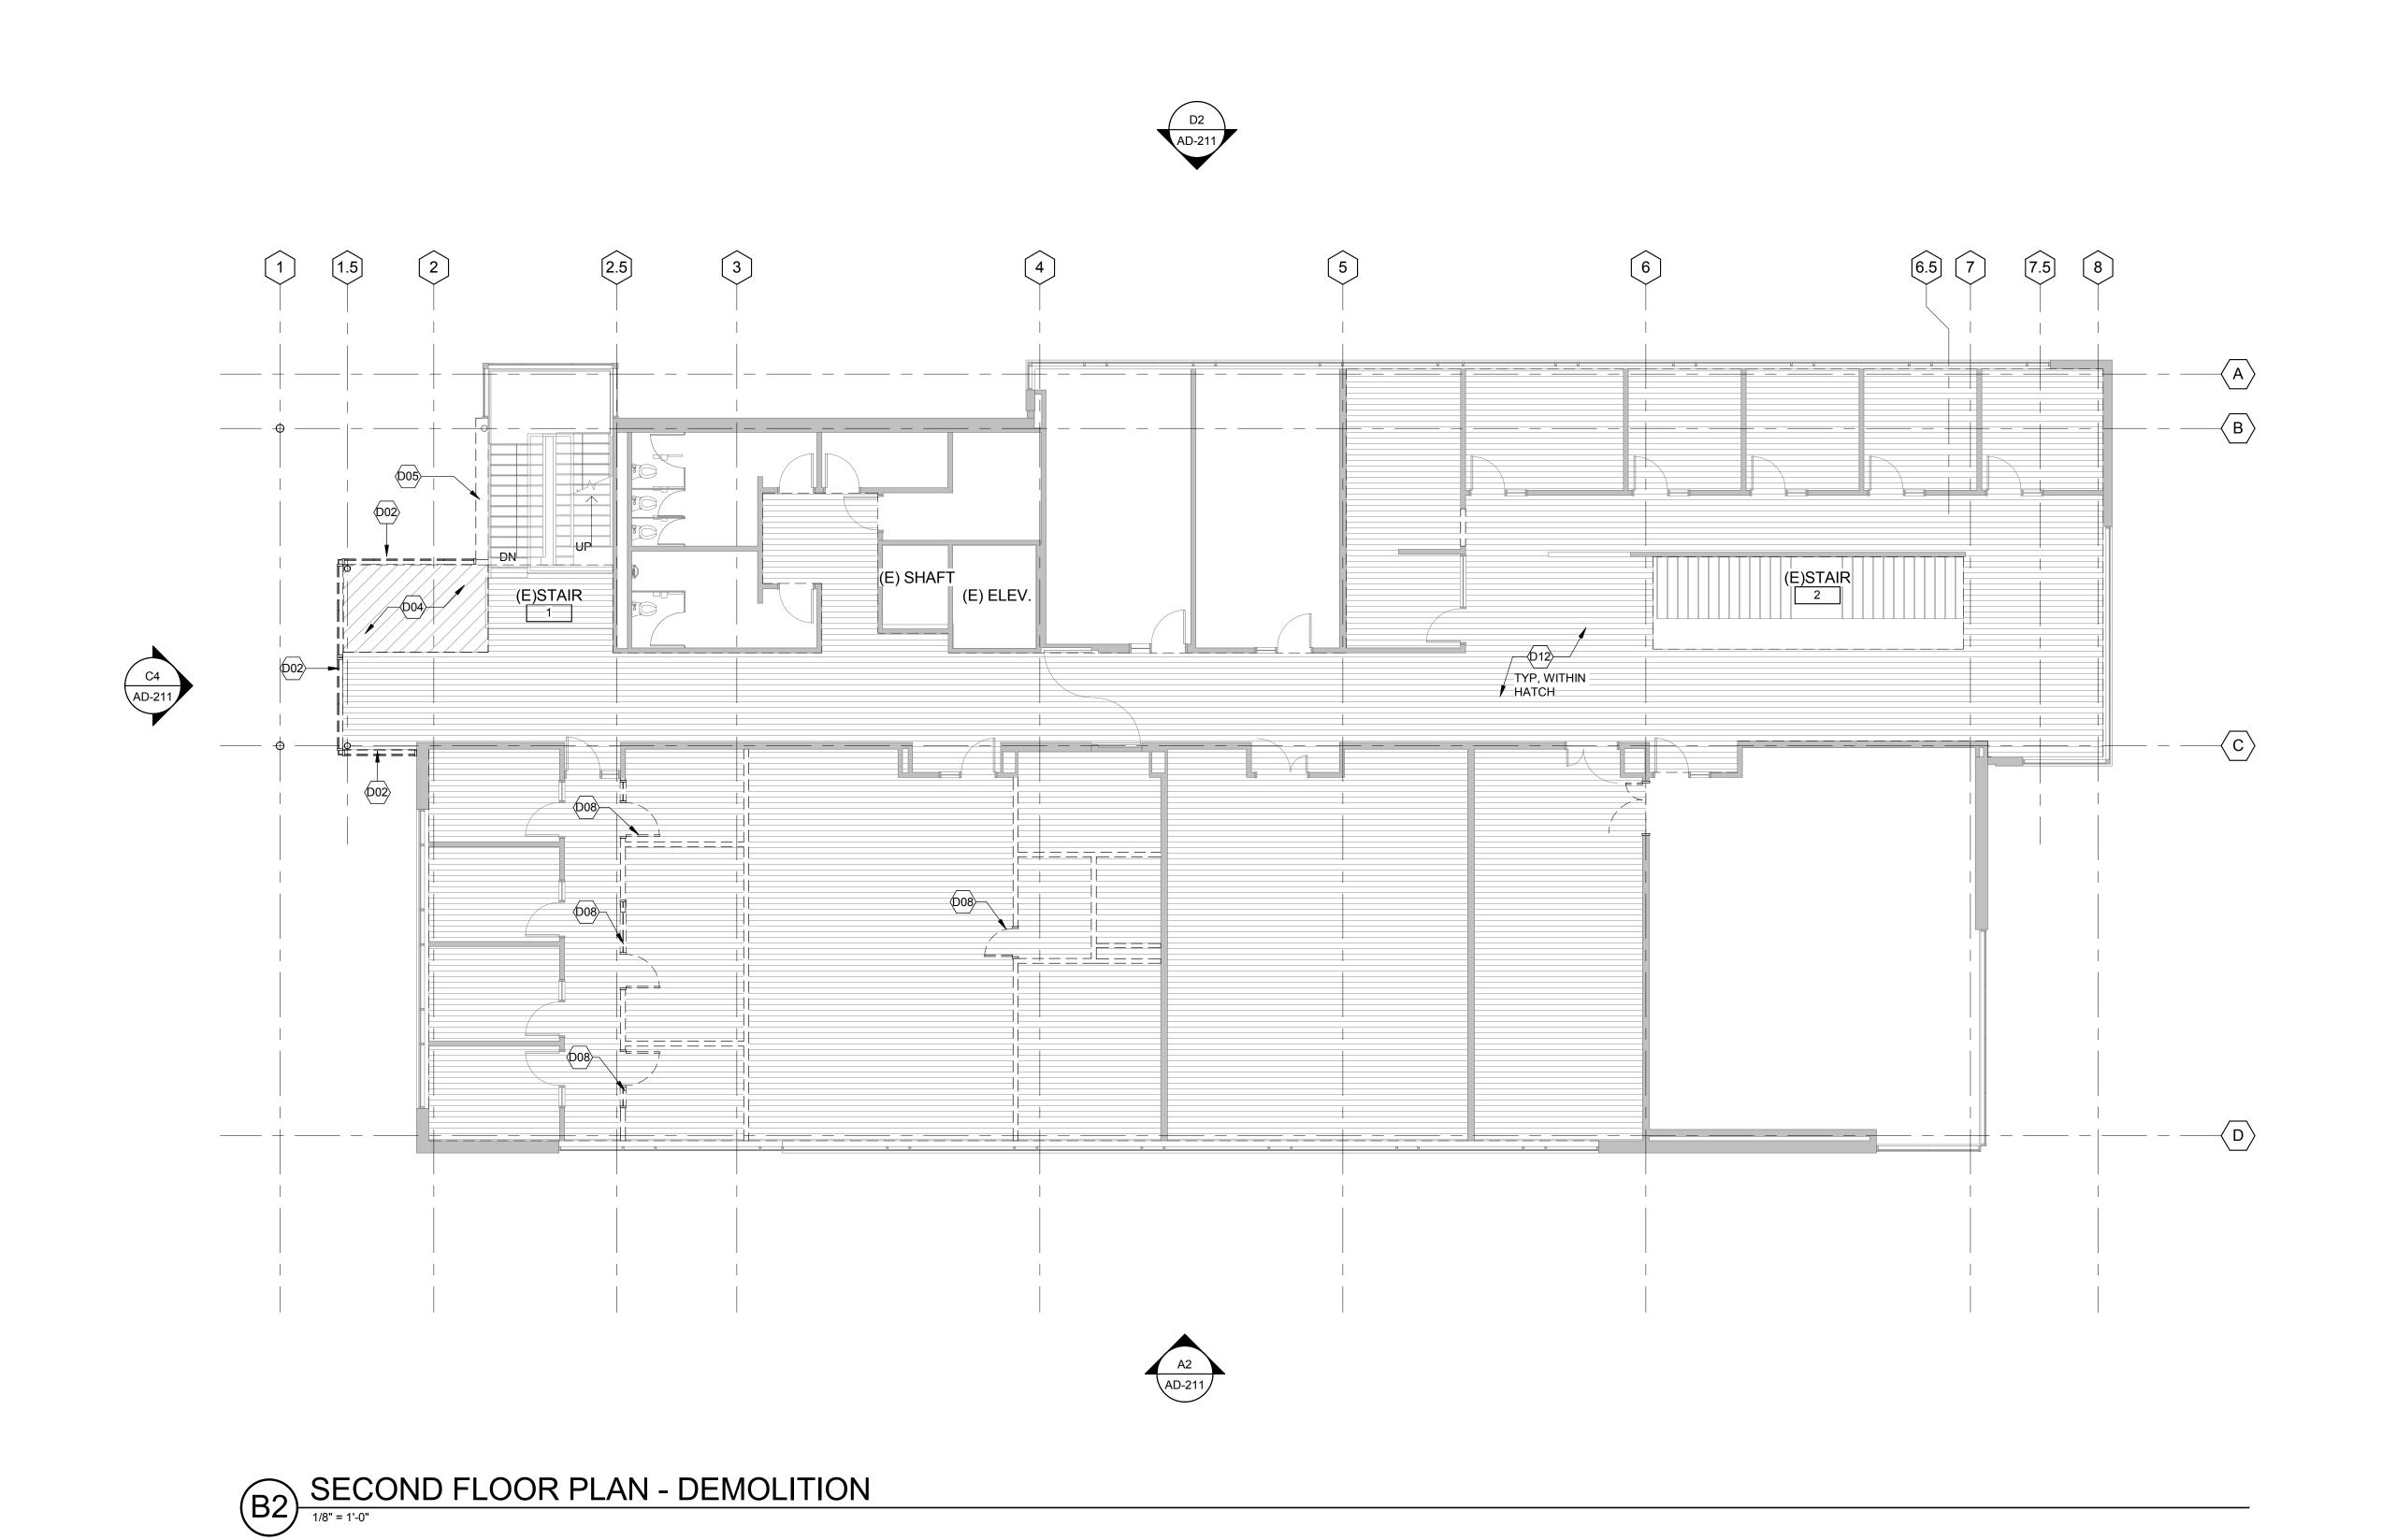

ITEMS NOTED FOR REMOVAL ARE INDICATED TO ESTABLISH GENERAL SCOPE OF DEMOLITION. CONTRACTOR SHALL VERIFY EXISTING CONDITIONS IN THE FIELD AND PROVIDE ADDITIONAL DEMOLITION AS NECESSARY TO COMPLETE AND COORDINATE THE WORK.
 EXISTING CEILINGS TO REMAIN, U.N.O.

mahlum

71 COLUMBIA | FLOOR 4 **SEATTLE** WA 98104 (206) 441-4151 OFFICE (206) 441-0478 FAX

1231 NW HOYT | SUITE 102 **PORTLAND** OR 97209 (503) 224-4032 OFFICE

MAHLUM ARCHITECTS INC


(503) 224-0918 FAX

DEMO SYMBOL LEGEND

====	DEMO WALL
	DEMO DOOR
	DEMO SLAB
	DEMO FLOORING
	DEMO ACOUSTIC CEILING TILE AND GRID

KEYNOTES

NUMBER	NOTE
D01	DEMO GYP CEILING AS REQUIRED FOR NEW SPRINKLER MAIN FROM EXIST RISER ROOM
D02	DEMO STOREFRONT WINDOWS, DOORS, AND CONCRETE CURBS
D03	DEMO AREA OF ROOF AND ROOF FRAMING, SOFFIT, AND LIGHTING
D04	DEMO AREA OF CONCRETE SLAB
D05	DEMO MASONRY VENEER. WALL FRAMING AND SHEATHING TO REMAIN
D07	DEMO AREA OF GYPSUM BOARD CEILING
D08	REMOVE AND SALVAGE DOOR, FRAMING, AND RELITE FOR RE-USE
D09	DEMO COLUMN
D10	DEMOLISH ACOUSTIC CEILING TILES/GRID
D11	DEMO SLAB AS REQUIRED TO CONNECT WASTE LINE FROM NEW SINK
D12	REMOVE EXISTING FLOORING AND PREPARE SLAB FOR NEW FLOOR FINISH

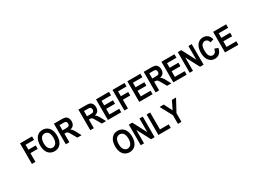



CLACKAMAS COMMUNITY COLLEGE DEJARDIN ADDITION/RENOVATION

19600 MOLALLA AVE. OREGON CITY, OR 97045

AUGUST 23,2017 SCHEMATIC DESIGN

DESCRIPTION


PROJECT NO: 2017401

DRAWN BY: KF

CHECKED BY: KO

COPYRIGHT MAHLUM ARCHITECTS, INC. 2011 ORIGINAL SHEET SIZE: 30"x42"

SECOND FLOOR PLAN - DEMOLITION

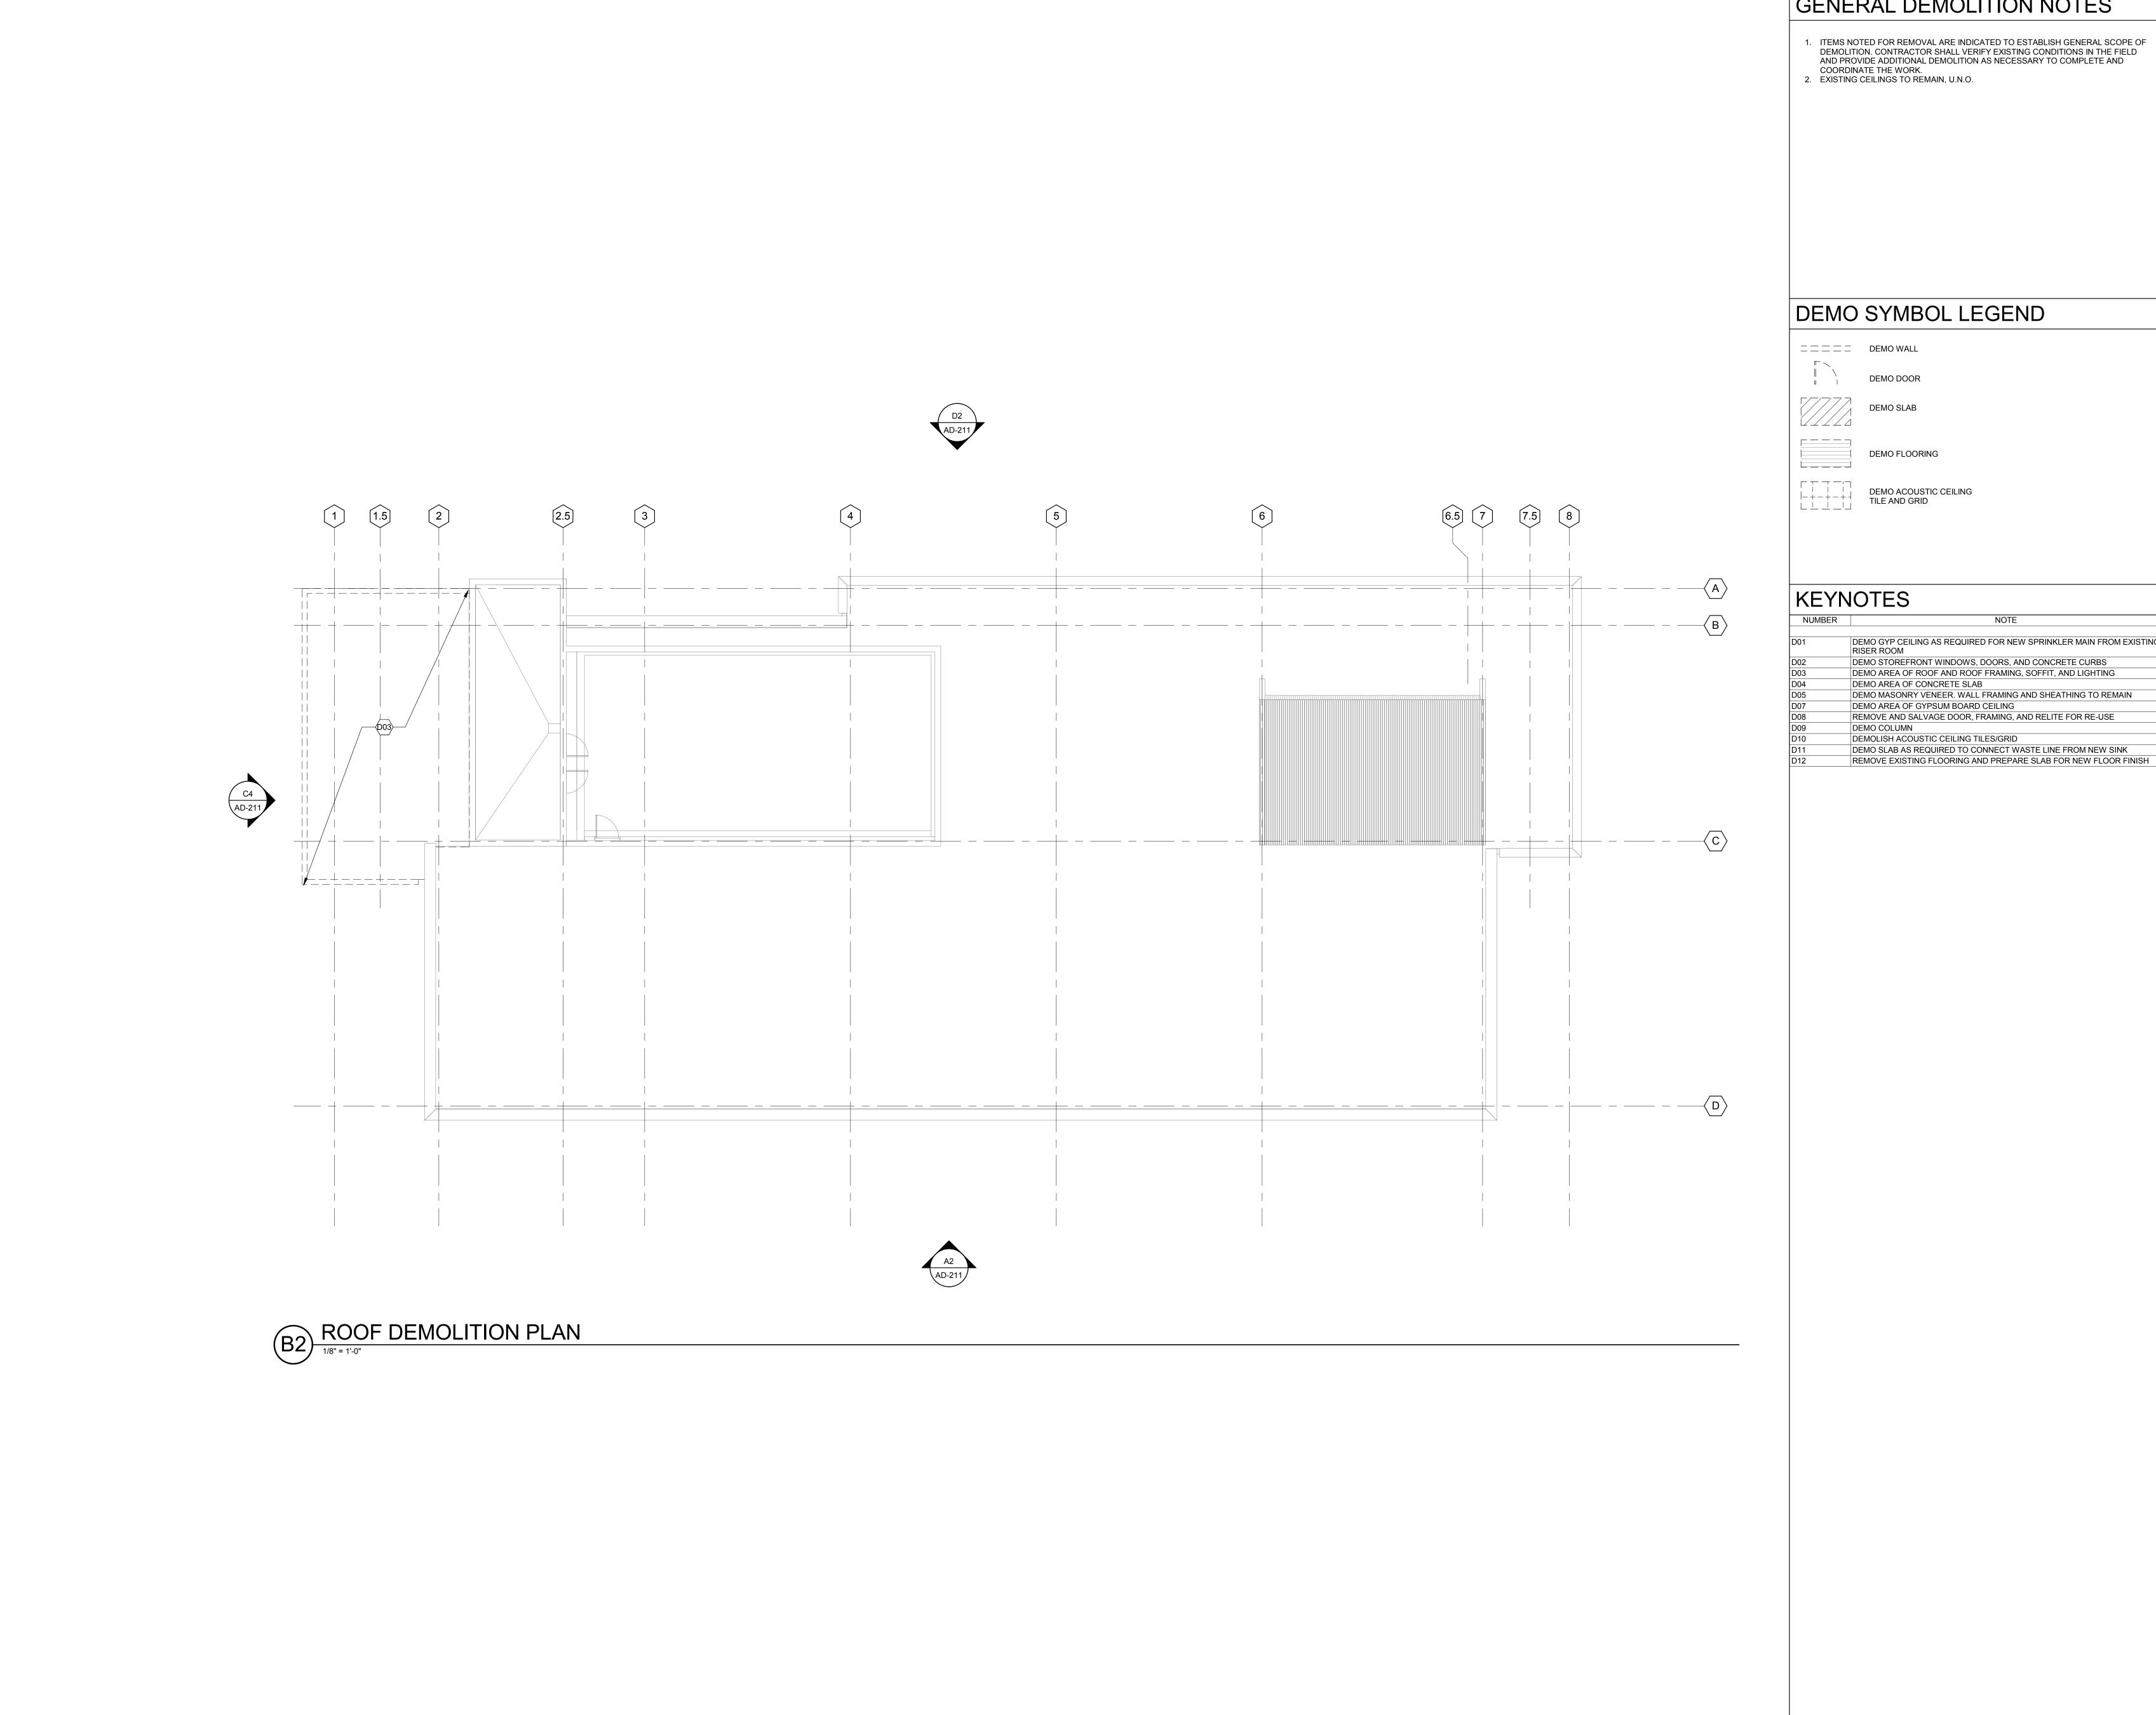

71 COLUMBIA | FLOOR 4 SEATTLE WA 98104 (206) 441-4151 OFFICE (206) 441-0478 FAX

1231 NW HOYT | SUITE 102 PORTLAND OR 97209 (503) 224-4032 OFFICE (503) 224-0918 FAX

MAHLUM ARCHITECTS INC

=====	DEMO WALL
	DEMO DOOR
	DEMO SLAB
	DEMO FLOORING
	DEMO ACOUSTIC CEILING TILE AND GRID

NUMBER	NOTE
D01	DEMO GYP CEILING AS REQUIRED FOR NEW SPRINKLER MAIN FROM EXISTING RISER ROOM
D02	DEMO STOREFRONT WINDOWS, DOORS, AND CONCRETE CURBS
D03	DEMO AREA OF ROOF AND ROOF FRAMING, SOFFIT, AND LIGHTING
D04	DEMO AREA OF CONCRETE SLAB
D05	DEMO MASONRY VENEER. WALL FRAMING AND SHEATHING TO REMAIN
D07	DEMO AREA OF GYPSUM BOARD CEILING
D08	REMOVE AND SALVAGE DOOR, FRAMING, AND RELITE FOR RE-USE
D09	DEMO COLUMN
D10	DEMOLISH ACOUSTIC CEILING TILES/GRID
B 4 4	

CLACKAMAS COMMUNITY COLLEGE DEJARDIN ADDITION/RENOVATION


19600 MOLALLA AVE. OREGON CITY, OR 97045

AUGUST 23,2017 SCHEMATIC DESIGN

DESCRIPTION

2017401

DEMOLITION ROOF PLAN

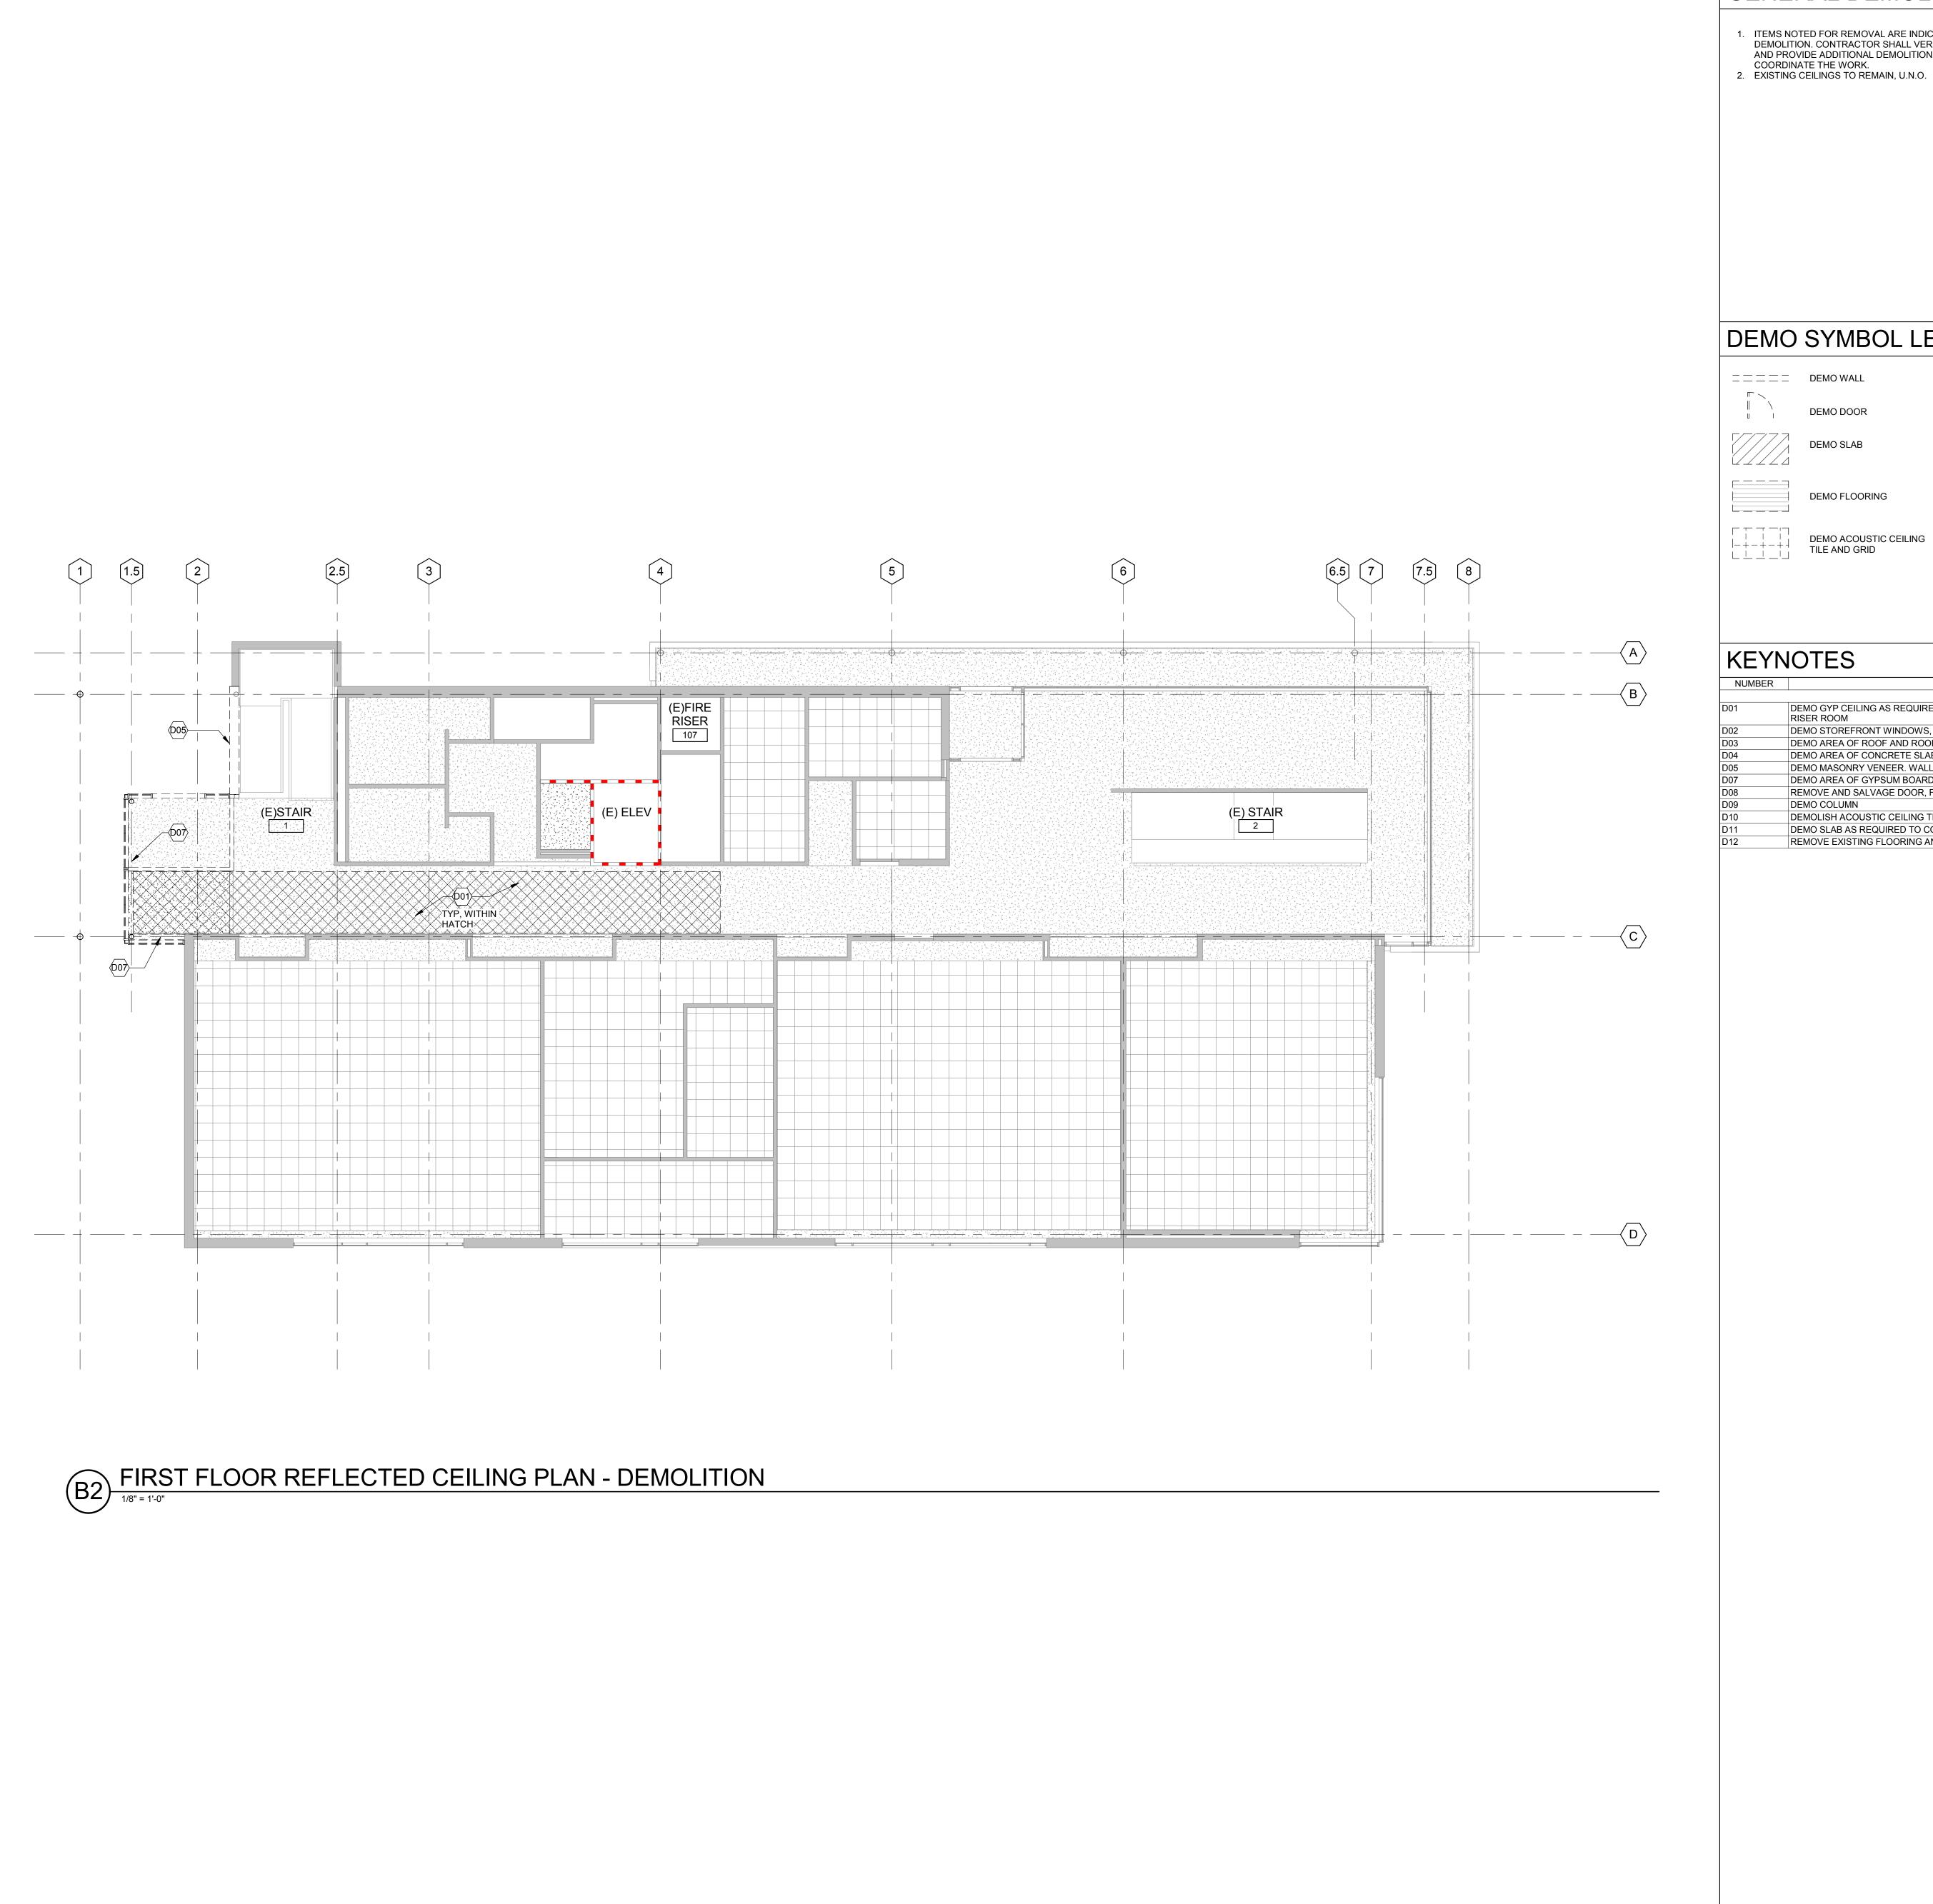

1. ITEMS NOTED FOR REMOVAL ARE INDICATED TO ESTABLISH GENERAL SCOPE OF DEMOLITION. CONTRACTOR SHALL VERIFY EXISTING CONDITIONS IN THE FIELD AND PROVIDE ADDITIONAL DEMOLITION AS NECESSARY TO COMPLETE AND

71 COLUMBIA | FLOOR 4 **SEATTLE** WA 98104 (206) 441-4151 OFFICE (206) 441-0478 FAX

1231 NW HOYT | SUITE 102 PORTLAND OR 97209 (503) 224-4032 OFFICE

MAHLUM ARCHITECTS INC

(503) 224-0918 FAX

DEMO SYMBOL LEGEND

DEMO GYP CEILING AS REQUIRED FOR NEW SPRINKLER MAIN FROM EXISTING RISER ROOM DEMO STOREFRONT WINDOWS, DOORS, AND CONCRETE CURBS DEMO AREA OF ROOF AND ROOF FRAMING, SOFFIT, AND LIGHTING DEMO AREA OF CONCRETE SLAB DEMO MASONRY VENEER. WALL FRAMING AND SHEATHING TO REMAIN DEMO AREA OF GYPSUM BOARD CEILING REMOVE AND SALVAGE DOOR, FRAMING, AND RELITE FOR RE-USE DEMOLISH ACOUSTIC CEILING TILES/GRID DEMO SLAB AS REQUIRED TO CONNECT WASTE LINE FROM NEW SINK REMOVE EXISTING FLOORING AND PREPARE SLAB FOR NEW FLOOR FINISH



CLACKAMAS COMMUNITY COLLEGE DEJARDIN ADDITION/RENOVATION


19600 MOLALLA AVE. OREGON CITY, OR 97045

AUGUST 23,2017 SCHEMATIC DESIGN

DESCRIPTION

2017401

FIRST FLOOR REFLECTED CEILING PLAN - DEMOLITION

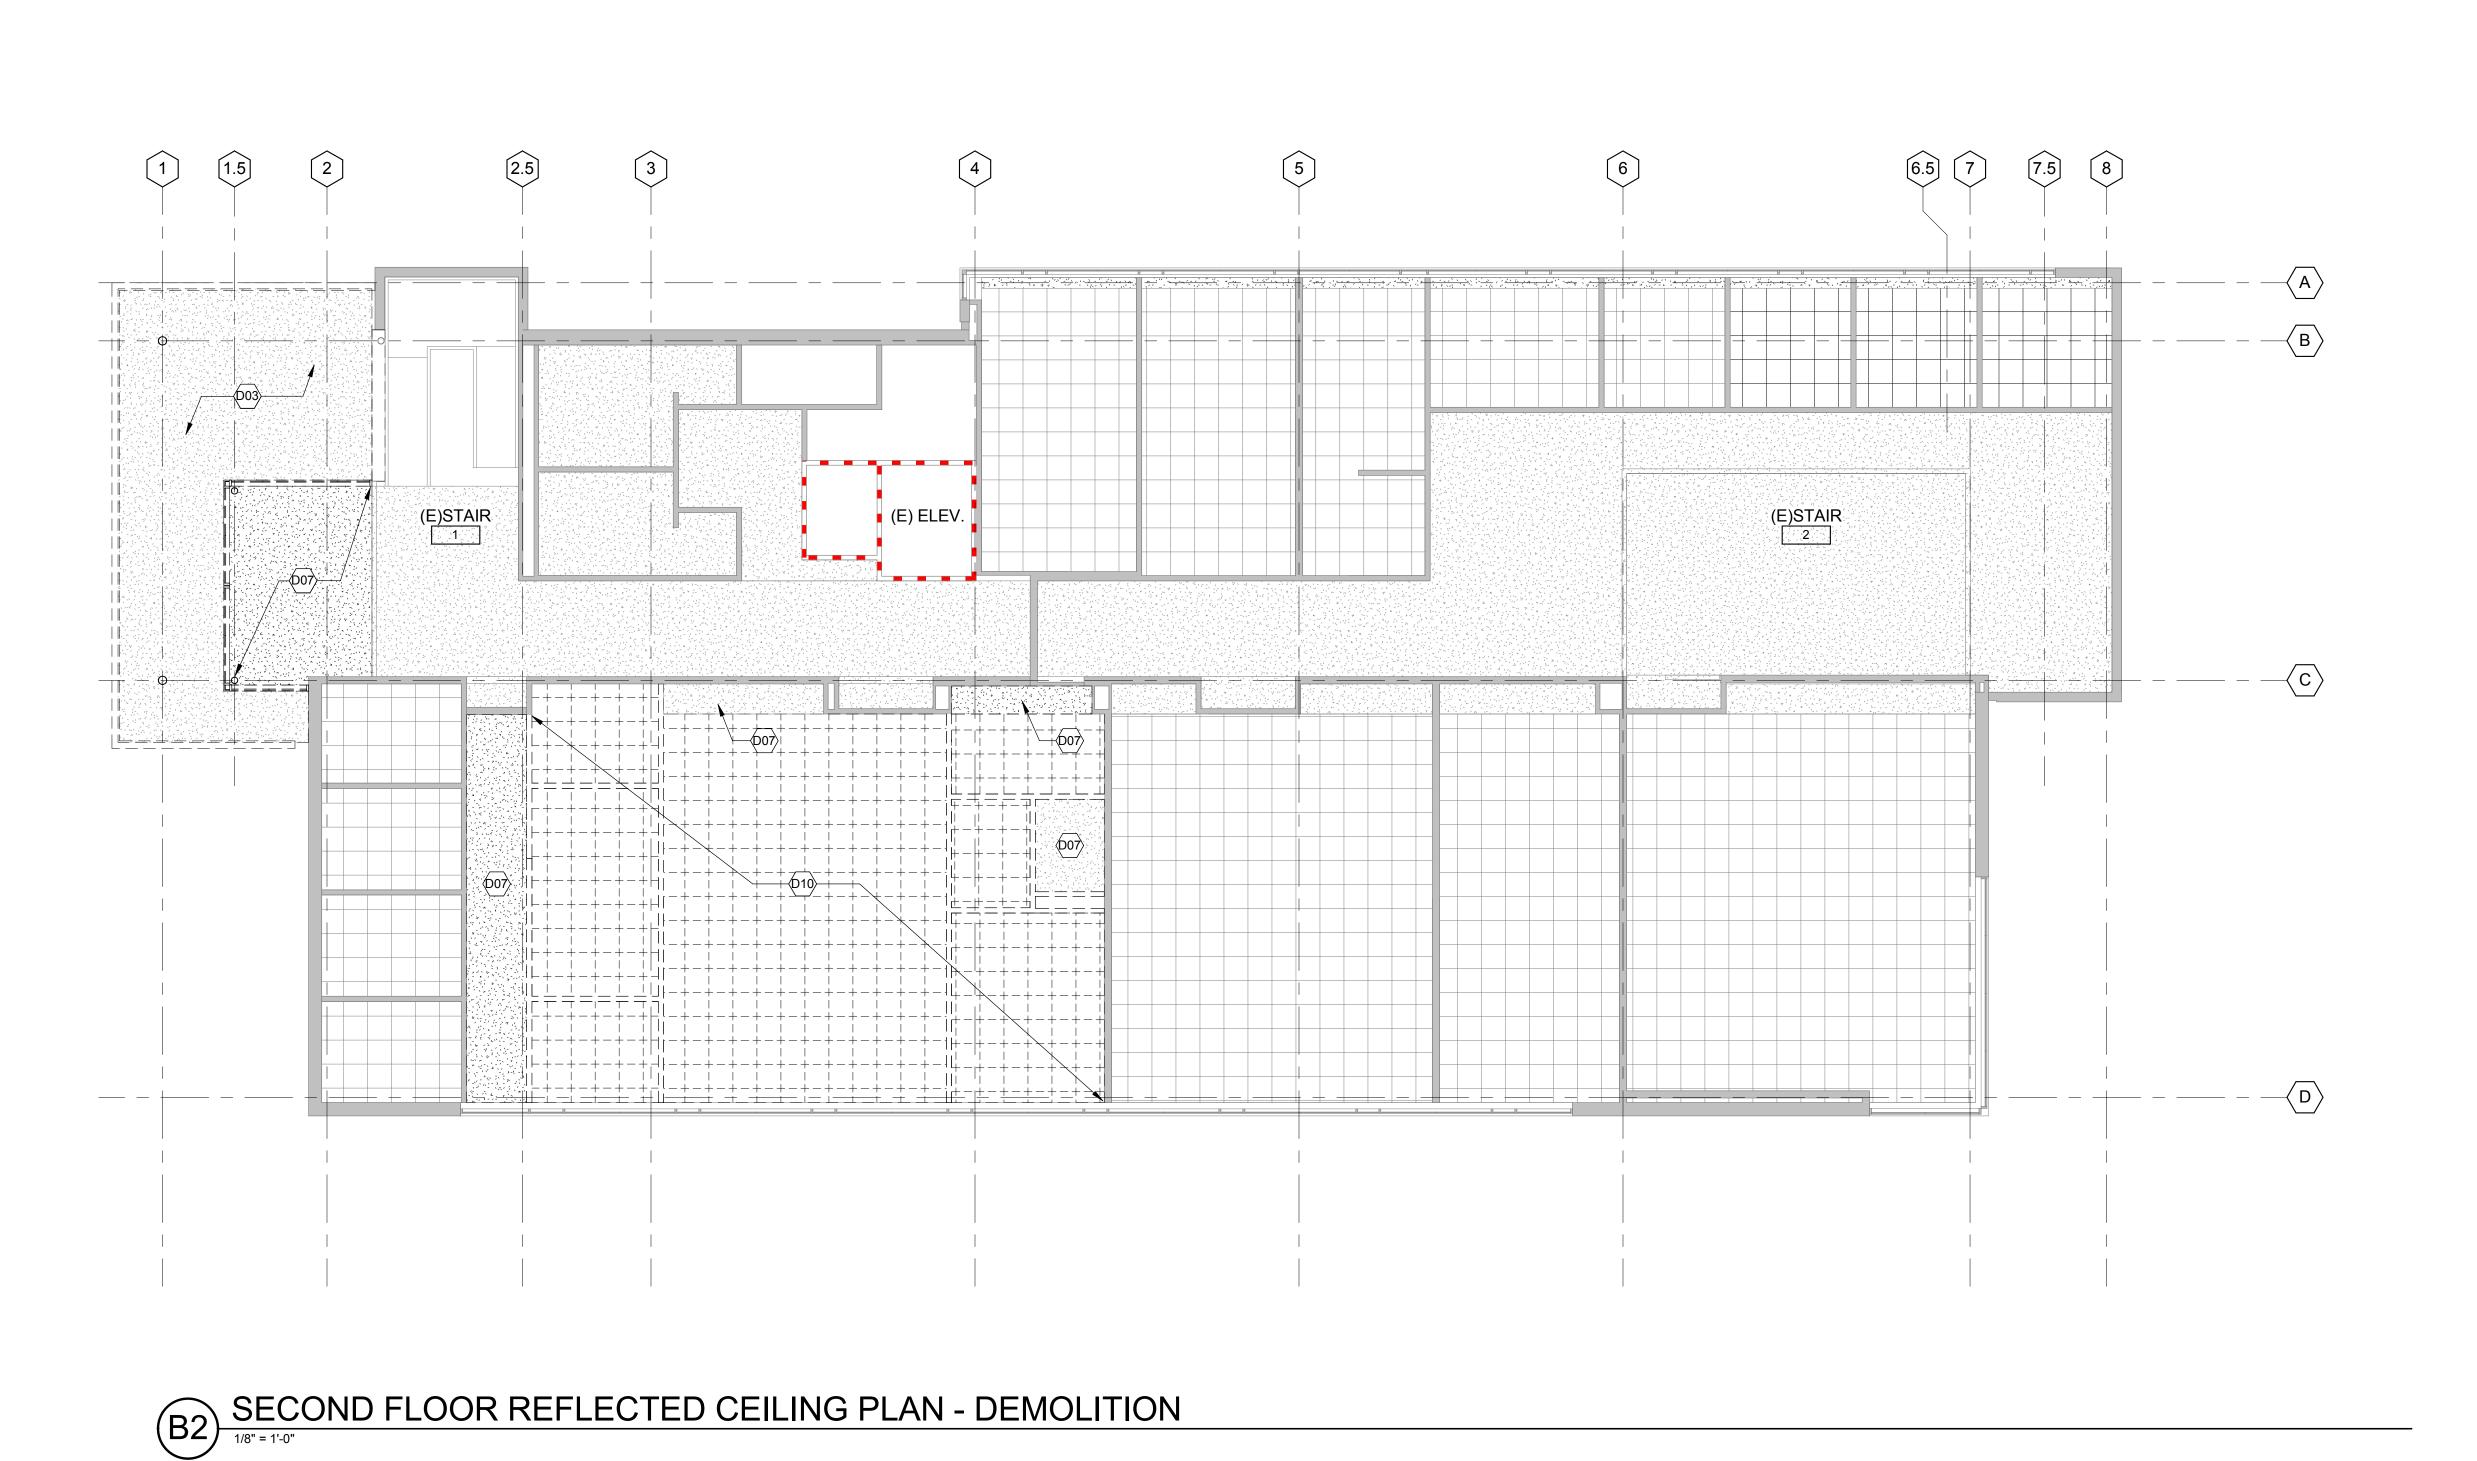

ITEMS NOTED FOR REMOVAL ARE INDICATED TO ESTABLISH GENERAL SCOPE OF DEMOLITION. CONTRACTOR SHALL VERIFY EXISTING CONDITIONS IN THE FIELD AND PROVIDE ADDITIONAL DEMOLITION AS NECESSARY TO COMPLETE AND COORDINATE THE WORK.
 EXISTING CEILINGS TO REMAIN, U.N.O.

mahlum

71 COLUMBIA | FLOOR 4 **SEATTLE** WA 98104 (206) 441-4151 OFFICE (206) 441-0478 FAX

1231 NW HOYT | SUITE 102 PORTLAND OR 97209 (503) 224-4032 OFFICE (503) 224-0918 FAX

MAHLUM ARCHITECTS INC

DEMO SYMBOL LEGEND

=====	DEMO WALL
	DEMO DOOR
	DEMO SLAB
	DEMO FLOORING
	DEMO ACOUSTIC CEILING TILE AND GRID

KEYNOTES

NUMBER	NOTE
D01	DEMO GYP CEILING AS REQUIRED FOR NEW SPRINKLER MAIN FROM EXIST
	RISER ROOM
D02	DEMO STOREFRONT WINDOWS, DOORS, AND CONCRETE CURBS
D03	DEMO AREA OF ROOF AND ROOF FRAMING, SOFFIT, AND LIGHTING
D04	DEMO AREA OF CONCRETE SLAB
D05	DEMO MASONRY VENEER. WALL FRAMING AND SHEATHING TO REMAIN
D07	DEMO AREA OF GYPSUM BOARD CEILING
D08	REMOVE AND SALVAGE DOOR, FRAMING, AND RELITE FOR RE-USE
D09	DEMO COLUMN
D10	DEMOLISH ACOUSTIC CEILING TILES/GRID
D11	DEMO SLAB AS REQUIRED TO CONNECT WASTE LINE FROM NEW SINK
D12	REMOVE EXISTING FLOORING AND PREPARE SLAB FOR NEW FLOOR FINIS

FOR REFERENCE



CLACKAMAS COMMUNITY COLLEGE DEJARDIN ADDITION/RENOVATION

19600 MOLALLA AVE. OREGON CITY, OR 97045

WARR DATE

ISSUE DATE: AUGUST 23,2
ISSUE: SCHEMATIC DES

DESCRIPTION


PROJECT NO: 2017401

DRAWN BY: KF

CHECKED BY: KO

COPYRIGHT MAHLUM ARCHITECTS, INC. 2011 ORIGINAL SHEET SIZE: 30"x42"

SECOND FLOOR REFLECTED CEILING PLAN - DEMOLITION

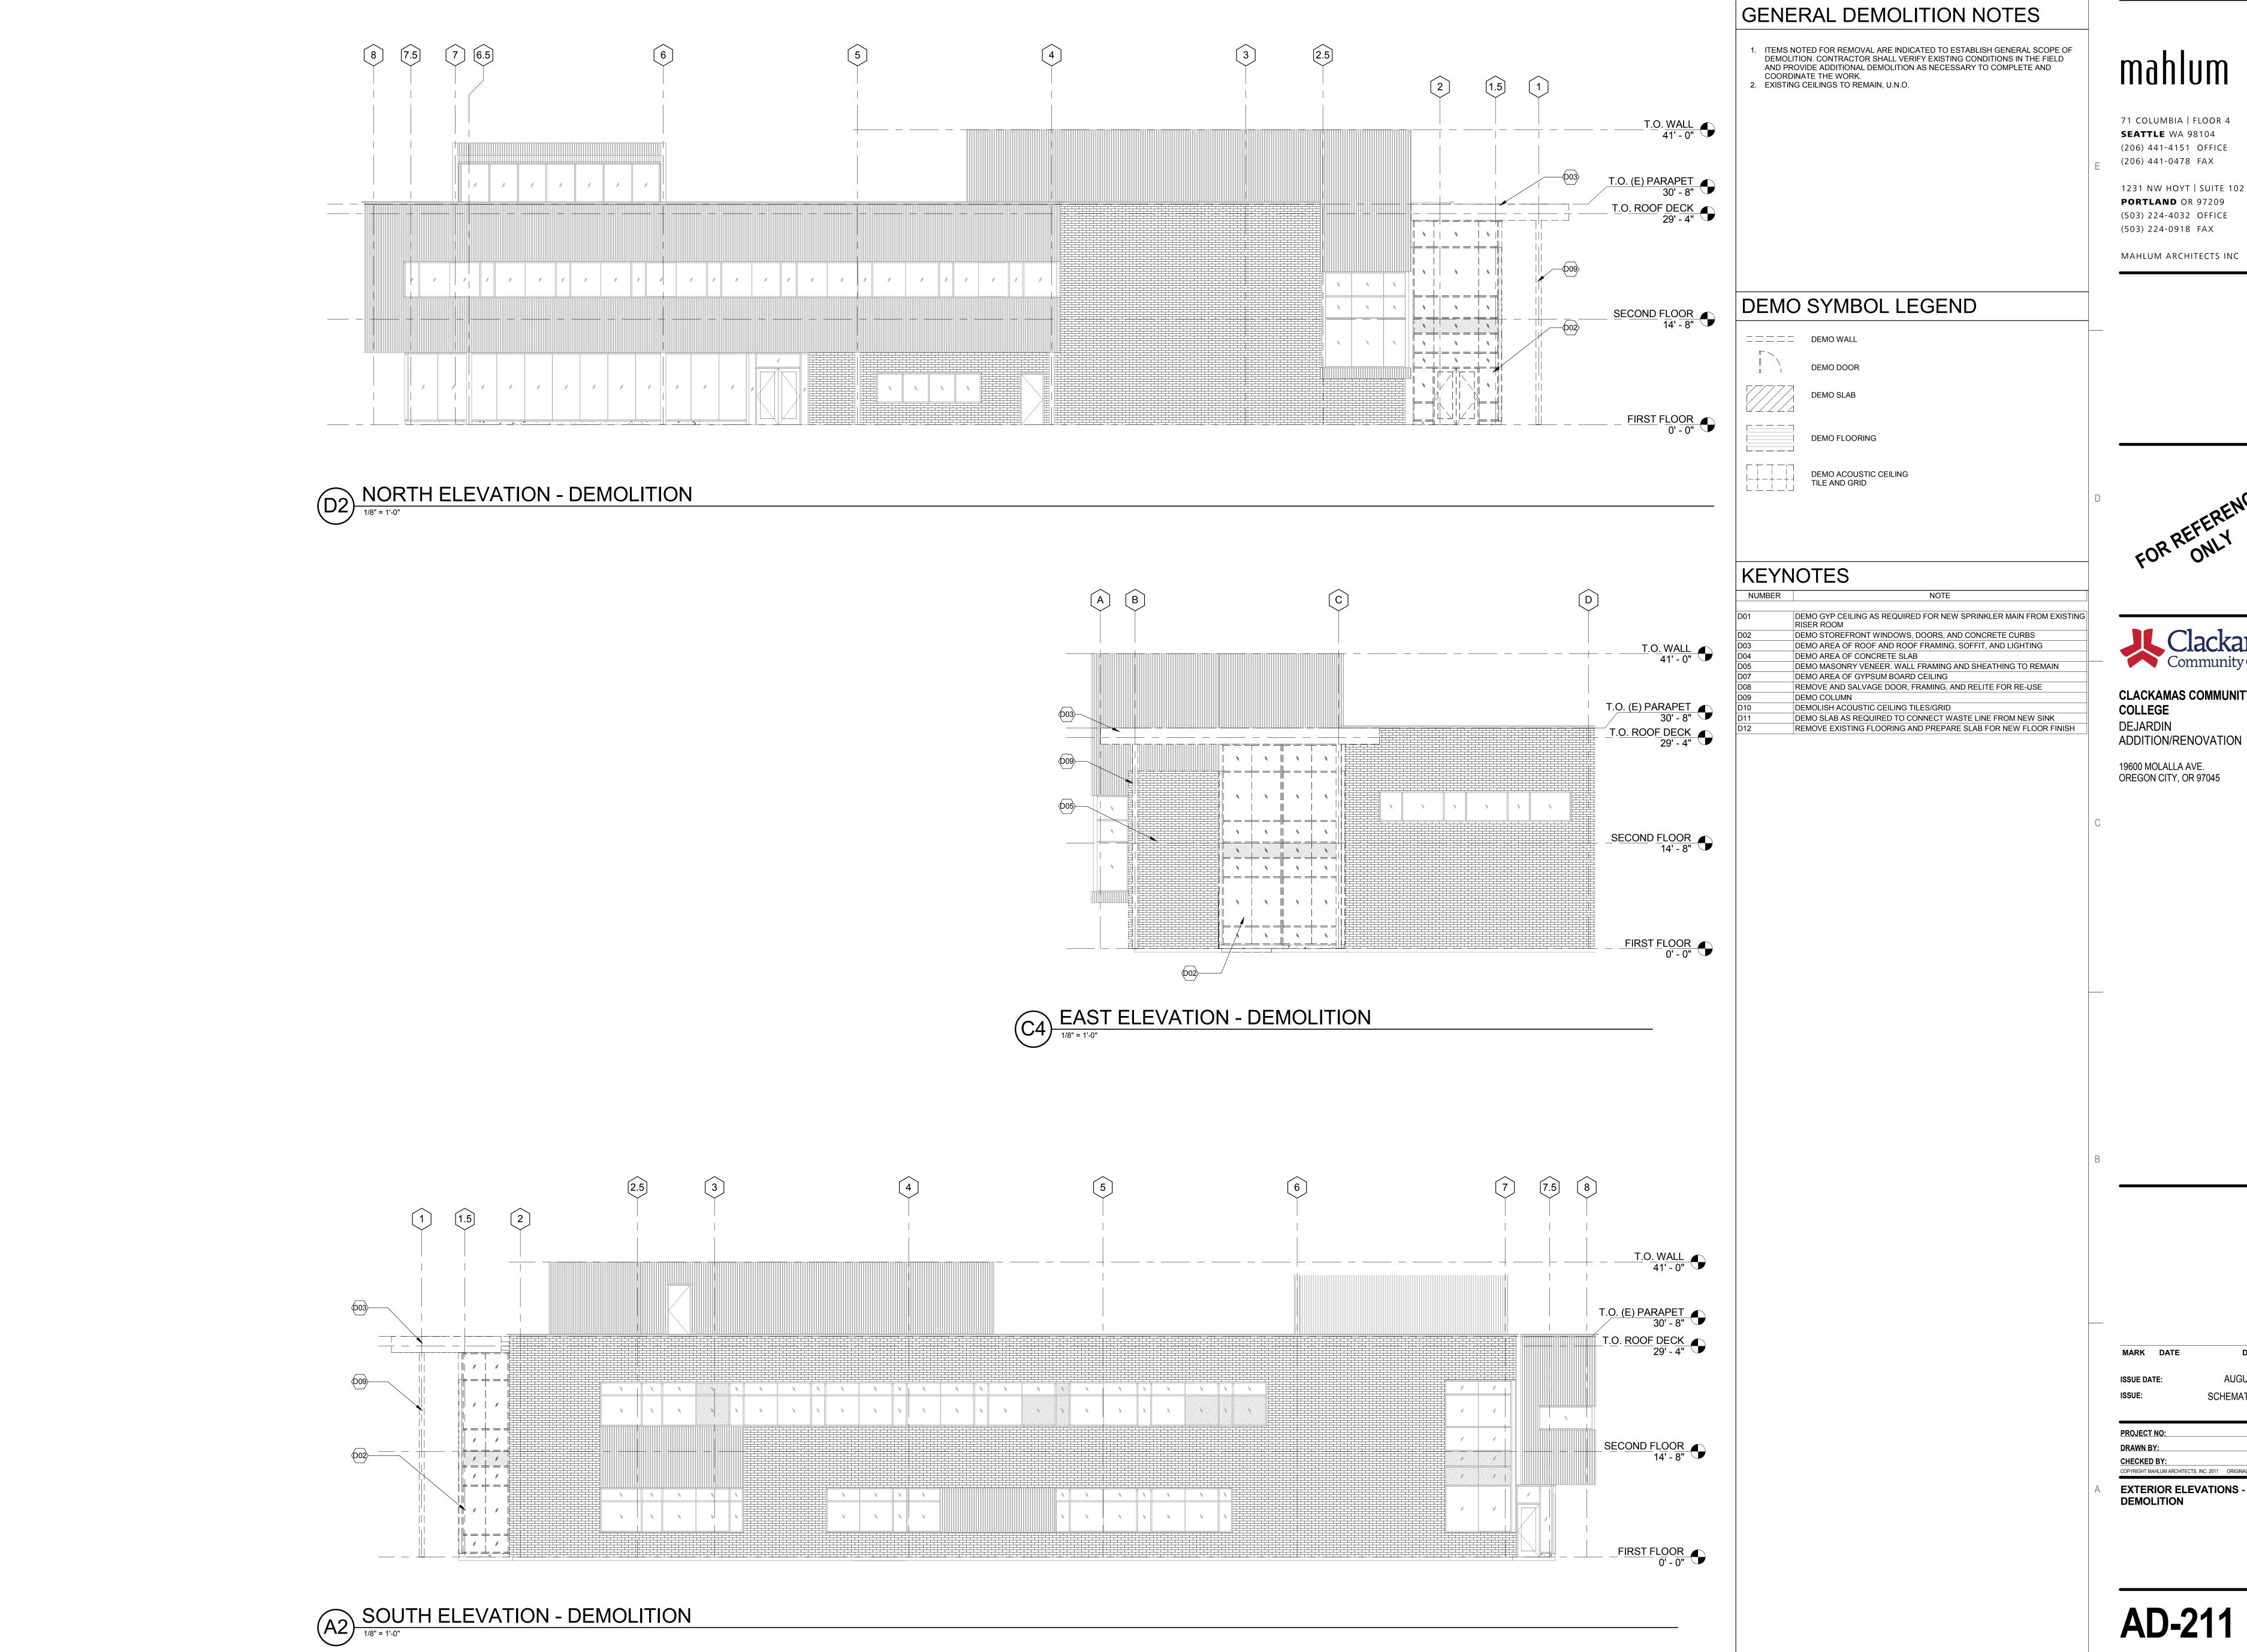

71 COLUMBIA | FLOOR 4

SEATTLE WA 98104 (206) 441-4151 OFFICE (206) 441-0478 FAX

(503) 224-4032 OFFICE (503) 224-0918 FAX



CLACKAMAS COMMUNITY COLLEGE DEJARDIN ADDITION/RENOVATION


19600 MOLALLA AVE. OREGON CITY, OR 97045

AUGUST 23,2017 SCHEMATIC DESIGN

DESCRIPTION

2017401 PROJECT NO:

EXTERIOR ELEVATIONS - DEMOLITION

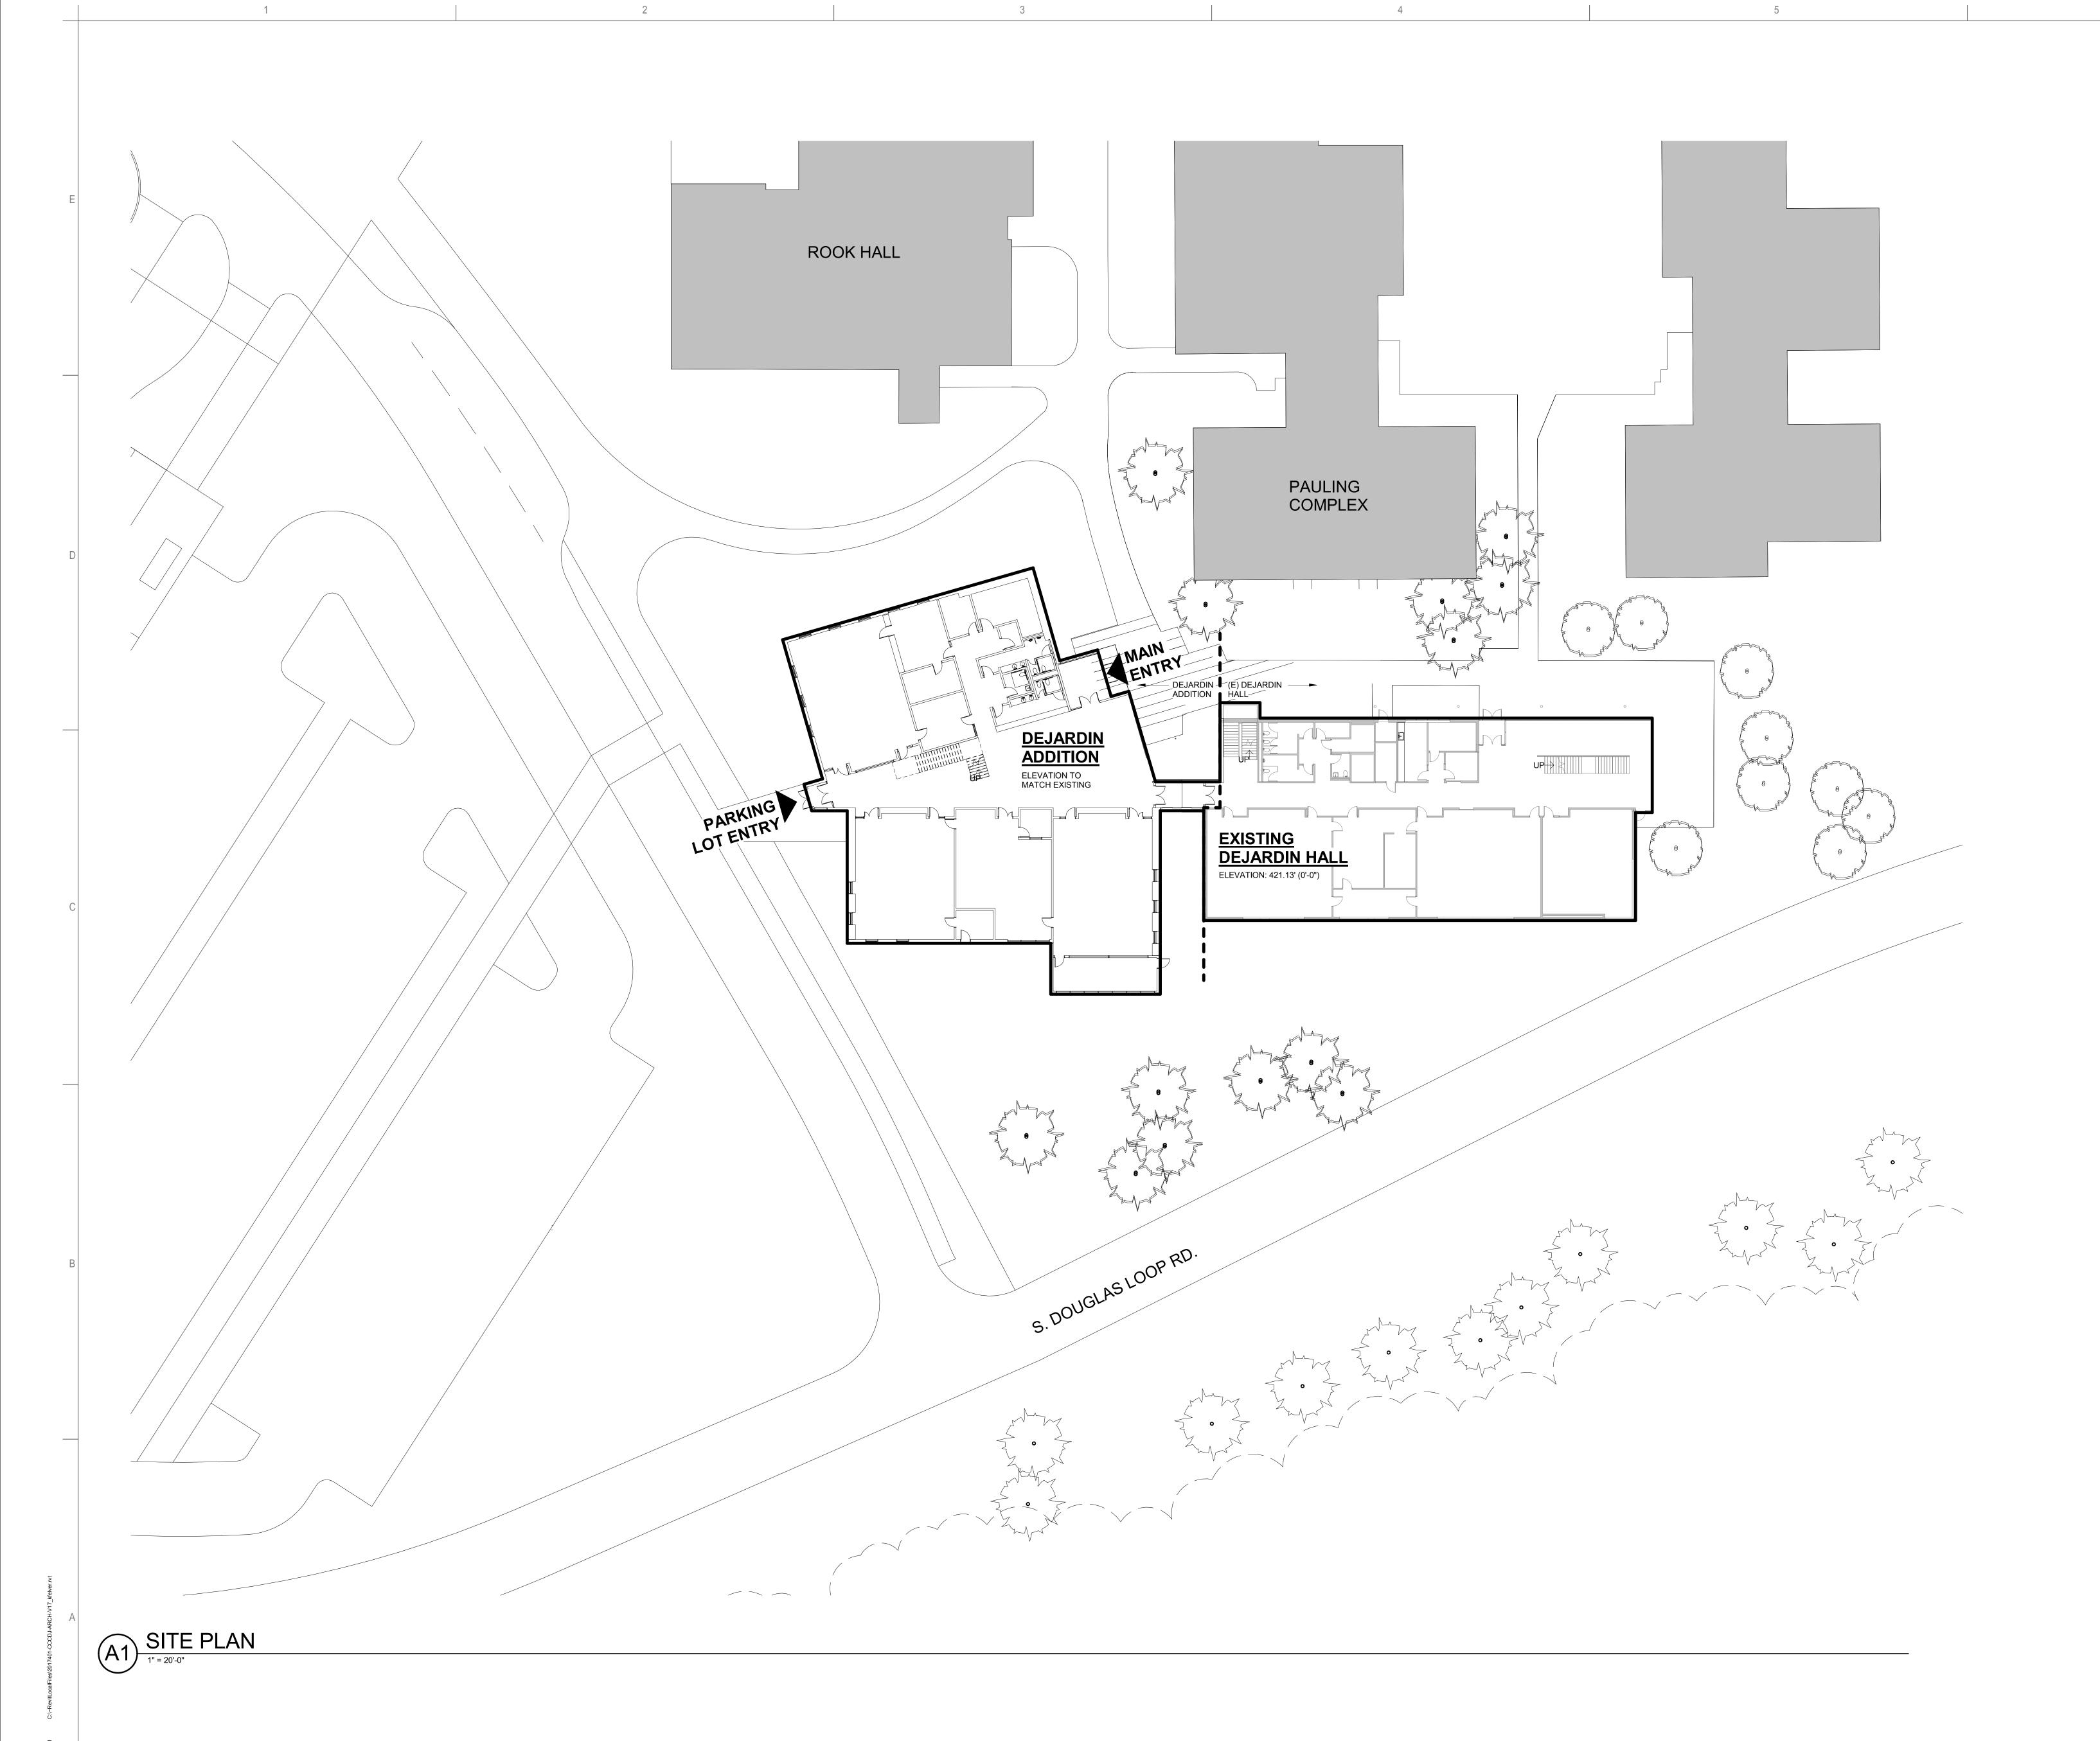



71 COLUMBIA | FLOOR 4 **SEATTLE** WA 98104 (206) 441-4151 OFFICE (206) 441-0478 FAX

1231 NW HOYT | SUITE 102 **PORTLAND** OR 97209 (503) 224-4032 OFFICE

MAHLUM ARCHITECTS INC

(503) 224-0918 FAX





CLACKAMAS COMMUNITY COLLEGE DEJARDIN ADDITION/RENOVATION

19600 MOLALLA AVE. OREGON CITY, OR 97045

MARK DAT

AUGUST 23,2017 SCHEMATIC DESIGN

PROJECT NO: 2017401

DRAWN BY: KF


CHECKED BY: KO


COPYRIGHT MAHILUM ARCHITECTS INC 2011 ORIGINAL SHEET SIZE: 30"x42"

A ARCHITECTURAL SITE PLAN

AN RTH

A-101

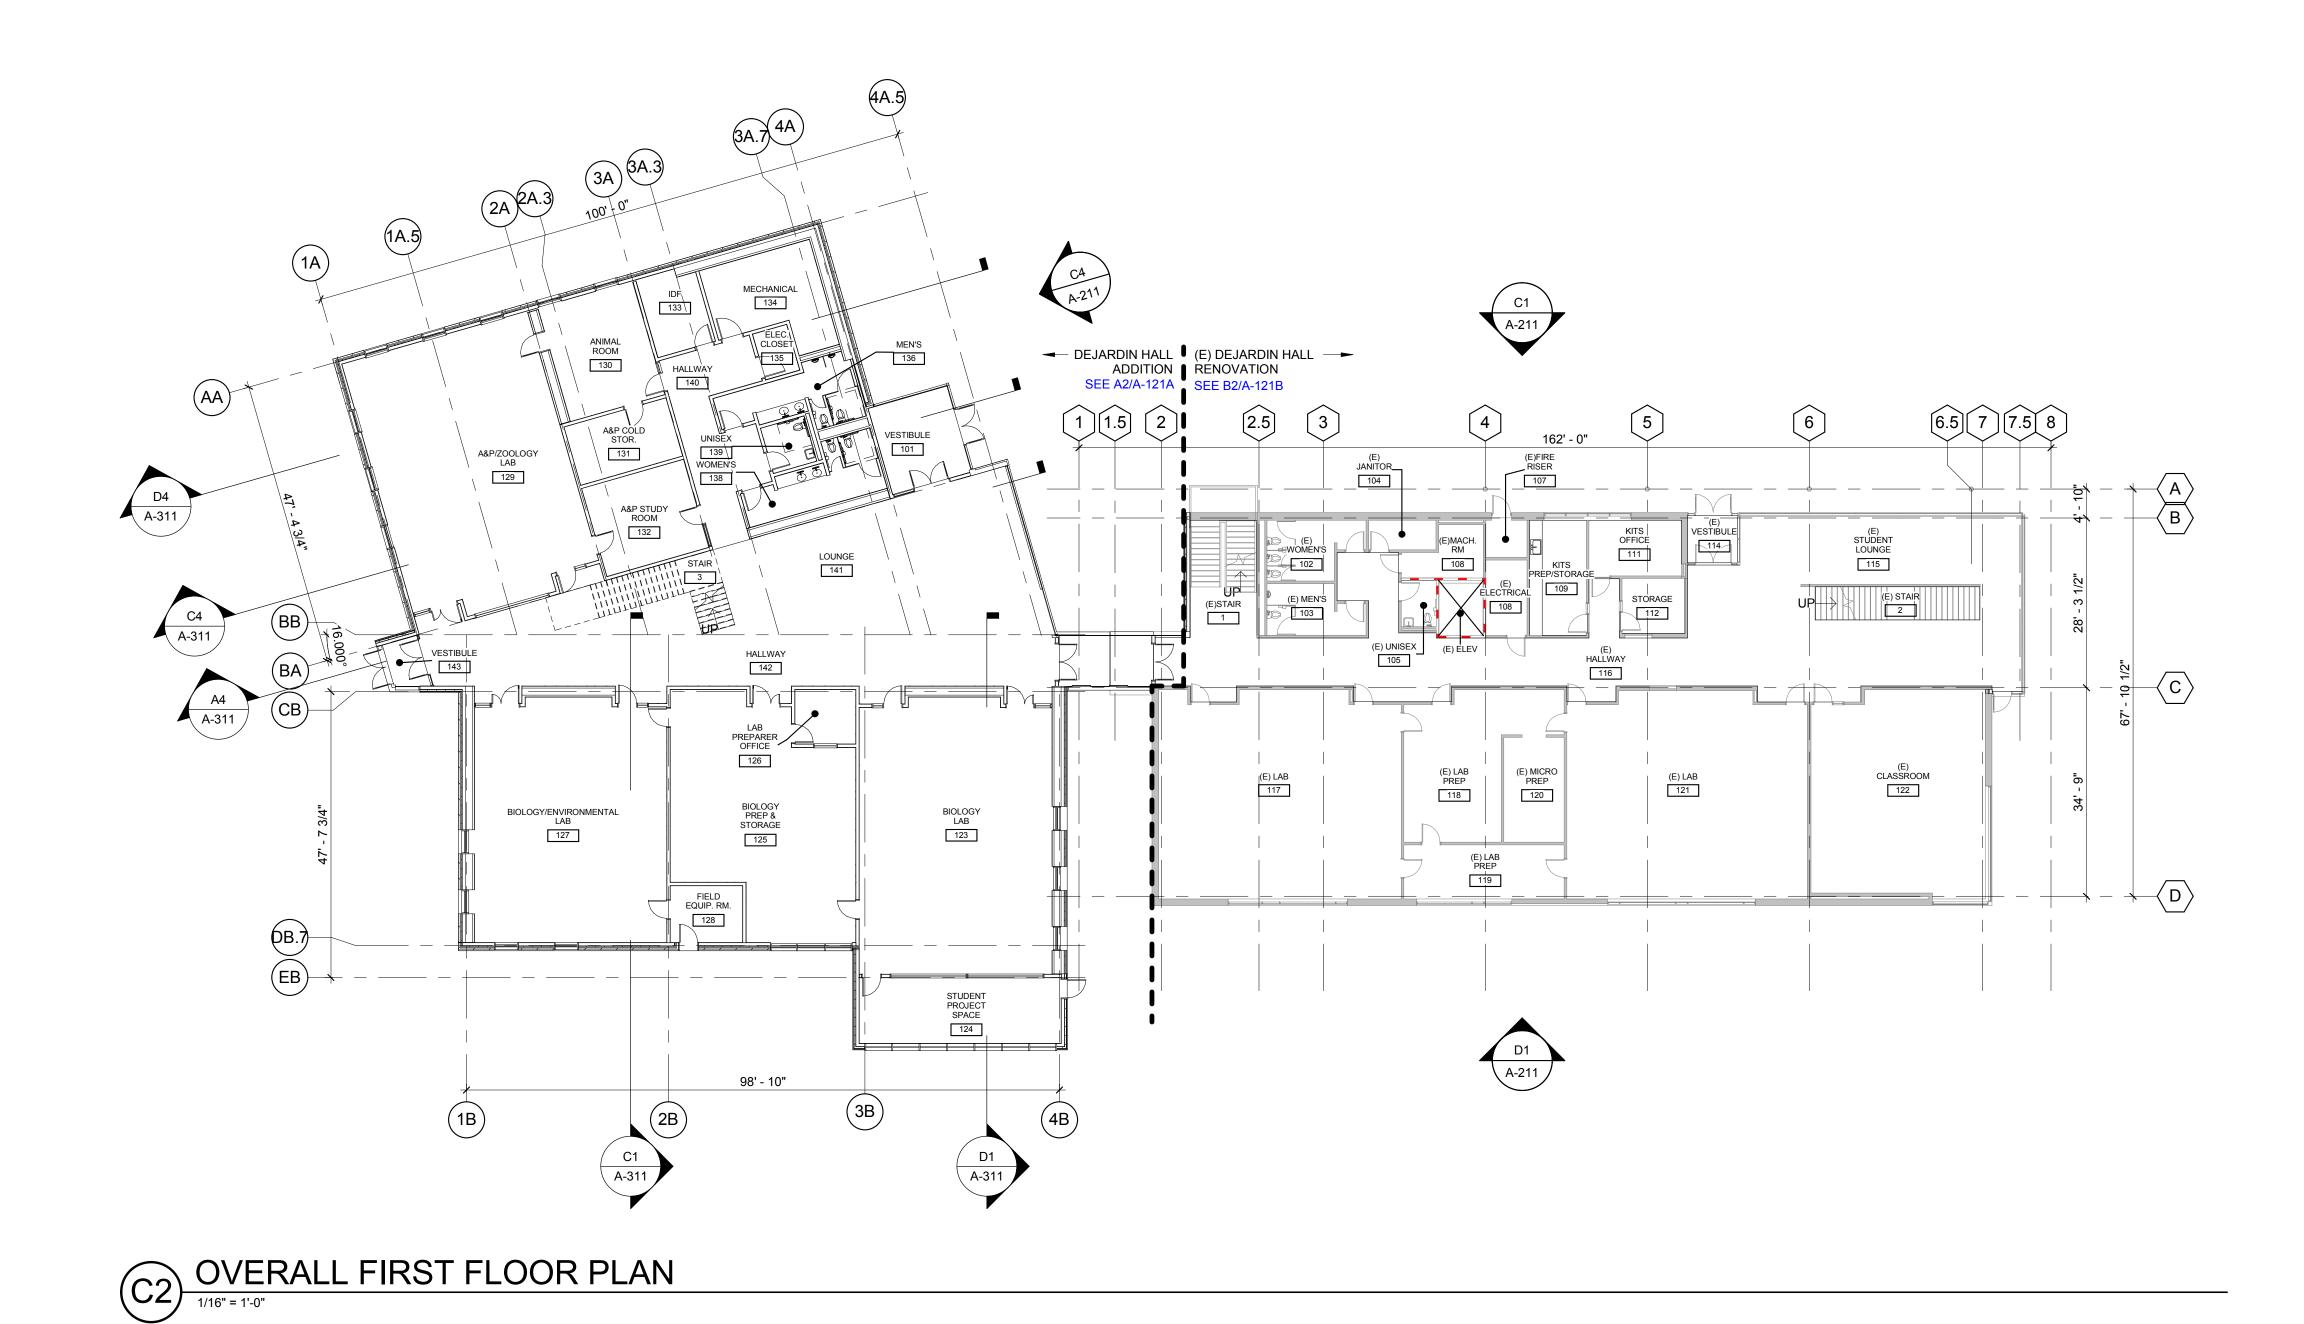

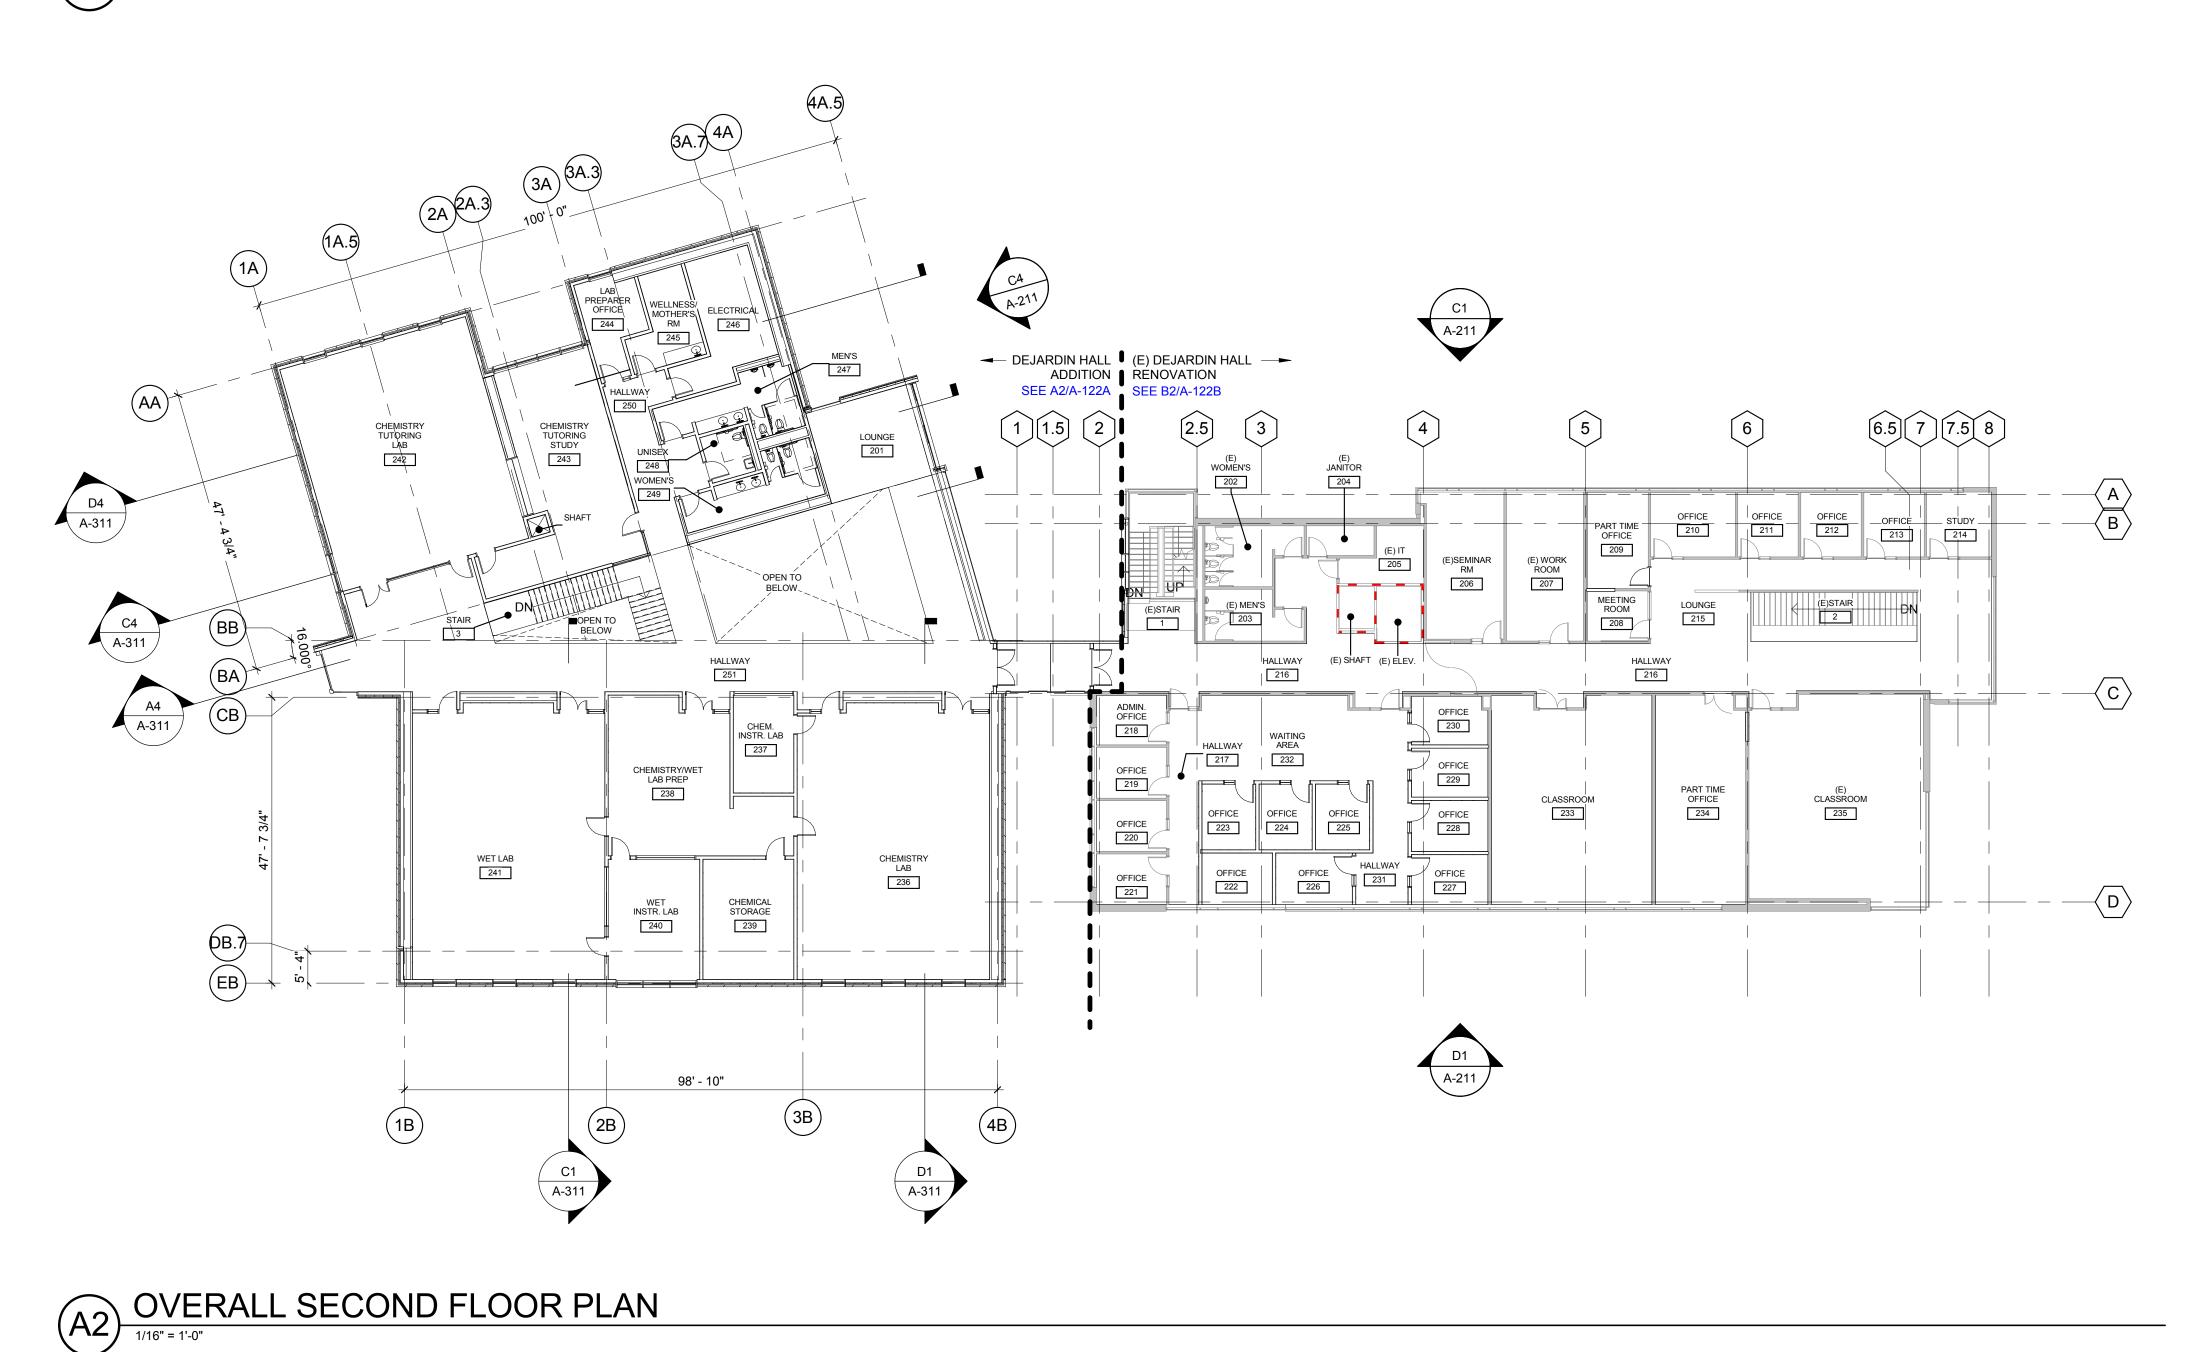


mahlum

71 COLUMBIA | FLOOR 4 **SEATTLE** WA 98104 (206) 441-4151 OFFICE (206) 441-0478 FAX

1231 NW HOYT | SUITE 102 **PORTLAND** OR 97209 (503) 224-4032 OFFICE

MAHLUM ARCHITECTS INC

(503) 224-0918 FAX

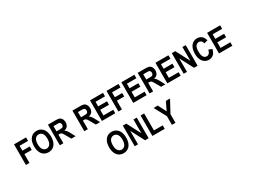



CLACKAMAS COMMUNITY COLLEGE DEJARDIN ADDITION/RENOVATION

19600 MOLALLA AVE. OREGON CITY, OR 97045

MARK DATE DESCRIPTION

ISSUE DATE: AUGUST 23,2017

ISSUE: SCHEMATIC DESIGN


PROJECT NO: 2017401

DRAWN BY: KF

CHECKED BY: KO

COPYRIGHT MAHLUM ARCHITECTS, INC. 2011 ORIGINAL SHEET SIZE: 30"x42"

A OVERALL FLOOR PLANS

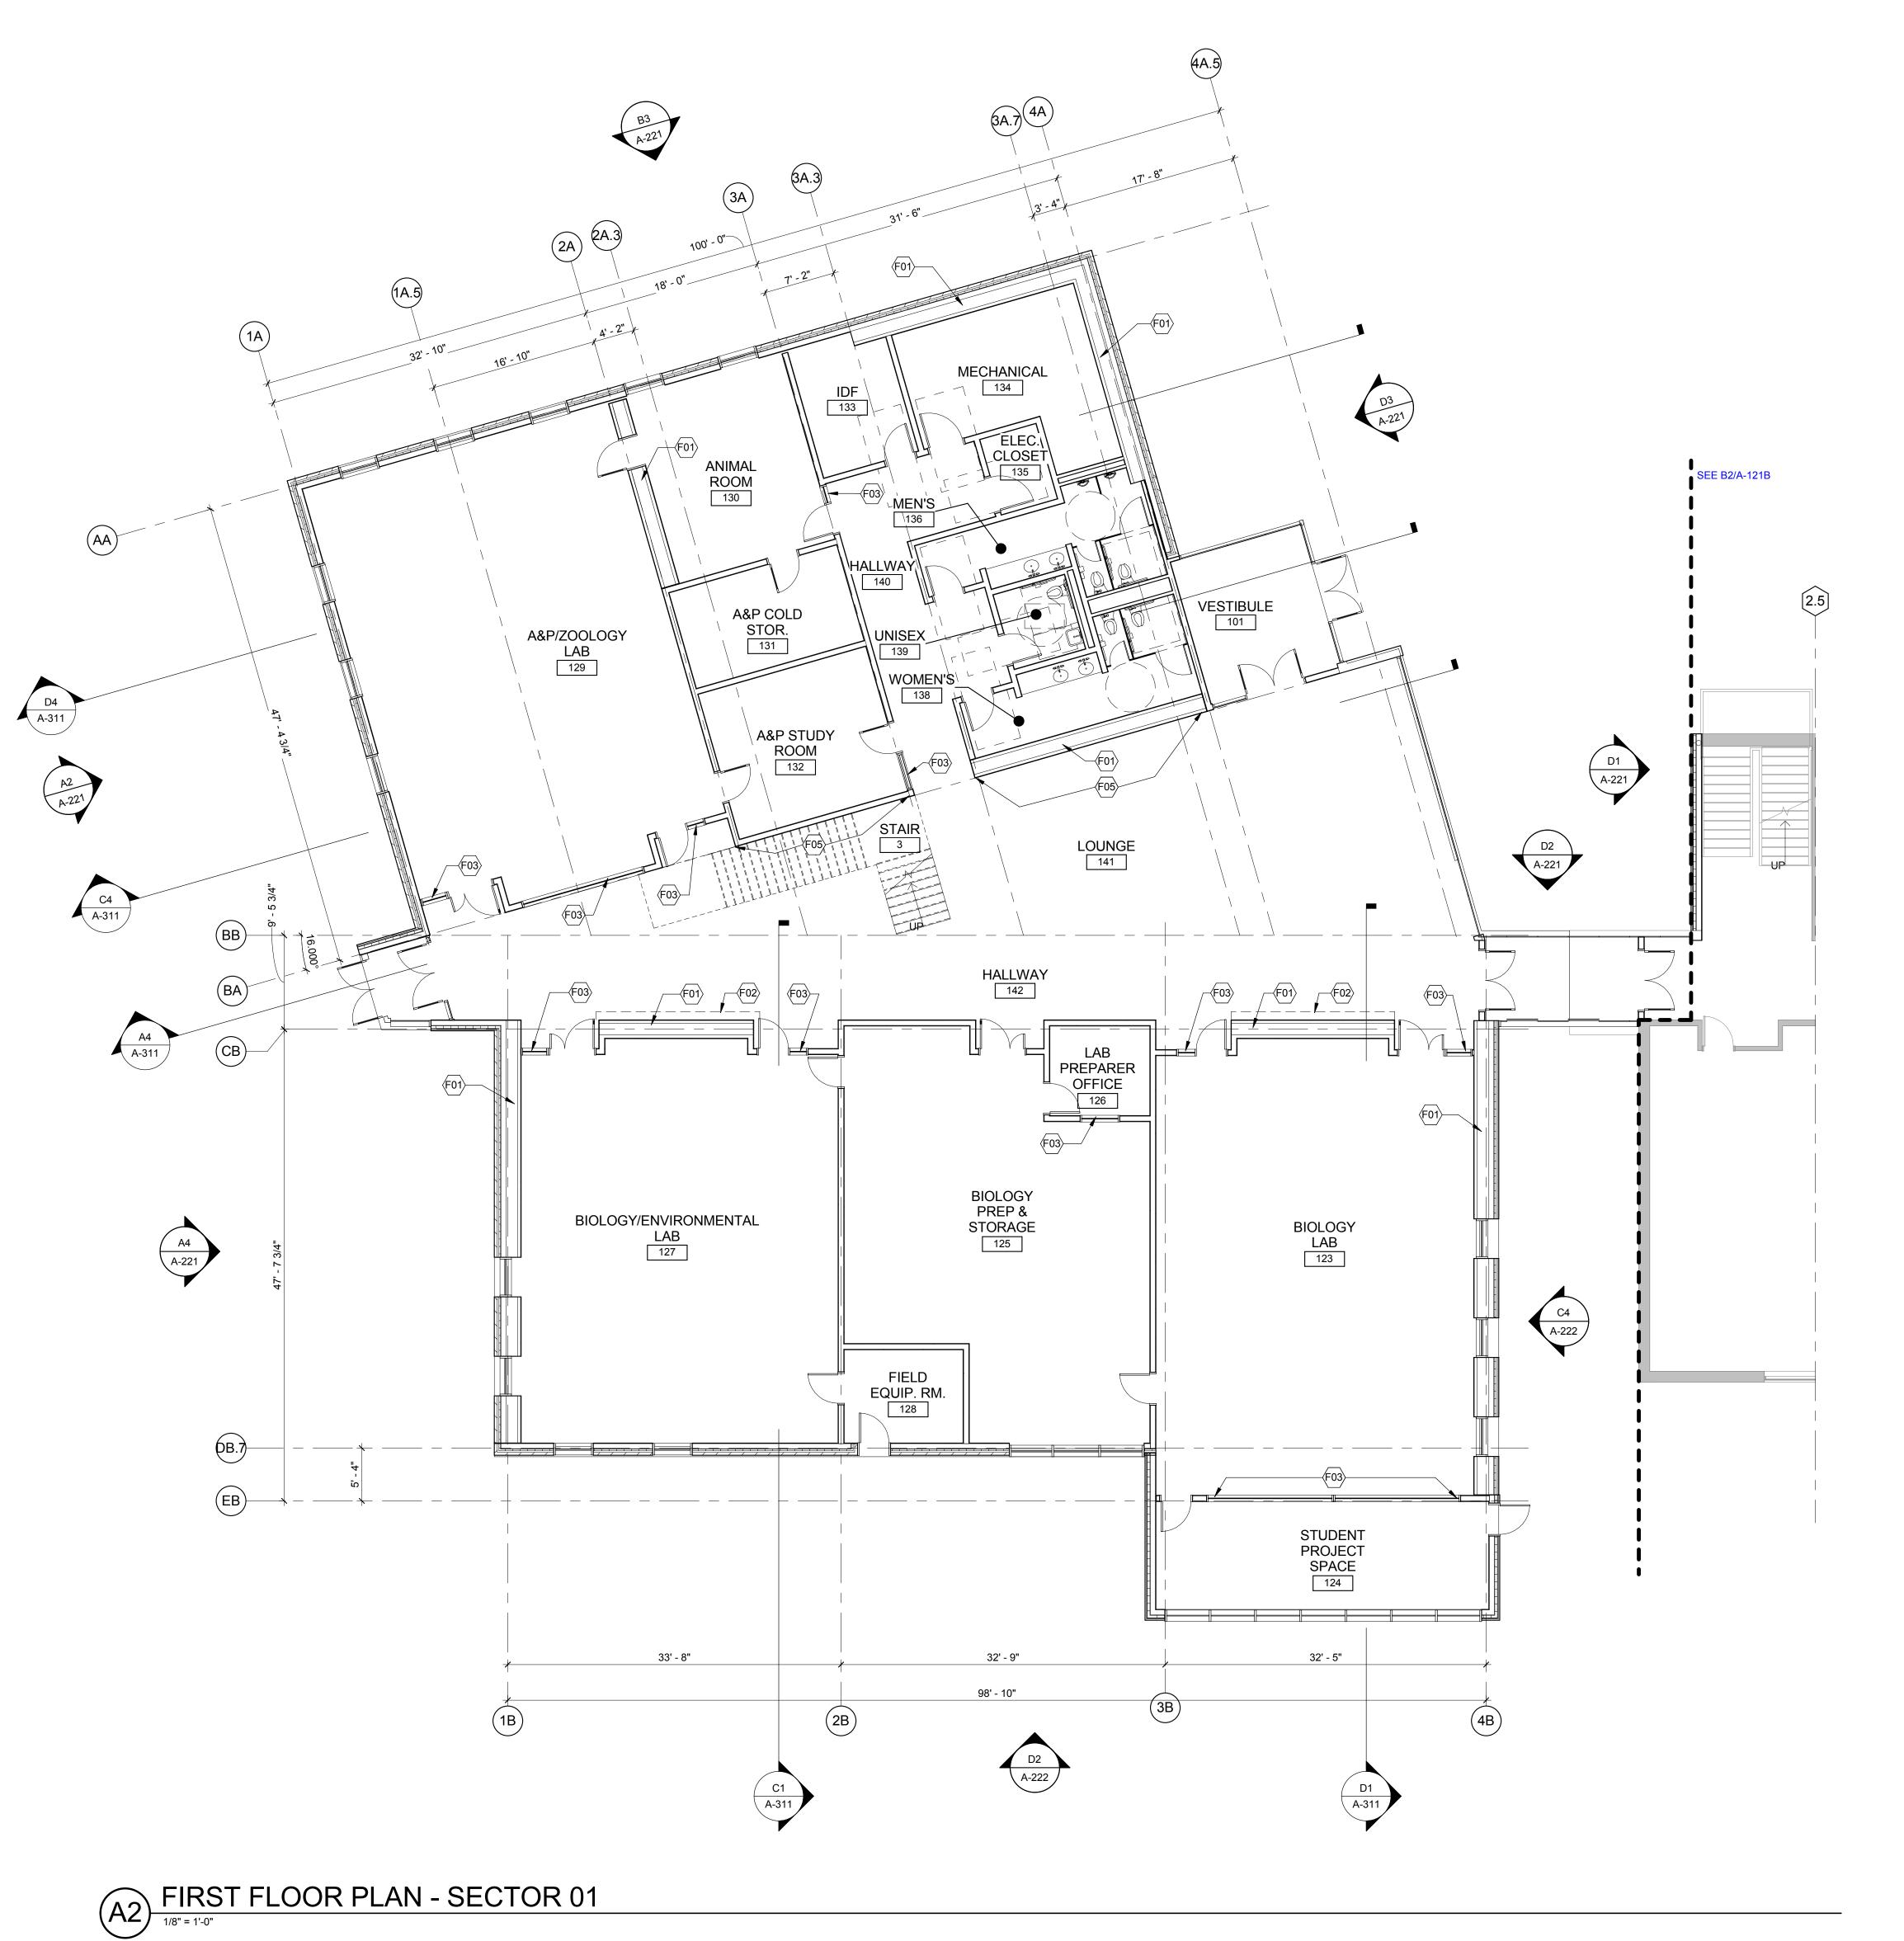

KEYNOTES

NUMBER NOTE

F01 METAL STUDS ON BOTH SIDES OF STRUCTURAL BRACE FRAME
F02 RECESSED DISPLAY CASE
F03 RE-LITE
F04 NEW SINK AND COUNTERTOP. PATCH-BACK CONCRETE SLAB WHERE
REMOVED FOR PIPING CONNECTION TO NEW SINK

TWO-STORY GRAPHIC APPLIED TO WALL

mahlum

71 COLUMBIA | FLOOR 4 **SEATTLE** WA 98104 (206) 441-4151 OFFICE (206) 441-0478 FAX

(503) 224-0918 FAX

1231 NW HOYT | SUITE 102 **PORTLAND** OR 97209 (503) 224-4032 OFFICE

MAHLUM ARCHITECTS INC





CLACKAMAS COMMUNITY COLLEGE DEJARDIN ADDITION/RENOVATION

19600 MOLALLA AVE. OREGON CITY, OR 97045

MARK DATE DESCRIPTION

ISSUE DATE: AUGUST 23,2017
ISSUE: SCHEMATIC DESIGN

PROJECT NO: 201740

DRAWN BY: KI

CHECKED BY: KC

COPYRIGHT MAHLUM ARCHITECTS, INC. 2011 ORIGINAL SHEET SIZE: 30"x4

A FIRST FLOOR PLAN - SECTOR 01



KEYNOTES

NUMBER

F01 METAL STUDS ON E

F01	METAL STUDS ON BOTH SIDES OF STRUCTURAL BRACE FRAME
F02	RECESSED DISPLAY CASE
F03	RE-LITE
. • .	NEW SINK AND COUNTERTOP. PATCH-BACK CONCRETE SLAB WHERE REMOVED FOR PIPING CONNECTION TO NEW SINK
F05	TWO-STORY GRAPHIC APPLIED TO WALL


NOTE

mahlum

71 COLUMBIA | FLOOR 4 **SEATTLE** WA 98104
(206) 441-4151 OFFICE
(206) 441-0478 FAX

1231 NW HOYT | SUITE 102 PORTLAND OR 97209 (503) 224-4032 OFFICE (503) 224-0918 FAX

MAHLUM ARCHITECTS INC

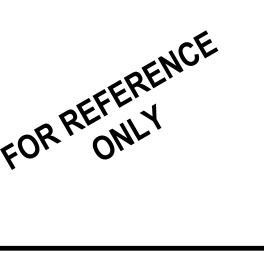



CLACKAMAS COMMUNITY COLLEGE DEJARDIN ADDITION/RENOVATION

19600 MOLALLA AVE. OREGON CITY, OR 97045

EGON CITY, OR 97045

MARK DATE DESCRIPTION

ISSUE DATE: AUGUST 23,2017
ISSUE: SCHEMATIC DESIGN

PROJECT NO: 2017401

DRAWN BY: KF


CHECKED BY: KO


COPYRIGHT MAHLUM ARCHITECTS, INC. 2011 ORIGINAL SHEET SIZE: 30"x42"

A FIRST FLOOR PLAN - SECTOR 02

PLAN NORTH

A-121B

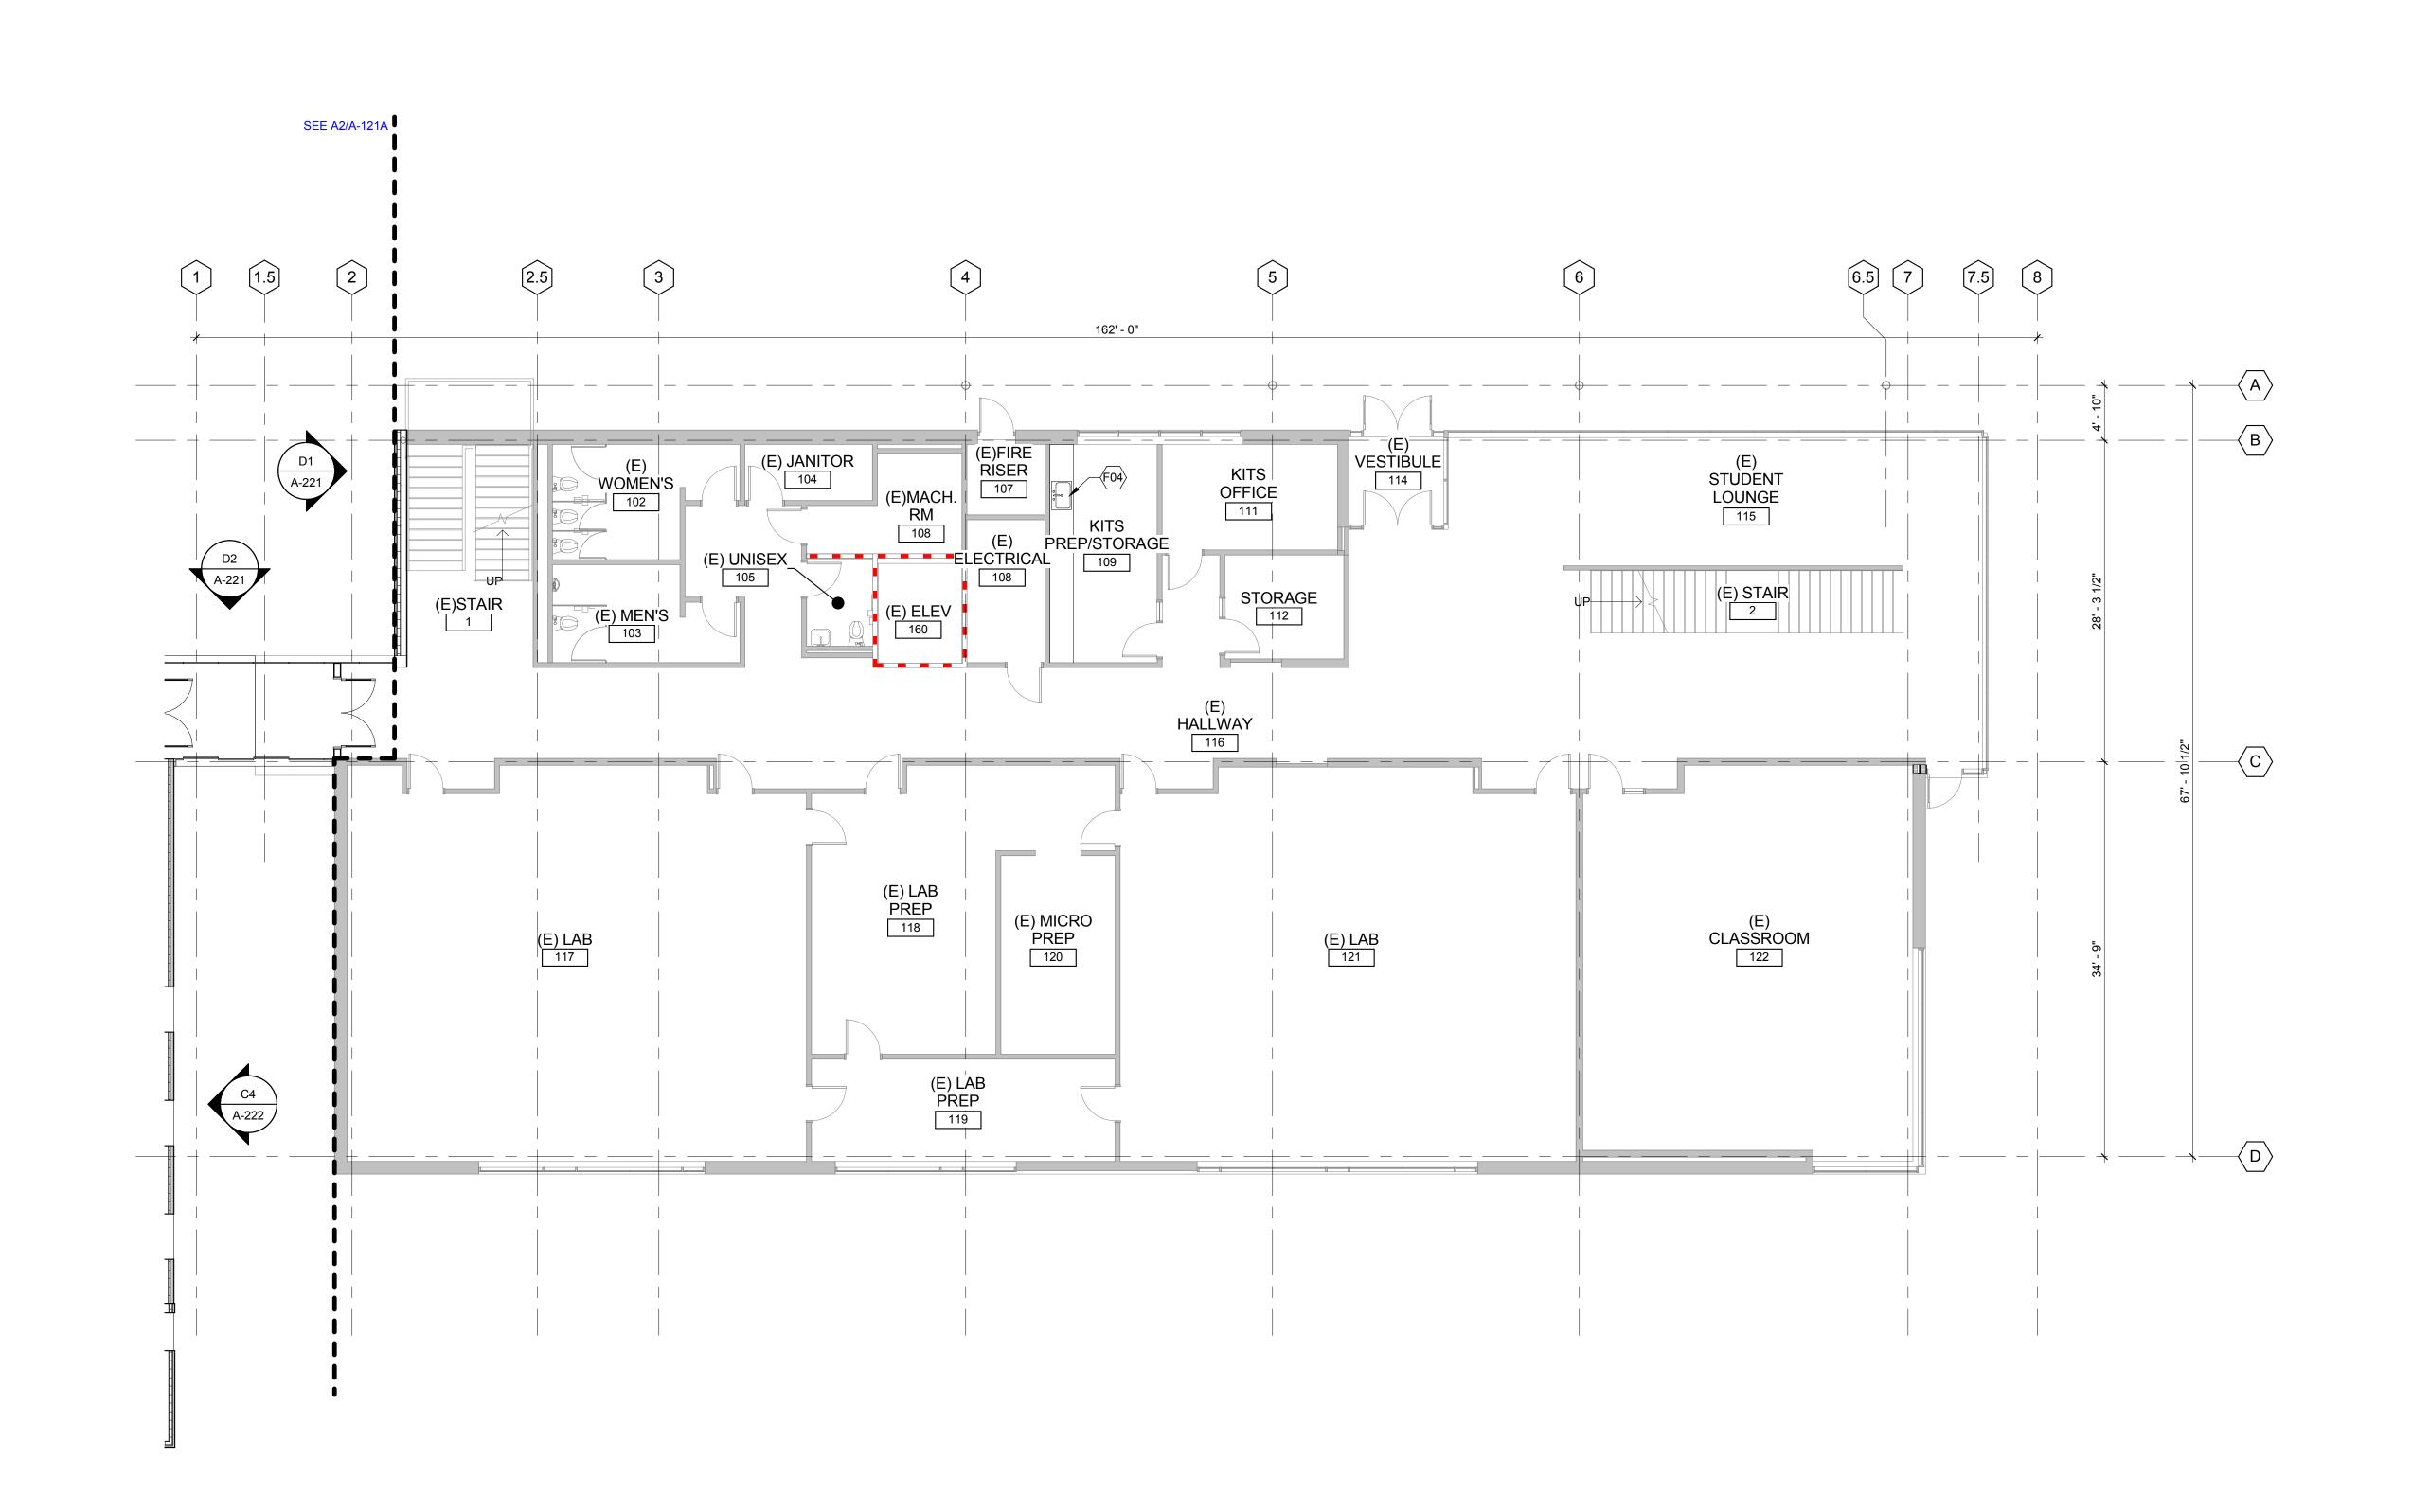

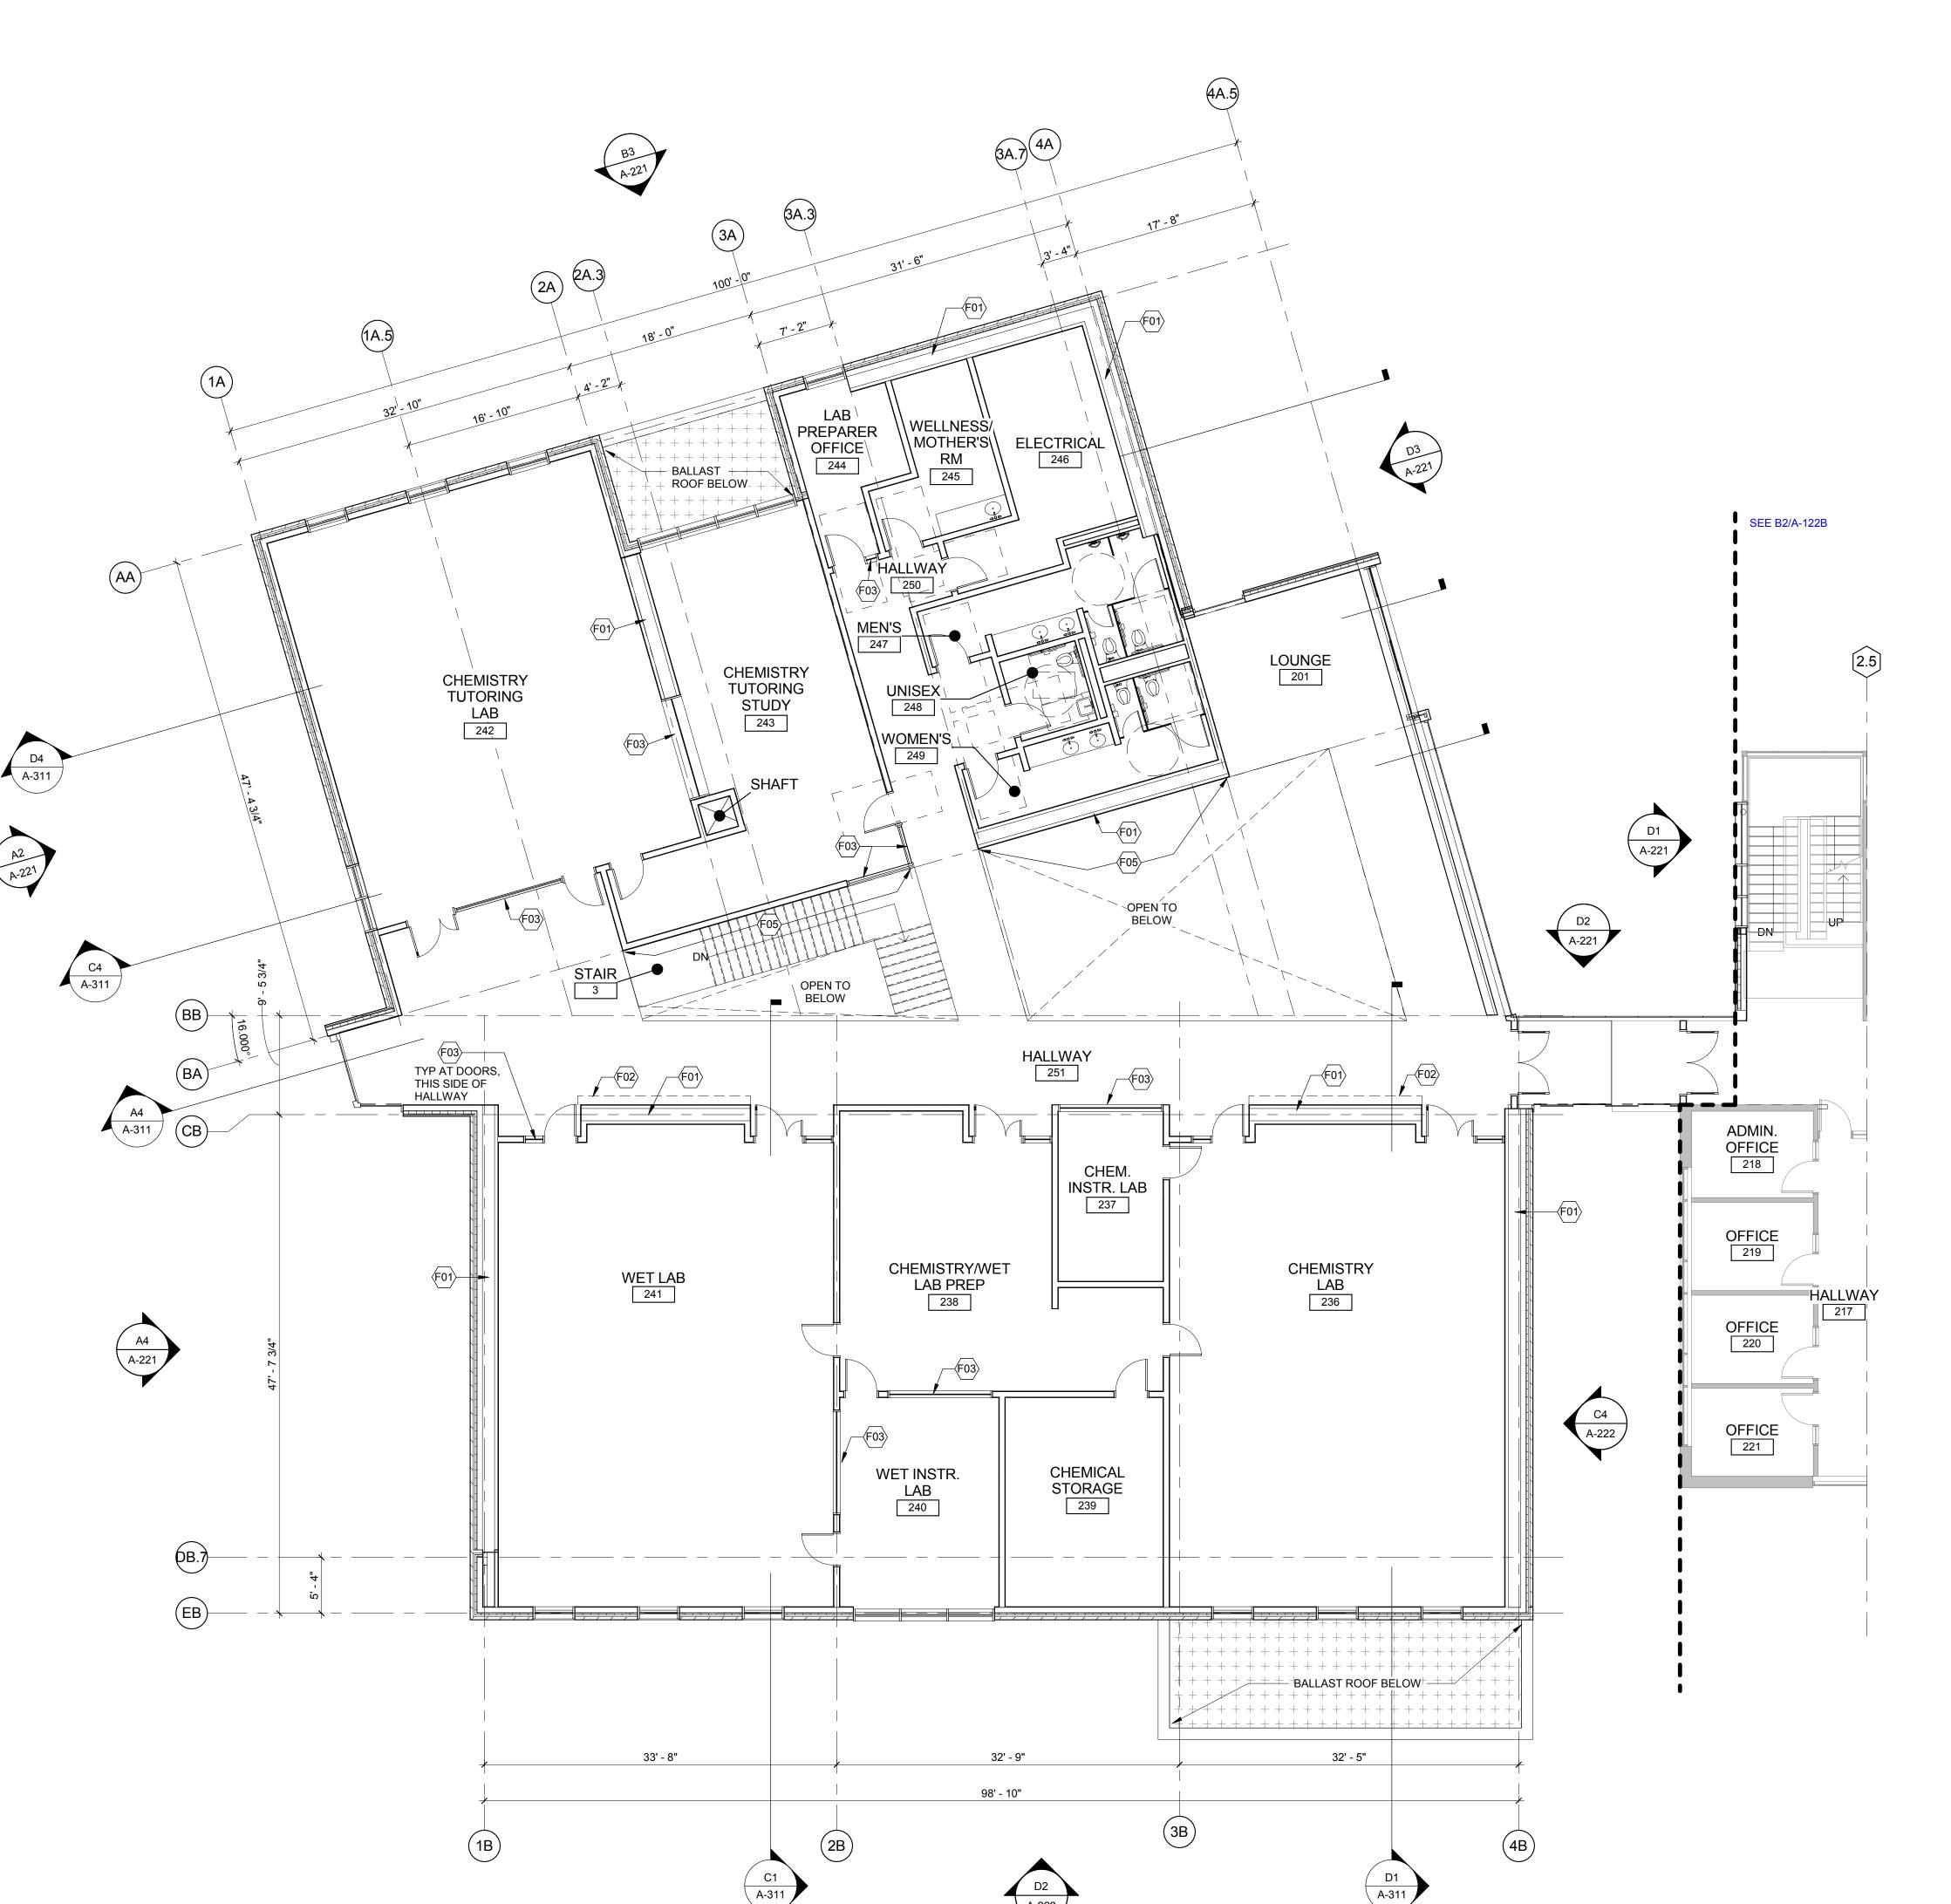

SECOND FLOOR PLAN - SECTOR 01

KEYNOTES

F01 METAL STUDS ON BOTH SIDES OF STRUCTURAL BRACE FRAME
F02 RECESSED DISPLAY CASE

F02 RECESSED DISPLAY CASE
F03 RE-LITE
F04 NEW SINK AND COUNTERTOP. PATCH-BACK CONCRETE SLAB WHERE REMOVED FOR PIPING CONNECTION TO NEW SINK
F05 TWO-STORY GRAPHIC APPLIED TO WALL

ACK CONCRETE SLAB WHERE
DINEW SINK
L
71 COLUM

IIIuIIIUIII

71 COLUMBIA | FLOOR 4 **SEATTLE** WA 98104 (206) 441-4151 OFFICE (206) 441-0478 FAX

MAHLUM ARCHITECTS INC

1231 NW HOYT | SUITE 102 PORTLAND OR 97209 (503) 224-4032 OFFICE (503) 224-0918 FAX

ORREFERENCE



CLACKAMAS COMMUNITY COLLEGE DEJARDIN ADDITION/RENOVATION

19600 MOLALLA AVE. OREGON CITY, OR 97045

ISSUE DATE: AUGUST 23,2017
ISSUE: SCHEMATIC DESIGN

DESCRIPTION

PROJECT NO: 2017401

DRAWN BY: KF

CHECKED BY: KO

COPYRIGHT MAHLUM ARCHITECTS, INC. 2011 ORIGINAL SHEET SIZE: 30"x42"

A SECOND FLOOR PLAN - SECTOR 01

A-122A

KEYNOTES

NUMBER

NOTE

F01 METAL STUDS ON BOTH SIDES OF STRUCTURAL BRACE FRAME
F02 RECESSED DISPLAY CASE
F03 RE-LITE
F04 NEW SINK AND COUNTERTOP. PATCH-BACK CONCRETE SLAB WHERE
REMOVED FOR PIPING CONNECTION TO NEW SINK
F05 TWO-STORY GRAPHIC APPLIED TO WALL

mahlur

71 COLUMBIA | FLOOR 4 **SEATTLE** WA 98104
(206) 441-4151 OFFICE
(206) 441-0478 FAX

1231 NW HOYT | SUITE 102 **PORTLAND** OR 97209 (503) 224-4032 OFFICE (503) 224-0918 FAX

MAHLUM ARCHITECTS INC



SECOND FLOOR PLAN - SECTOR 02

FORREONLY



CLACKAMAS COMMUNITY COLLEGE DEJARDIN ADDITION/RENOVATION

19600 MOLALLA AVE. OREGON CITY, OR 97045

MARK DAT

ISSUE DATE: AUGUST 23,2017
ISSUE: SCHEMATIC DESIGN

DESCRIPTION

PROJECT NO: 2017401

DRAWN BY: KF

CHECKED BY: KO

COPYRIGHT MAHLUM ARCHITECTS, INC. 2011 ORIGINAL SHEET SIZE: 30"x42"

A SECOND FLOOR PLAN - SECTOR 02

PLAN NORTH

B2 OVERALL ROOF PLAN

1/16" = 1'-0"

mahlum

71 COLUMBIA | FLOOR 4 **SEATTLE** WA 98104
(206) 441-4151 OFFICE
(206) 441-0478 FAX

1231 NW HOYT | SUITE 102 PORTLAND OR 97209 (503) 224-4032 OFFICE (503) 224-0918 FAX

MAHLUM ARCHITECTS INC





CLACKAMAS COMMUNITY COLLEGE DEJARDIN ADDITION/RENOVATION

19600 MOLALLA AVE. OREGON CITY, OR 97045

MARK DATE DESCRIPTION

ISSUE DATE: AUGUST 23 2017

ISSUE DATE: AUGUST 23,2017
ISSUE: SCHEMATIC DESIGN


PROJECT NO: 2017401

DRAWN BY: KF

CHECKED BY: KO

COPYRIGHT MAHLUM ARCHITECTS, INC. 2011 ORIGINAL SHEET SIZE: 30"x42"

OVERALL ROOF PLAN

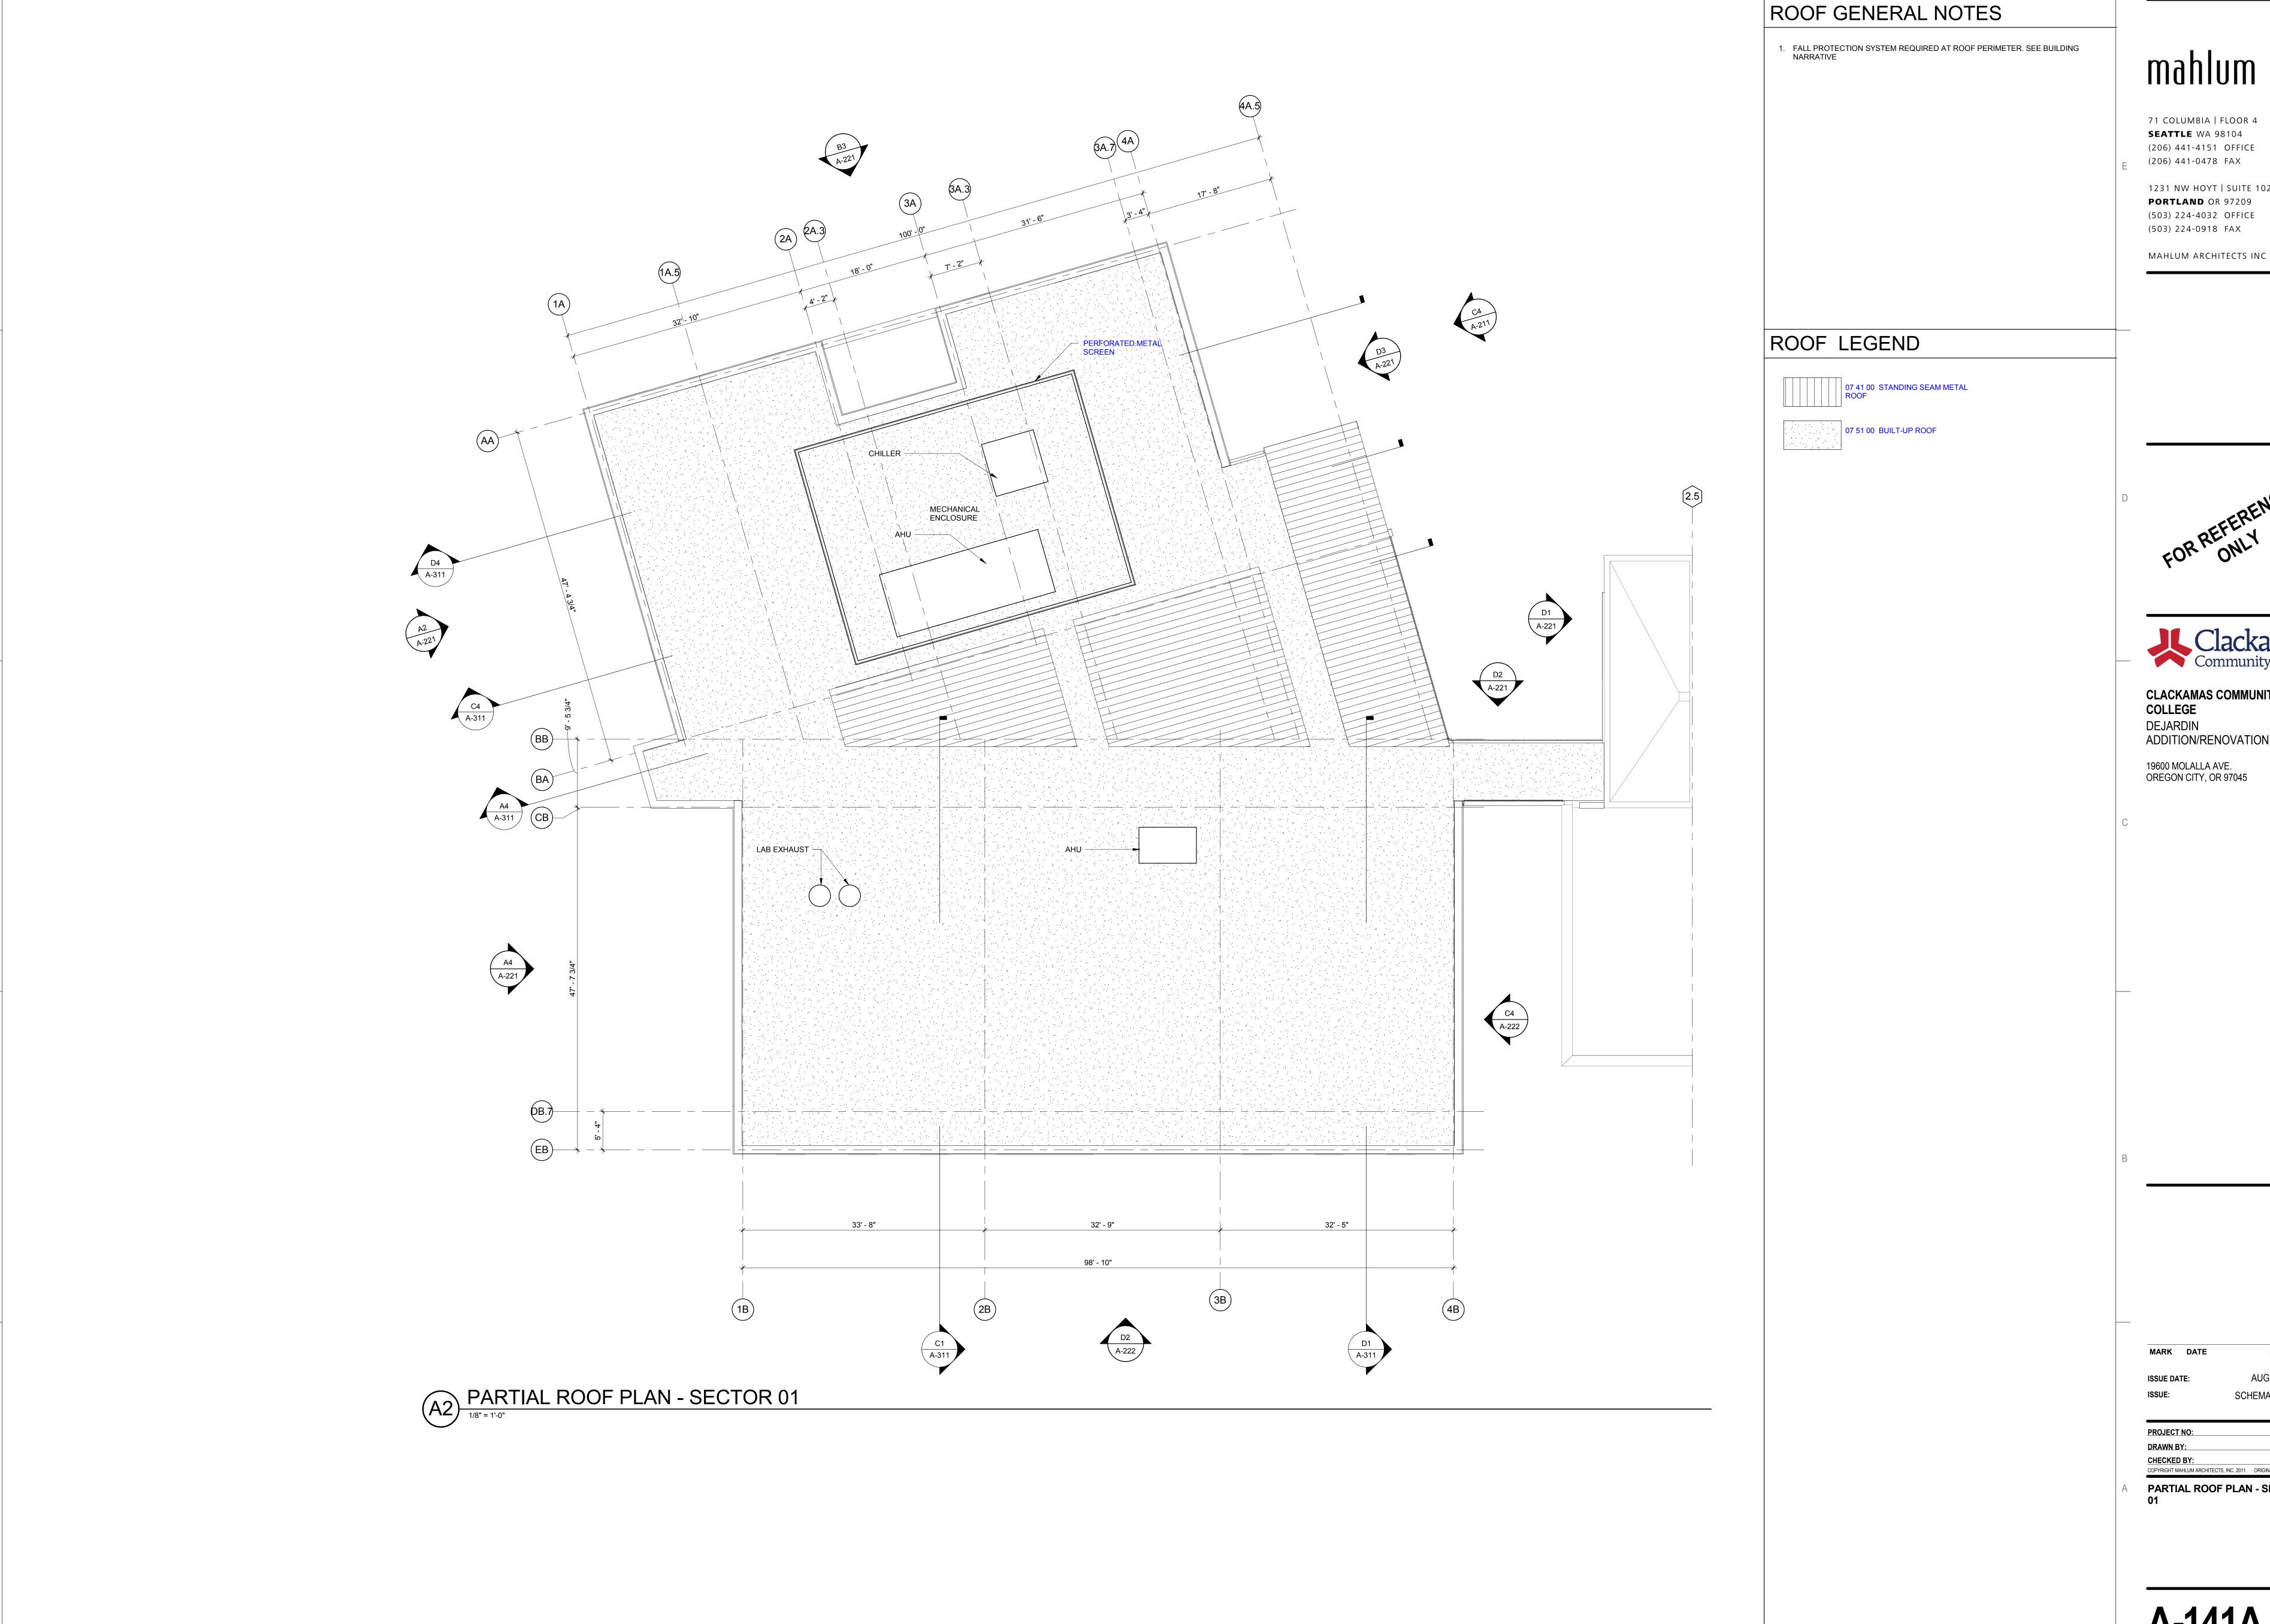

71 COLUMBIA | FLOOR 4 SEATTLE WA 98104 (206) 441-4151 OFFICE (206) 441-0478 FAX

1231 NW HOYT | SUITE 102 PORTLAND OR 97209 (503) 224-4032 OFFICE



CLACKAMAS COMMUNITY COLLEGE DEJARDIN ADDITION/RENOVATION


19600 MOLALLA AVE. OREGON CITY, OR 97045

AUGUST 23,2017 SCHEMATIC DESIGN

2017401

PARTIAL ROOF PLAN - SECTOR

A-141A

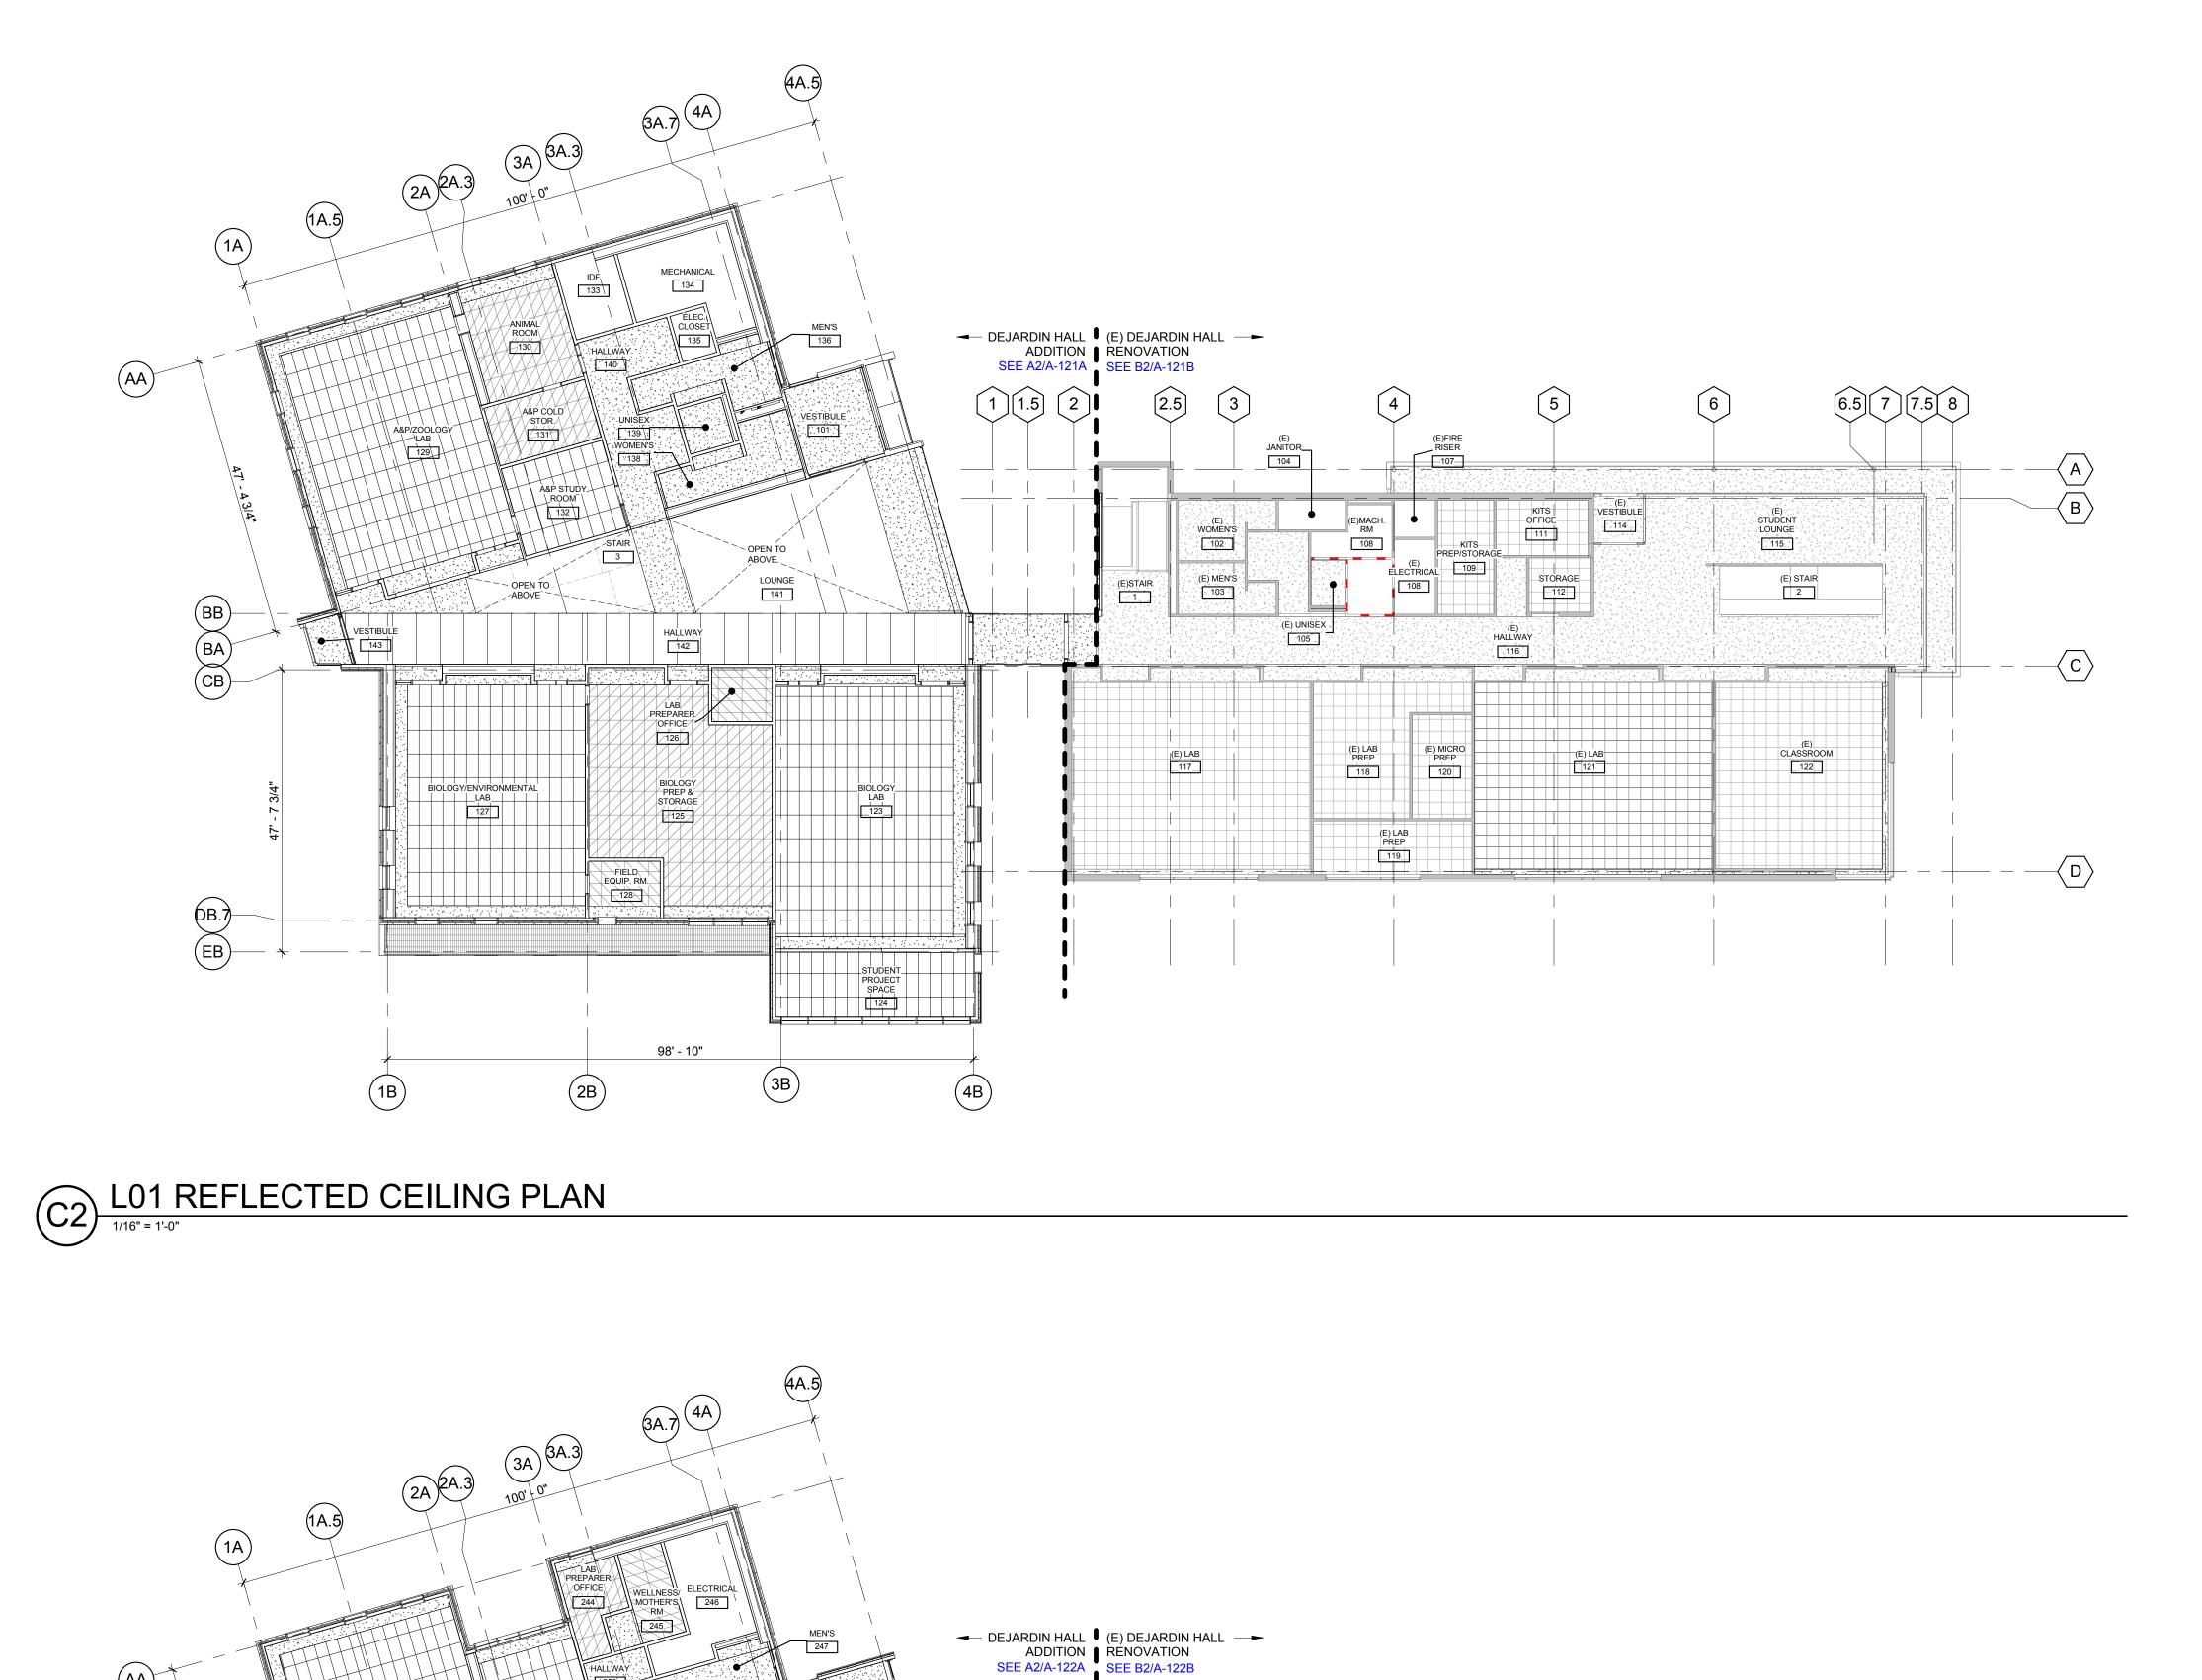



1. ALL CEILING SUSPENSION SYSTEMS SHALL HAVE SEISMIC RESTRAINTS THAT COMPLY WITH APPLICABLE CODES AND ORDINANCES IN FORCE AT TIME OF CONSTRUCTION

2. CENTER ITEMS IN CEILING TILES UNLESS OTHERWISE NOTED

71 COLUMBIA | FLOOR 4 SEATTLE WA 98104 (206) 441-4151 OFFICE (206) 441-0478 FAX

1231 NW HOYT | SUITE 102 PORTLAND OR 97209 (503) 224-4032 OFFICE

MAHLUM ARCHITECTS INC

(503) 224-0918 FAX

RCP MATERIAL LEGEND

09 21 16 GYPSUM WALLBOARD CEILING (PT-1) 09 51 00 ACOUSTICAL CEILING TILE-24X24 (ACT-1)

09 51 00 ACOUSTICAL CEILING TILE-24X48 (ACT-2)

09 51 00 ACOUSTICAL CEILING TILE-24X48 (ACT-3)

05 00 00 UNISTRUT OPEN-FRAMED SOFFIT WITH TECTUM AT UNDERSIDE OF SLAB/METAL DECKING



RCP SYMBOL LEGEND

8' - 6" CEILING HEIGHT FROM FINISH FLOOR





CLACKAMAS COMMUNITY COLLEGE DEJARDIN ADDITION/RENOVATION

19600 MOLALLA AVE. OREGON CITY, OR 97045

KEYNOTES

A

 $-\langle c \rangle$

(E) WORK ROOM

CLASSROOM 233

MEETING ROOM

HALLWAY

LOUNGE 215

PART TIME OFFICE

(E)STAIR

235

DESCRIPTION AUGUST 23,2017 SCHEMATIC DESIGN

2017401

REFLECTED CEILING PLAN

A-151


A2 L02 REFLECTED CEILING PLAN

1/16" = 1'-0"

HALLWAY 251

(AA) *

BB BA CB

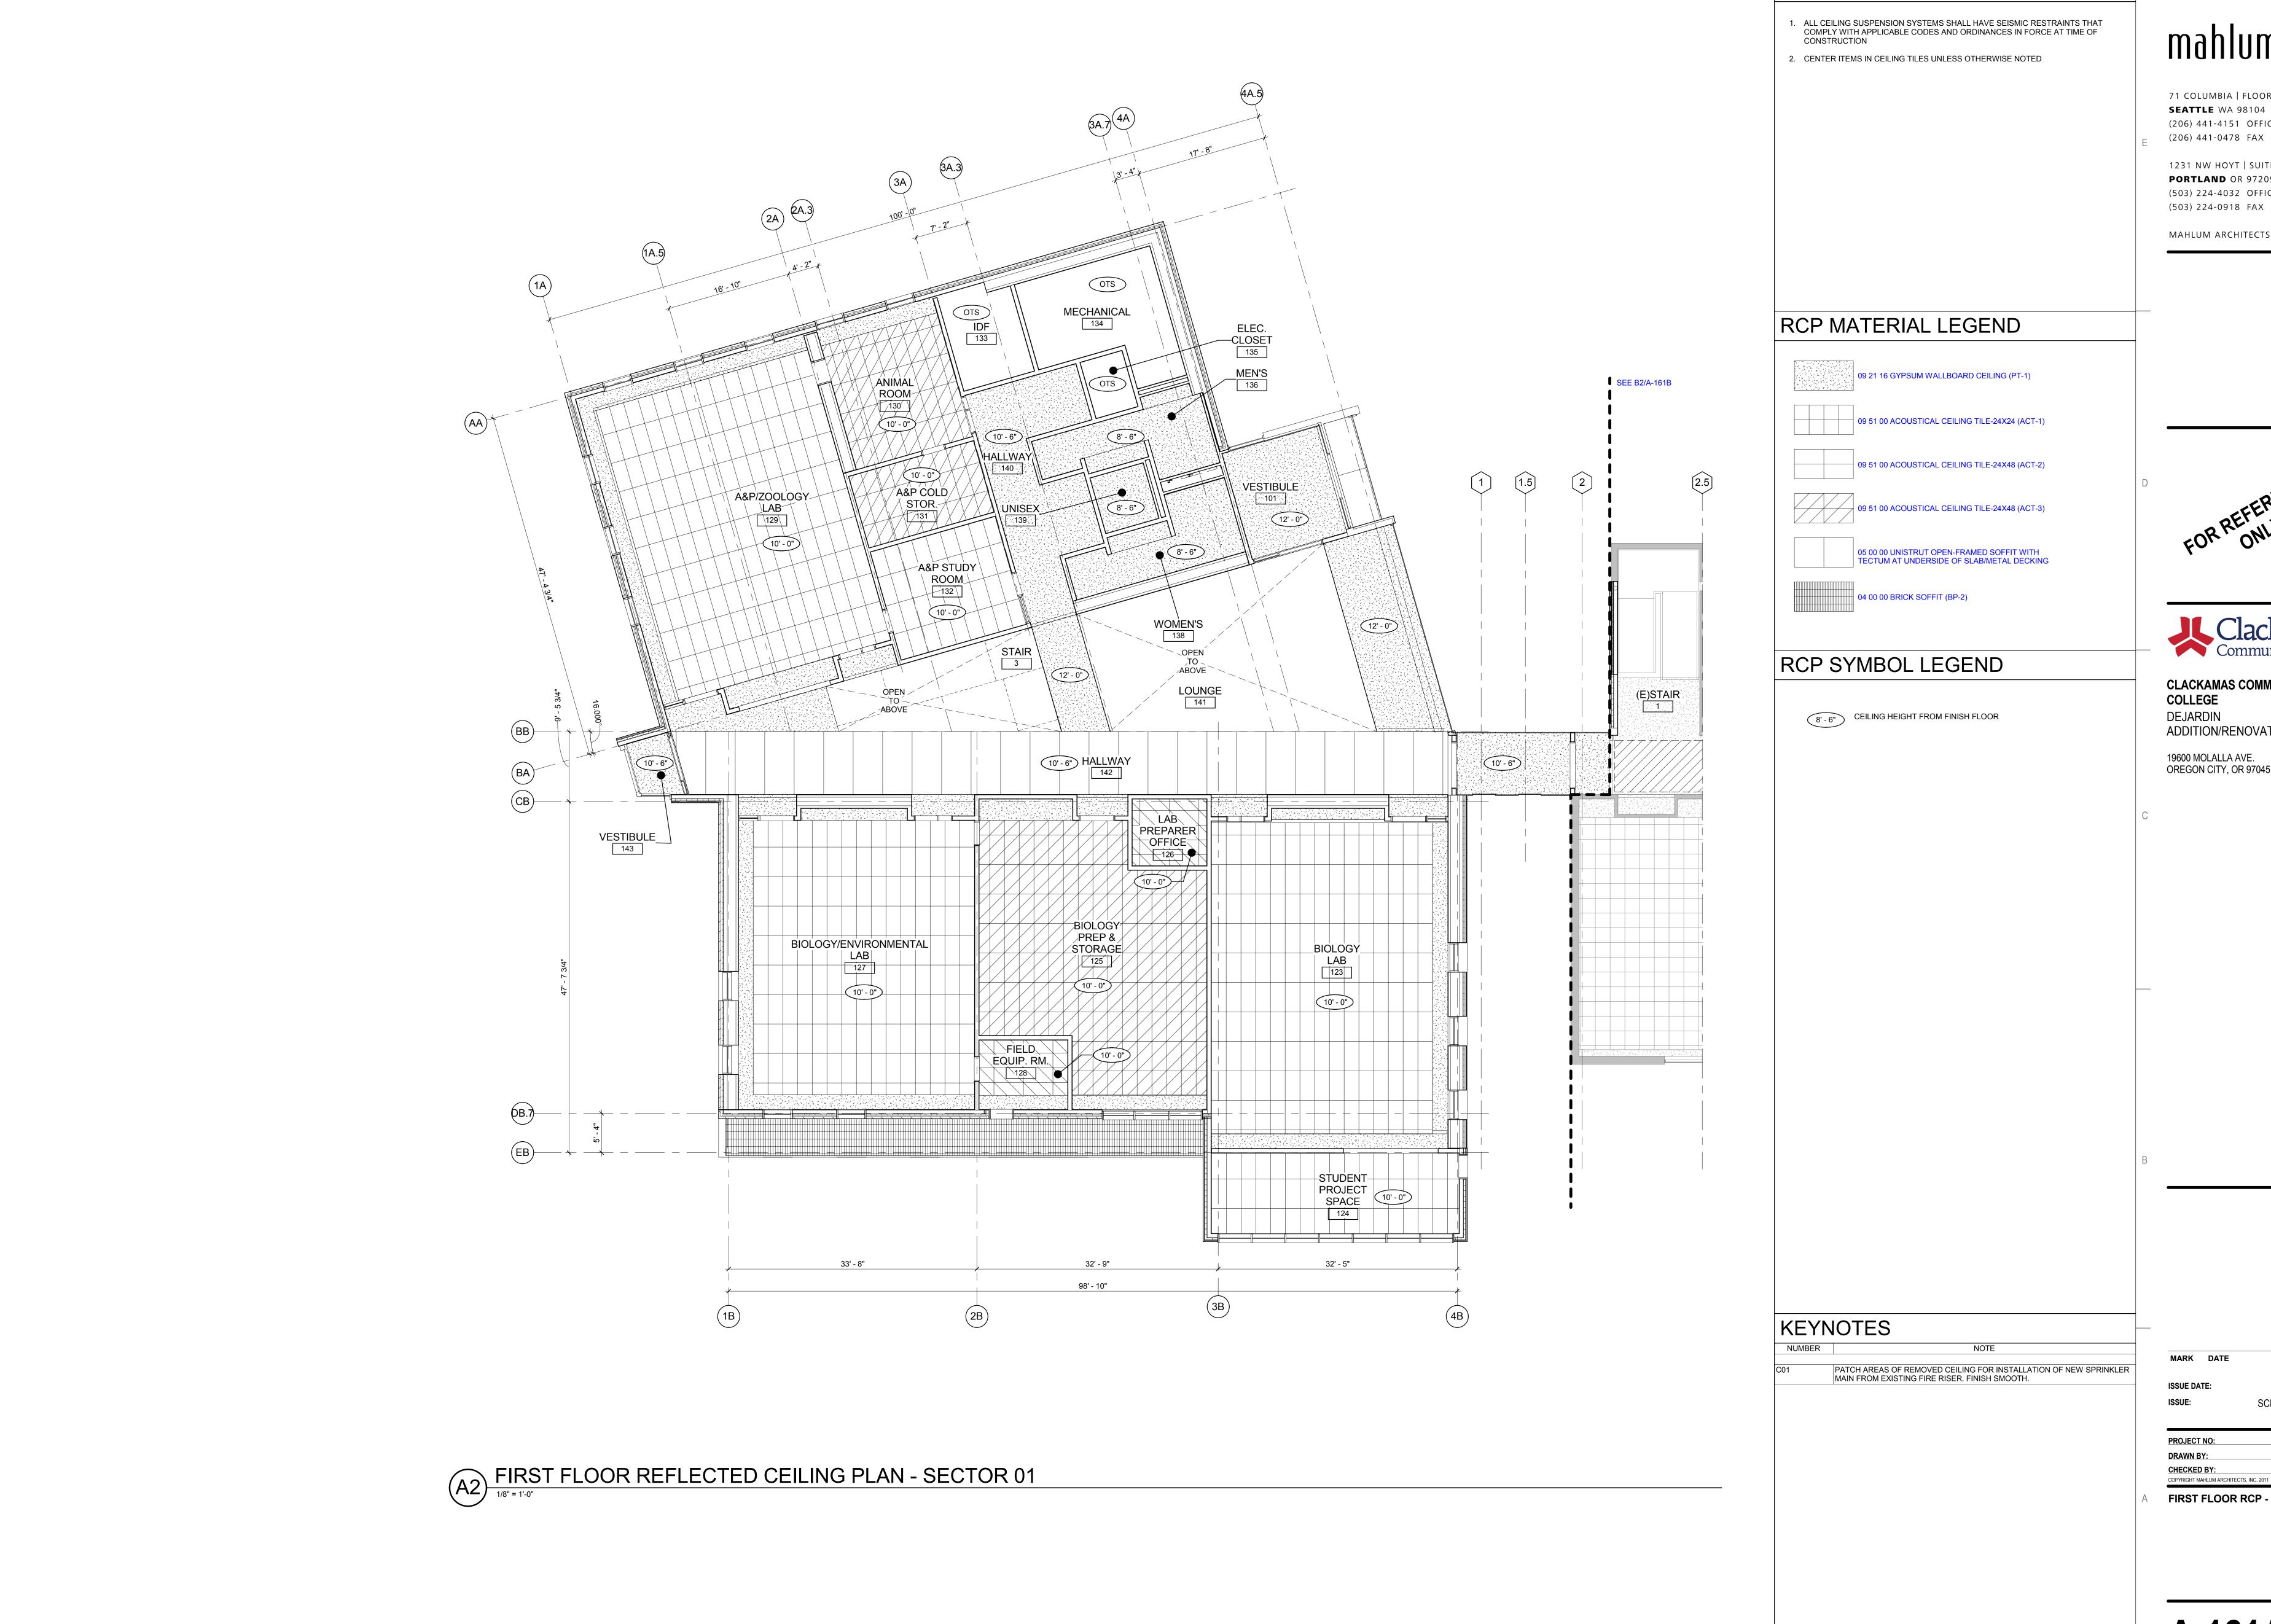

RCP GENERAL NOTES

71 COLUMBIA | FLOOR 4 SEATTLE WA 98104 (206) 441-4151 OFFICE (206) 441-0478 FAX

1231 NW HOYT | SUITE 102 PORTLAND OR 97209 (503) 224-4032 OFFICE

MAHLUM ARCHITECTS INC




CLACKAMAS COMMUNITY COLLEGE DEJARDIN ADDITION/RENOVATION

19600 MOLALLA AVE. OREGON CITY, OR 97045

DESCRIPTION AUGUST 23,2017

FIRST FLOOR RCP - SECTOR 01

A-161A

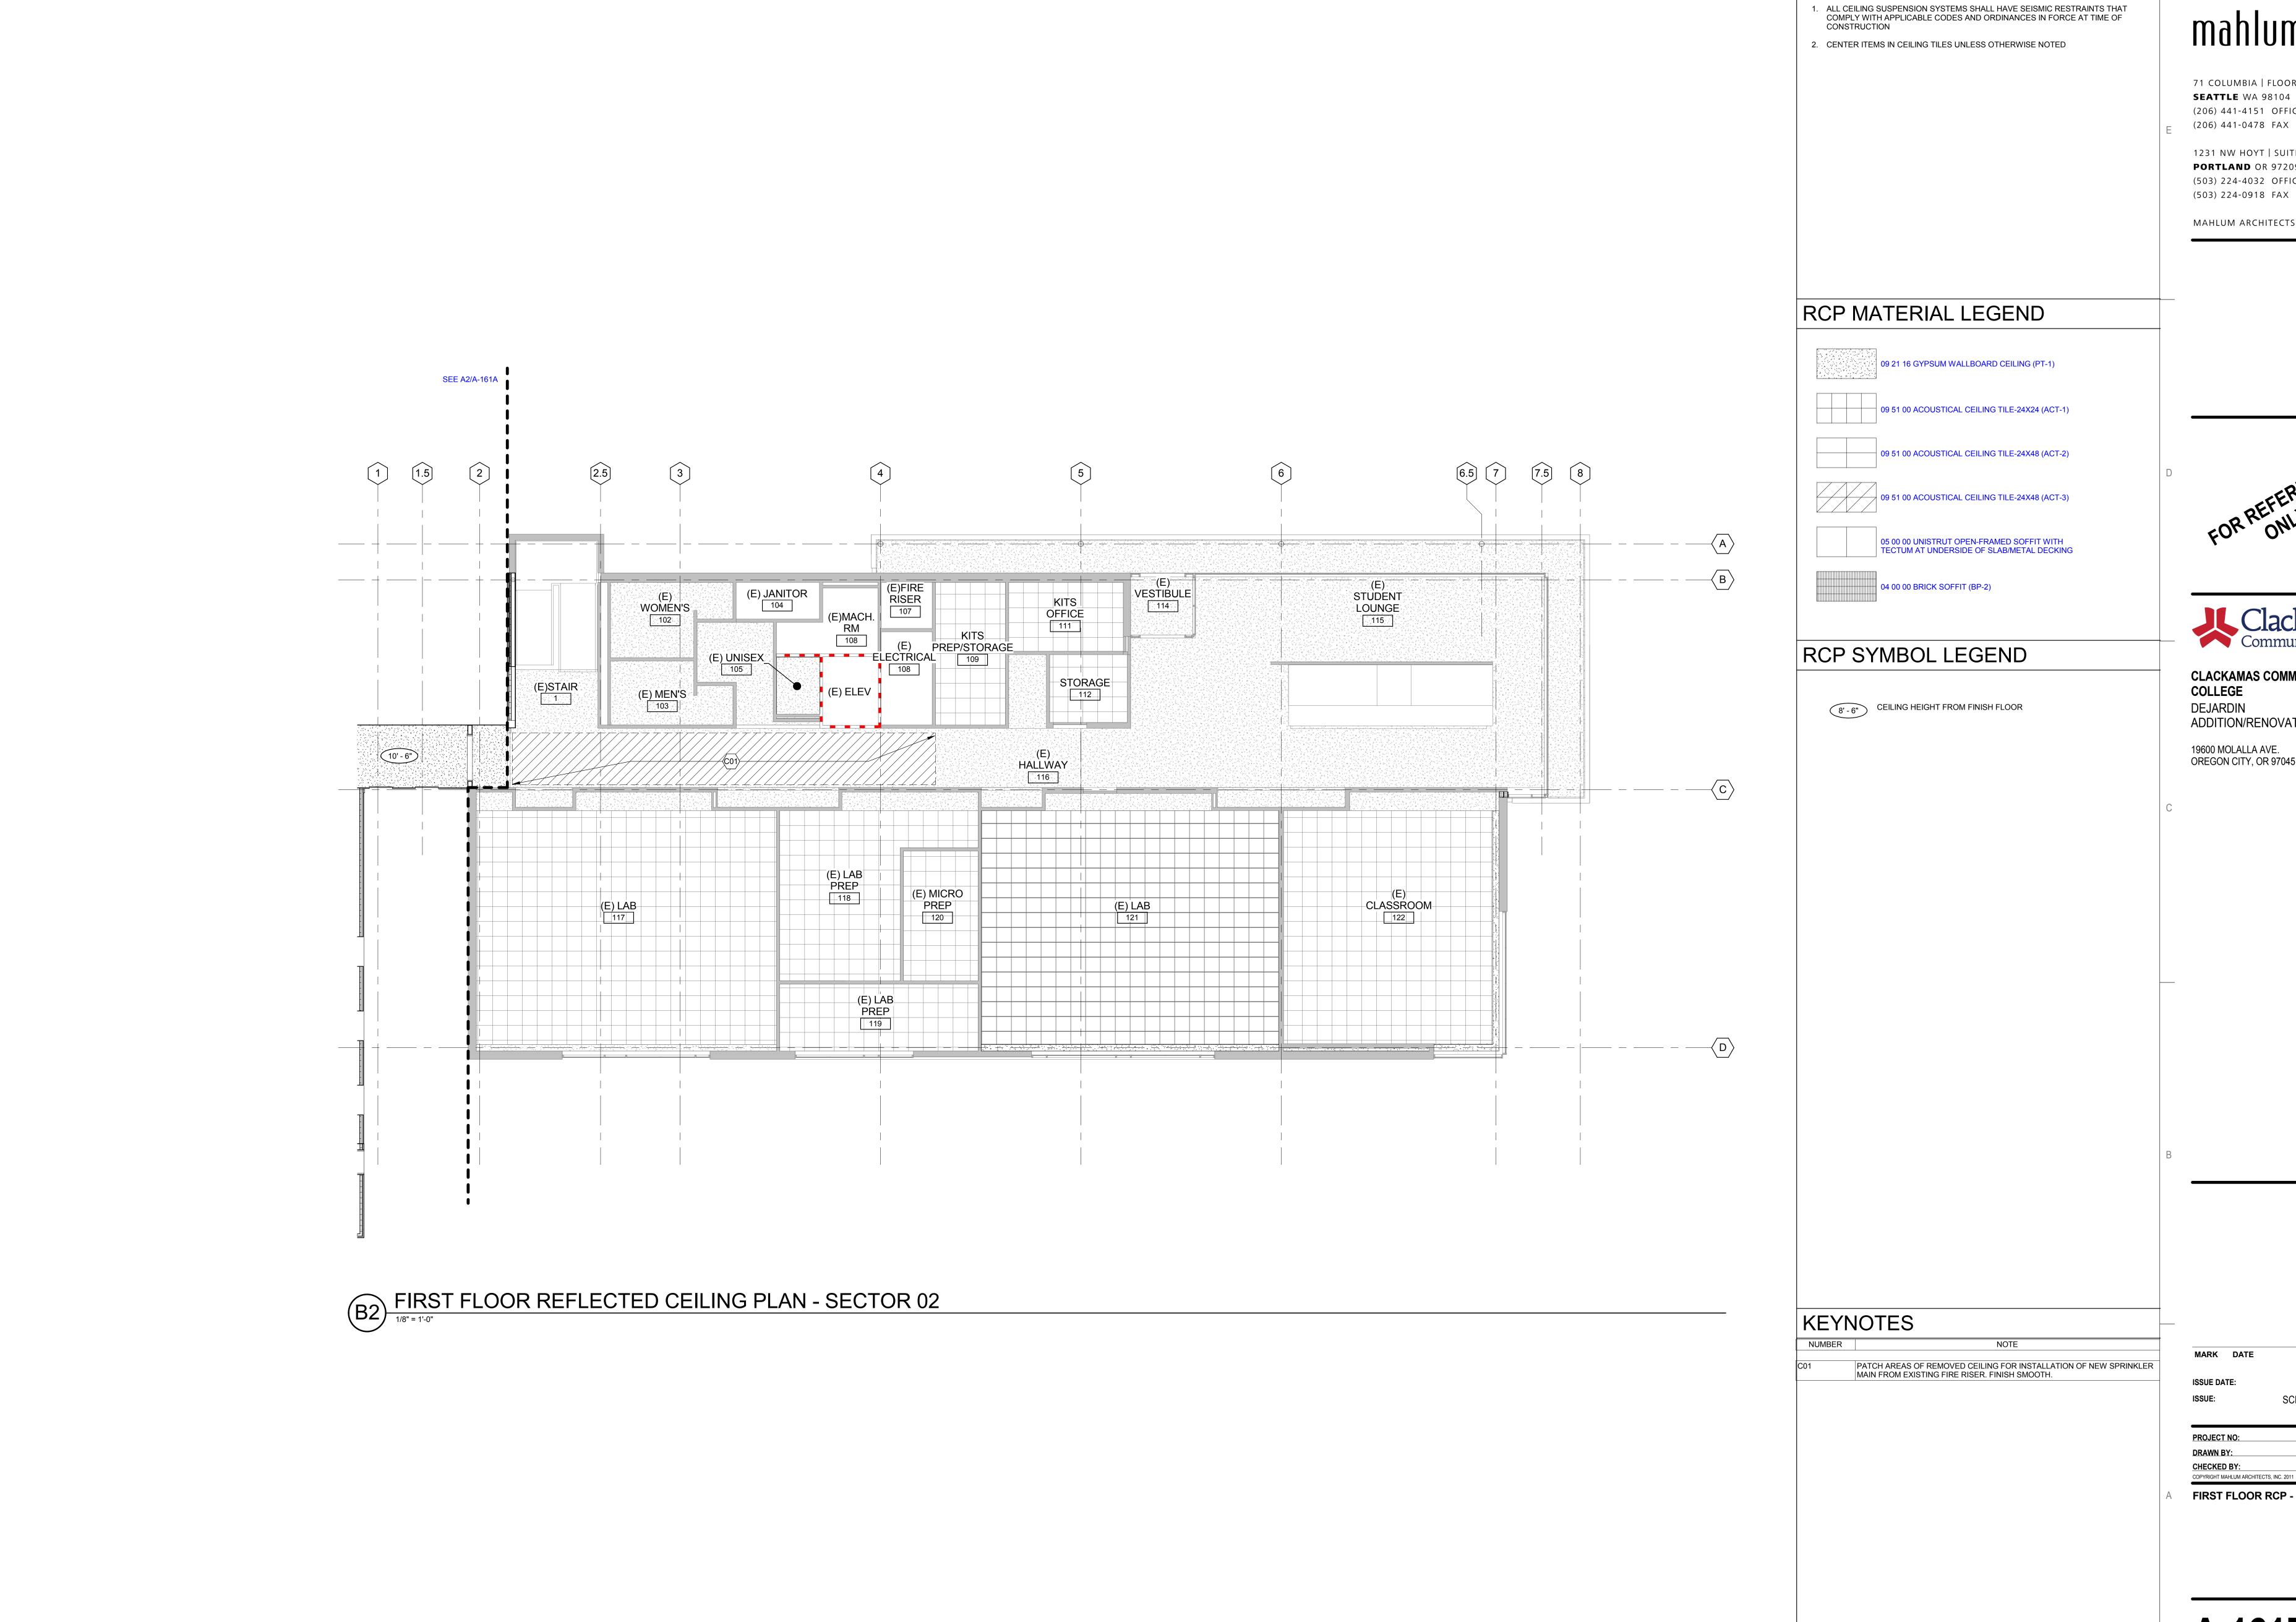

RCP GENERAL NOTES

71 COLUMBIA | FLOOR 4 SEATTLE WA 98104 (206) 441-4151 OFFICE (206) 441-0478 FAX

1231 NW HOYT | SUITE 102 PORTLAND OR 97209 (503) 224-4032 OFFICE

MAHLUM ARCHITECTS INC





CLACKAMAS COMMUNITY COLLEGE DEJARDIN ADDITION/RENOVATION


19600 MOLALLA AVE. OREGON CITY, OR 97045

DESCRIPTION

2017401

FIRST FLOOR RCP - SECTOR 02

A-161B

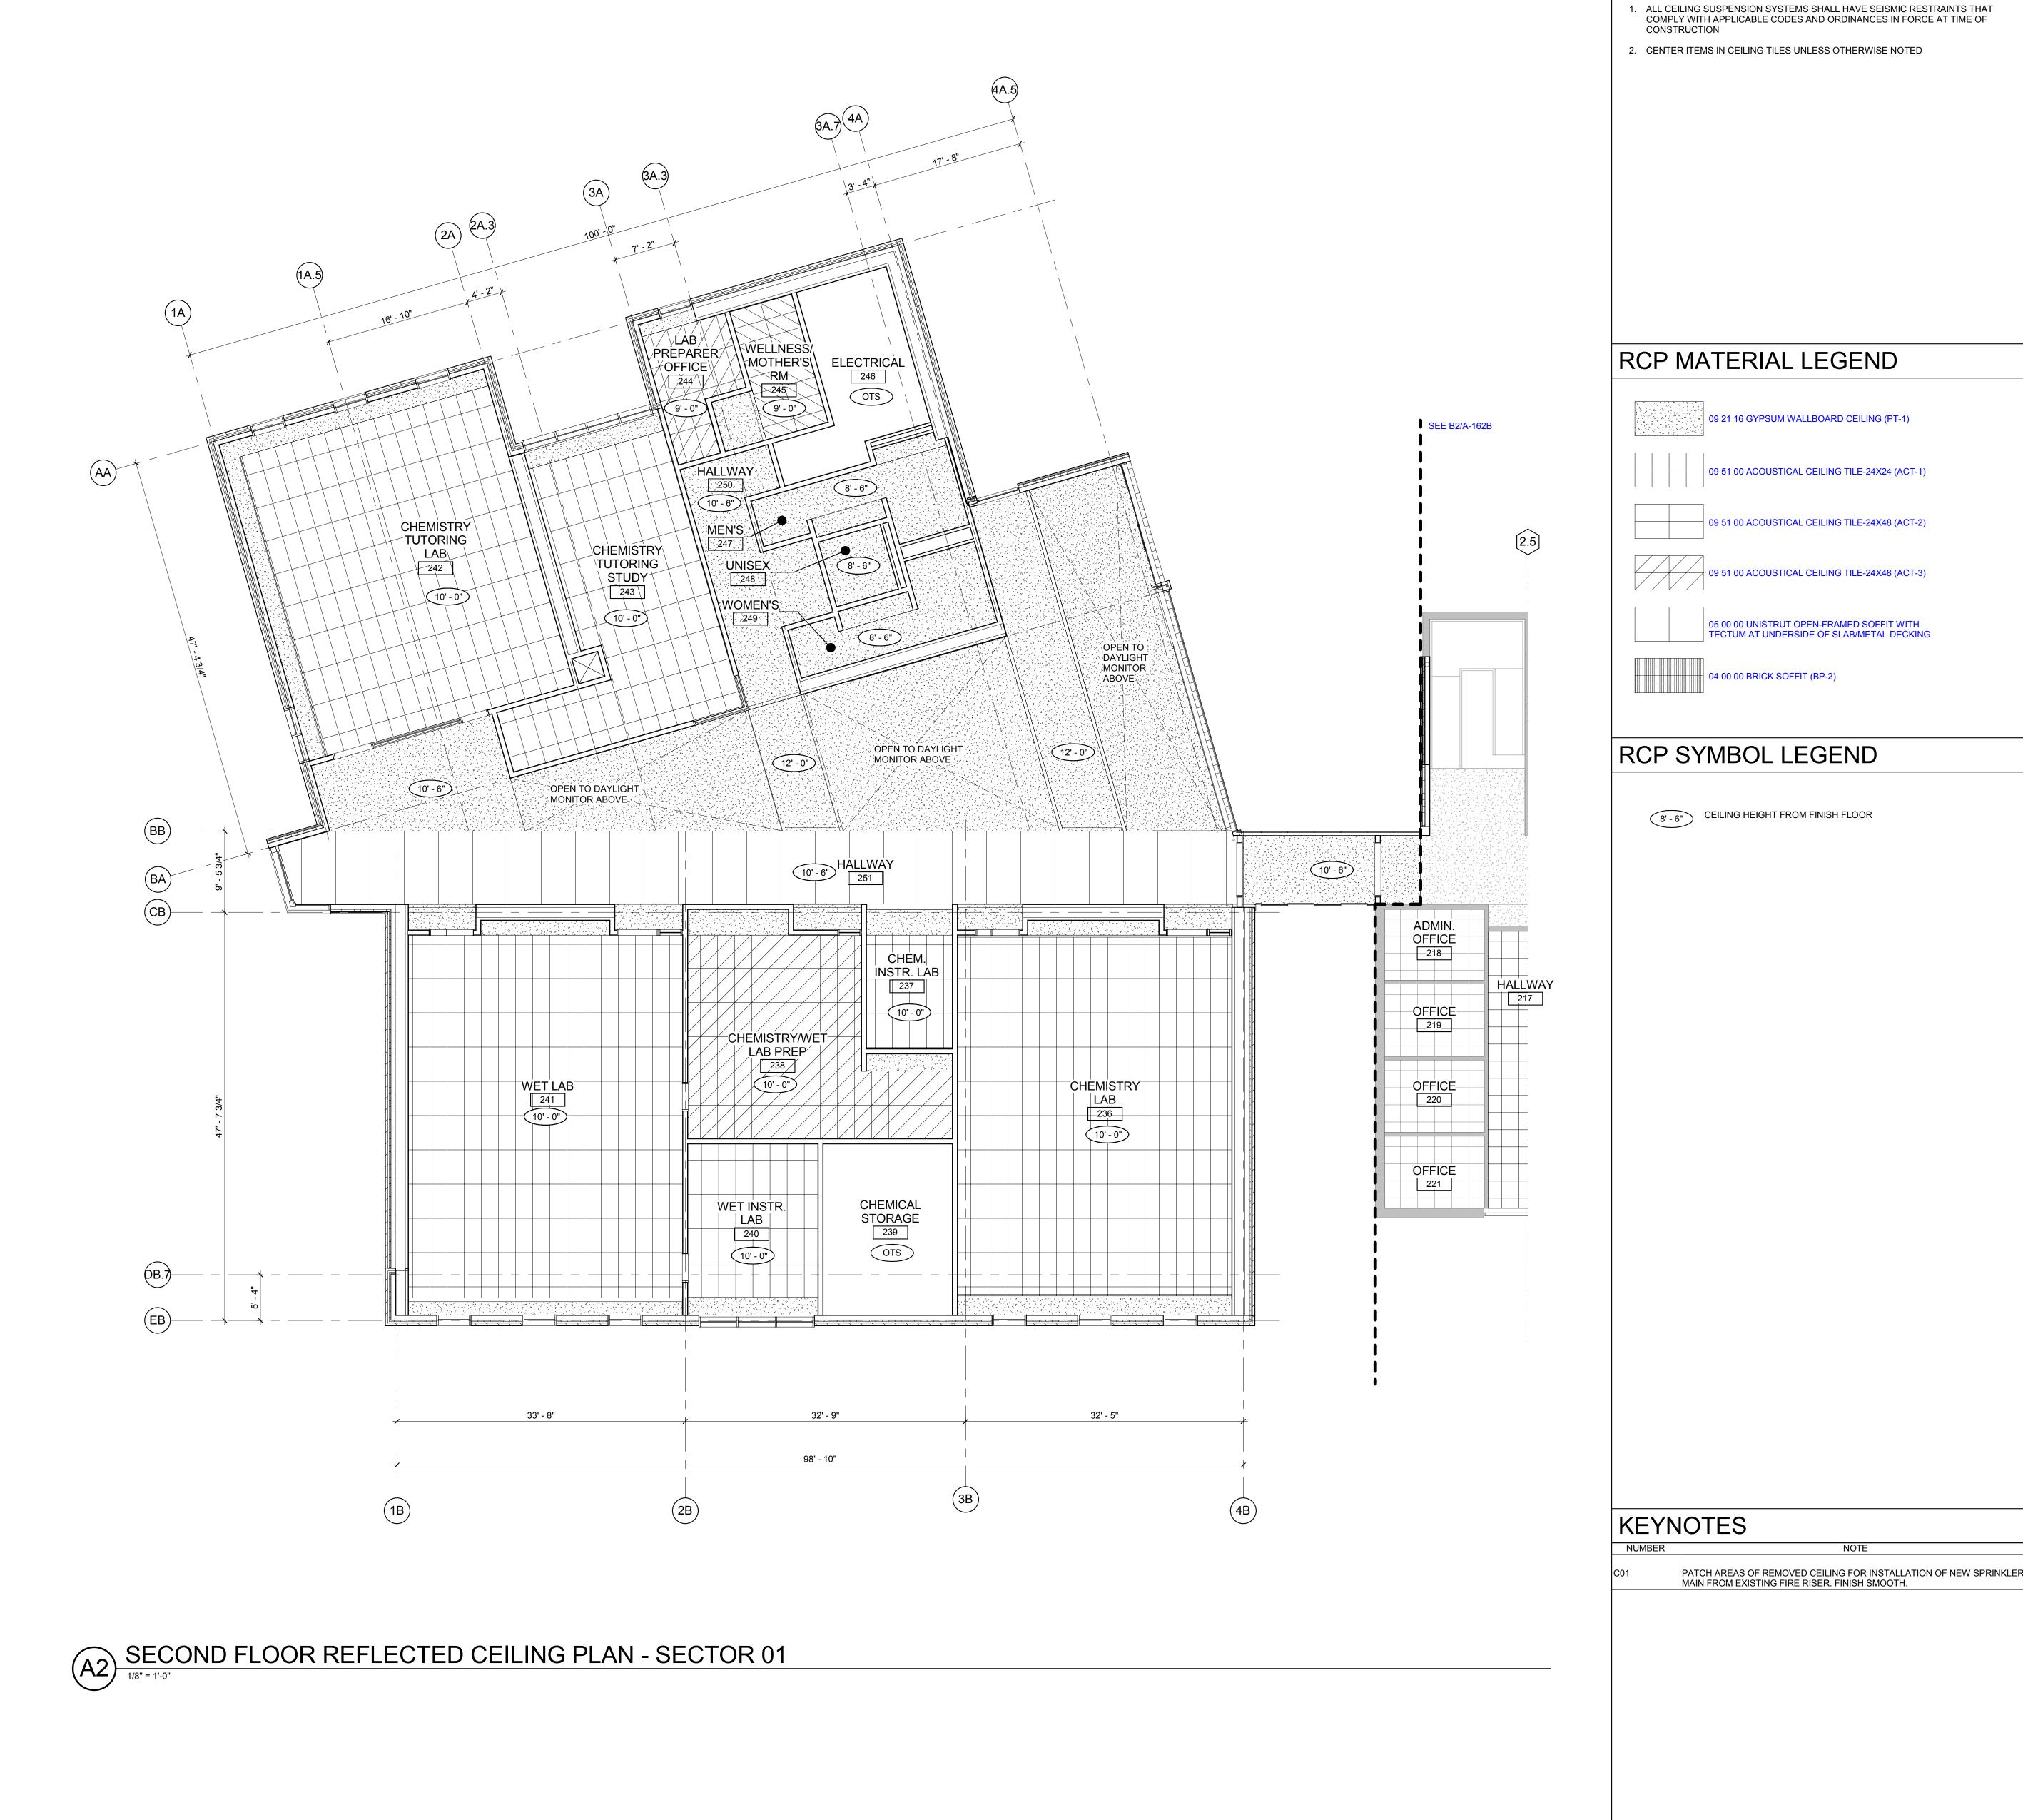


RCP GENERAL NOTES

71 COLUMBIA | FLOOR 4 SEATTLE WA 98104 (206) 441-4151 OFFICE (206) 441-0478 FAX

(503) 224-0918 FAX

1231 NW HOYT | SUITE 102 PORTLAND OR 97209 (503) 224-4032 OFFICE

MAHLUM ARCHITECTS INC

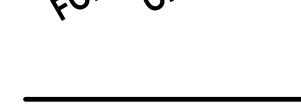

CLACKAMAS COMMUNITY COLLEGE DEJARDIN ADDITION/RENOVATION


19600 MOLALLA AVE. OREGON CITY, OR 97045


PATCH AREAS OF REMOVED CEILING FOR INSTALLATION OF NEW SPRINKLER MAIN FROM EXISTING FIRE RISER. FINISH SMOOTH.


DESCRIPTION AUGUST 23,2017 SCHEMATIC DESIGN

SECOND FLOOR RCP - SECTOR

A-162A

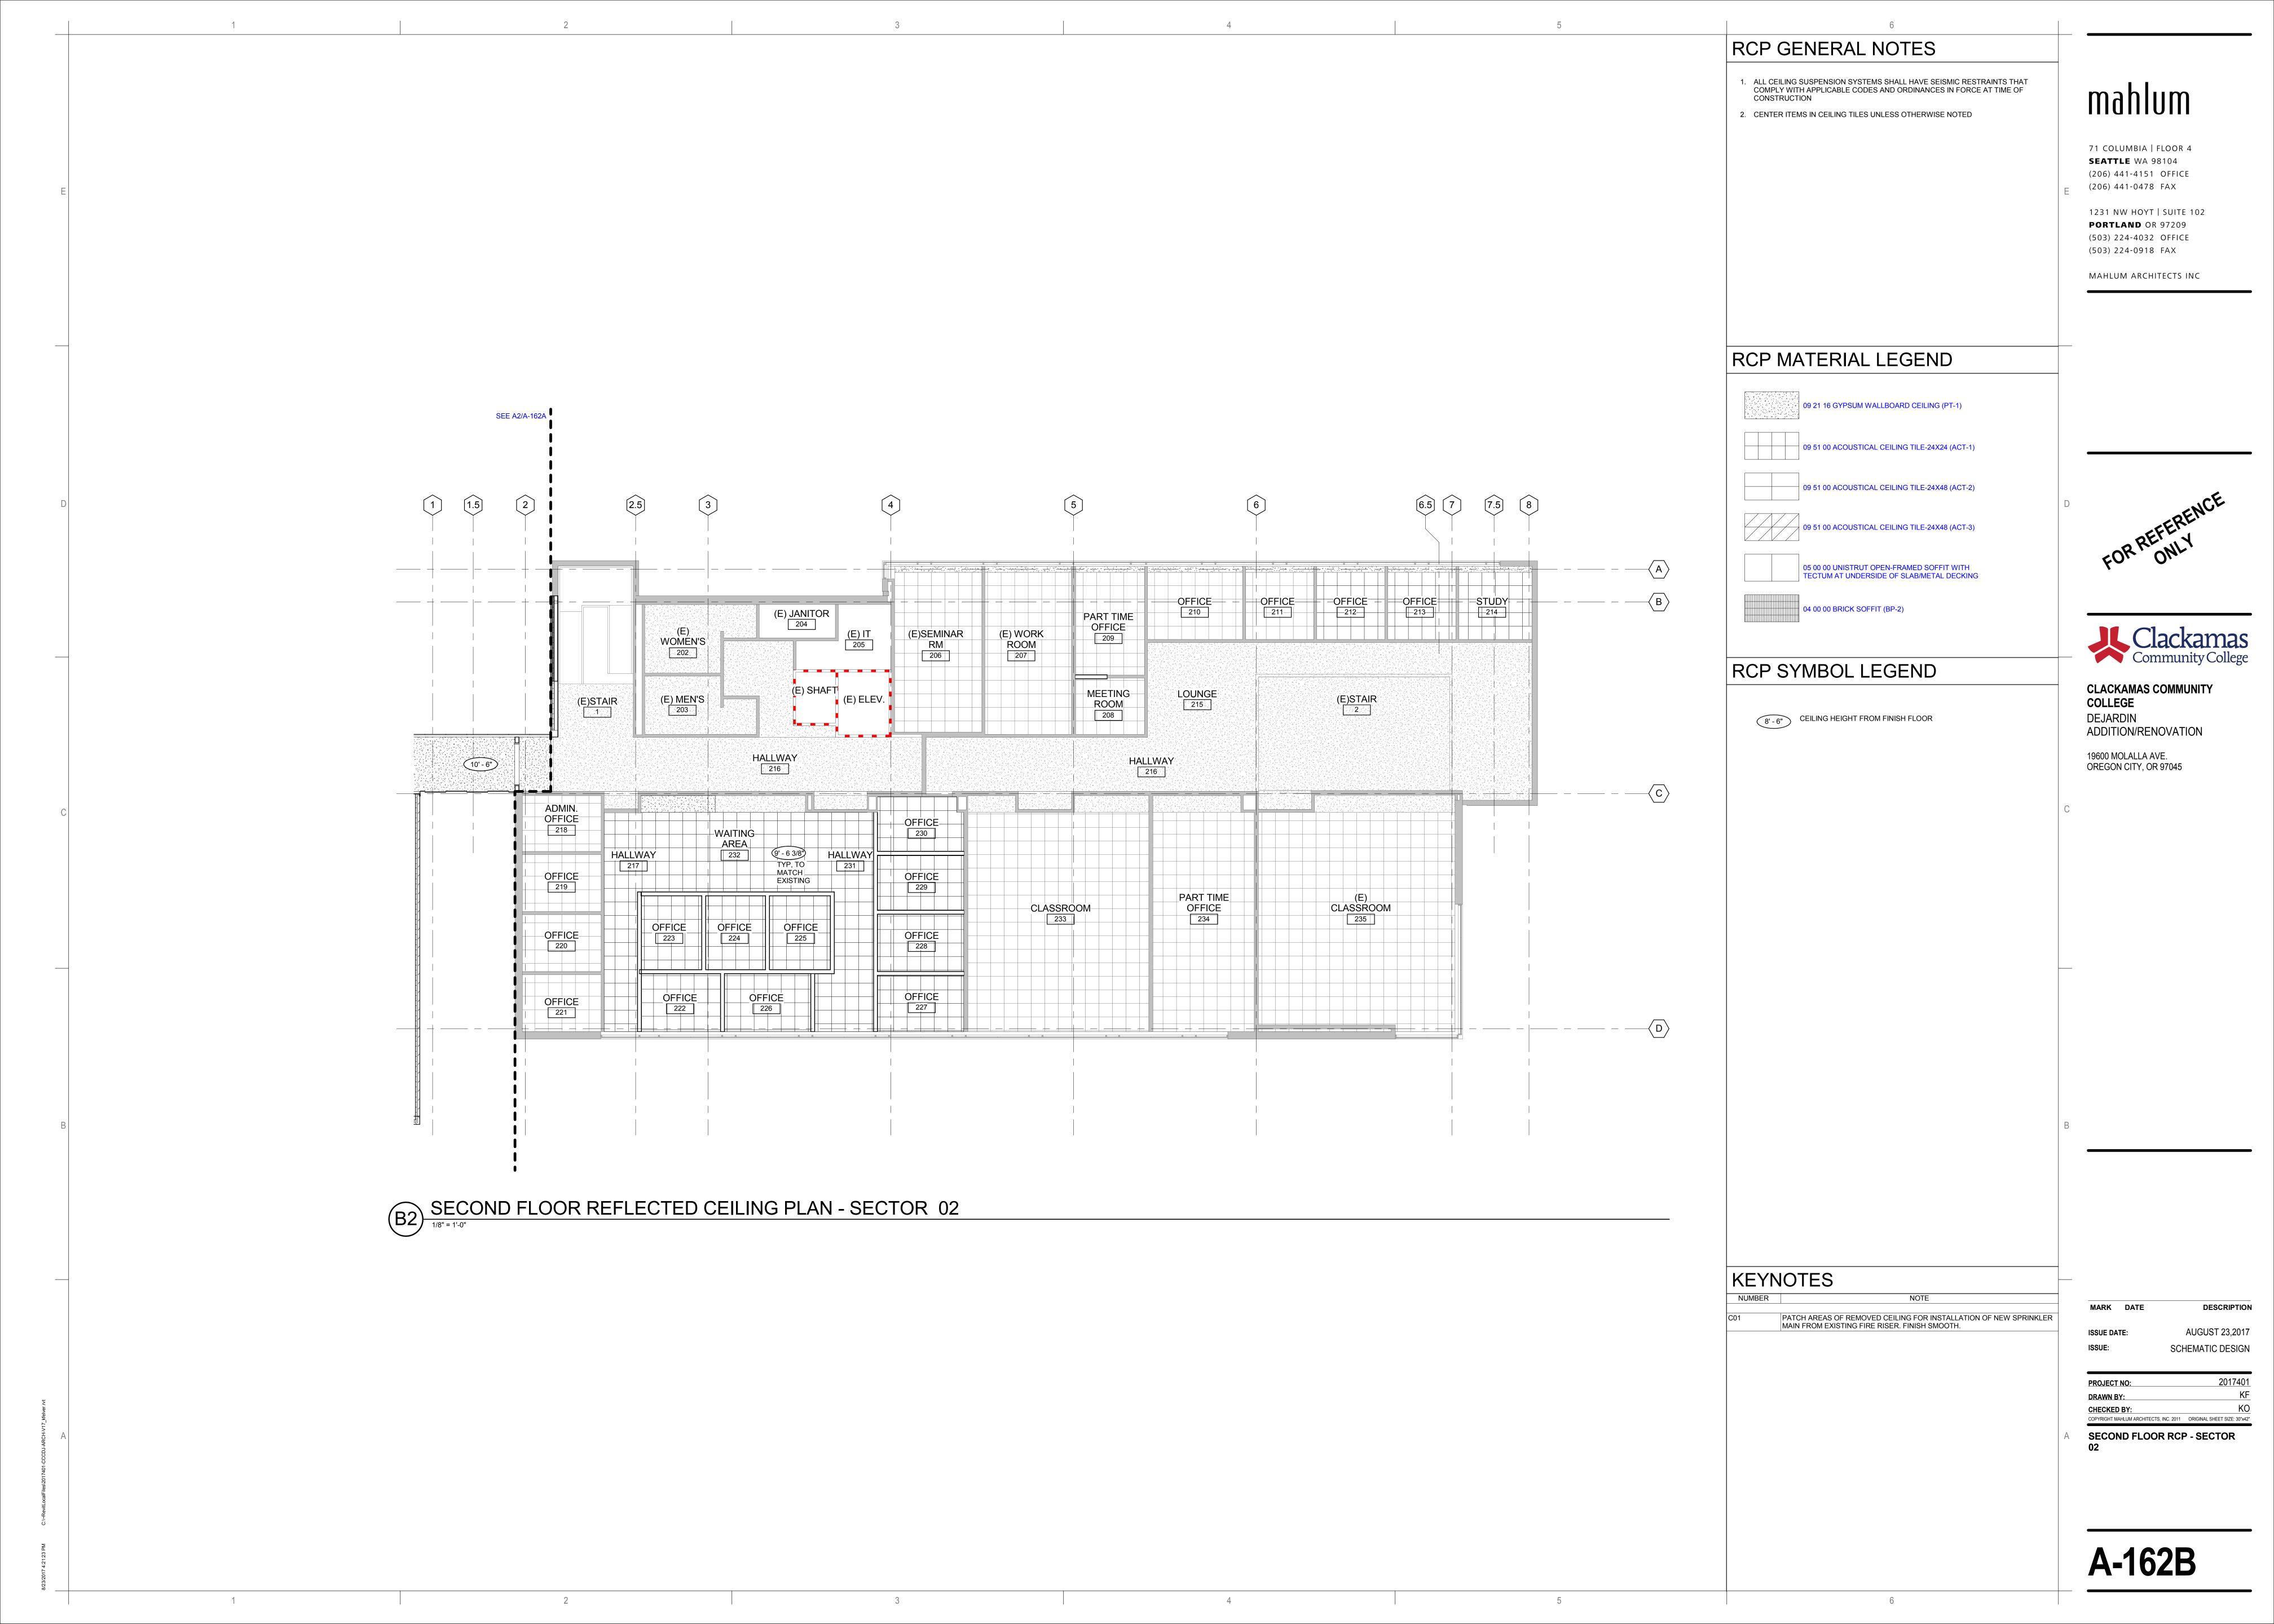

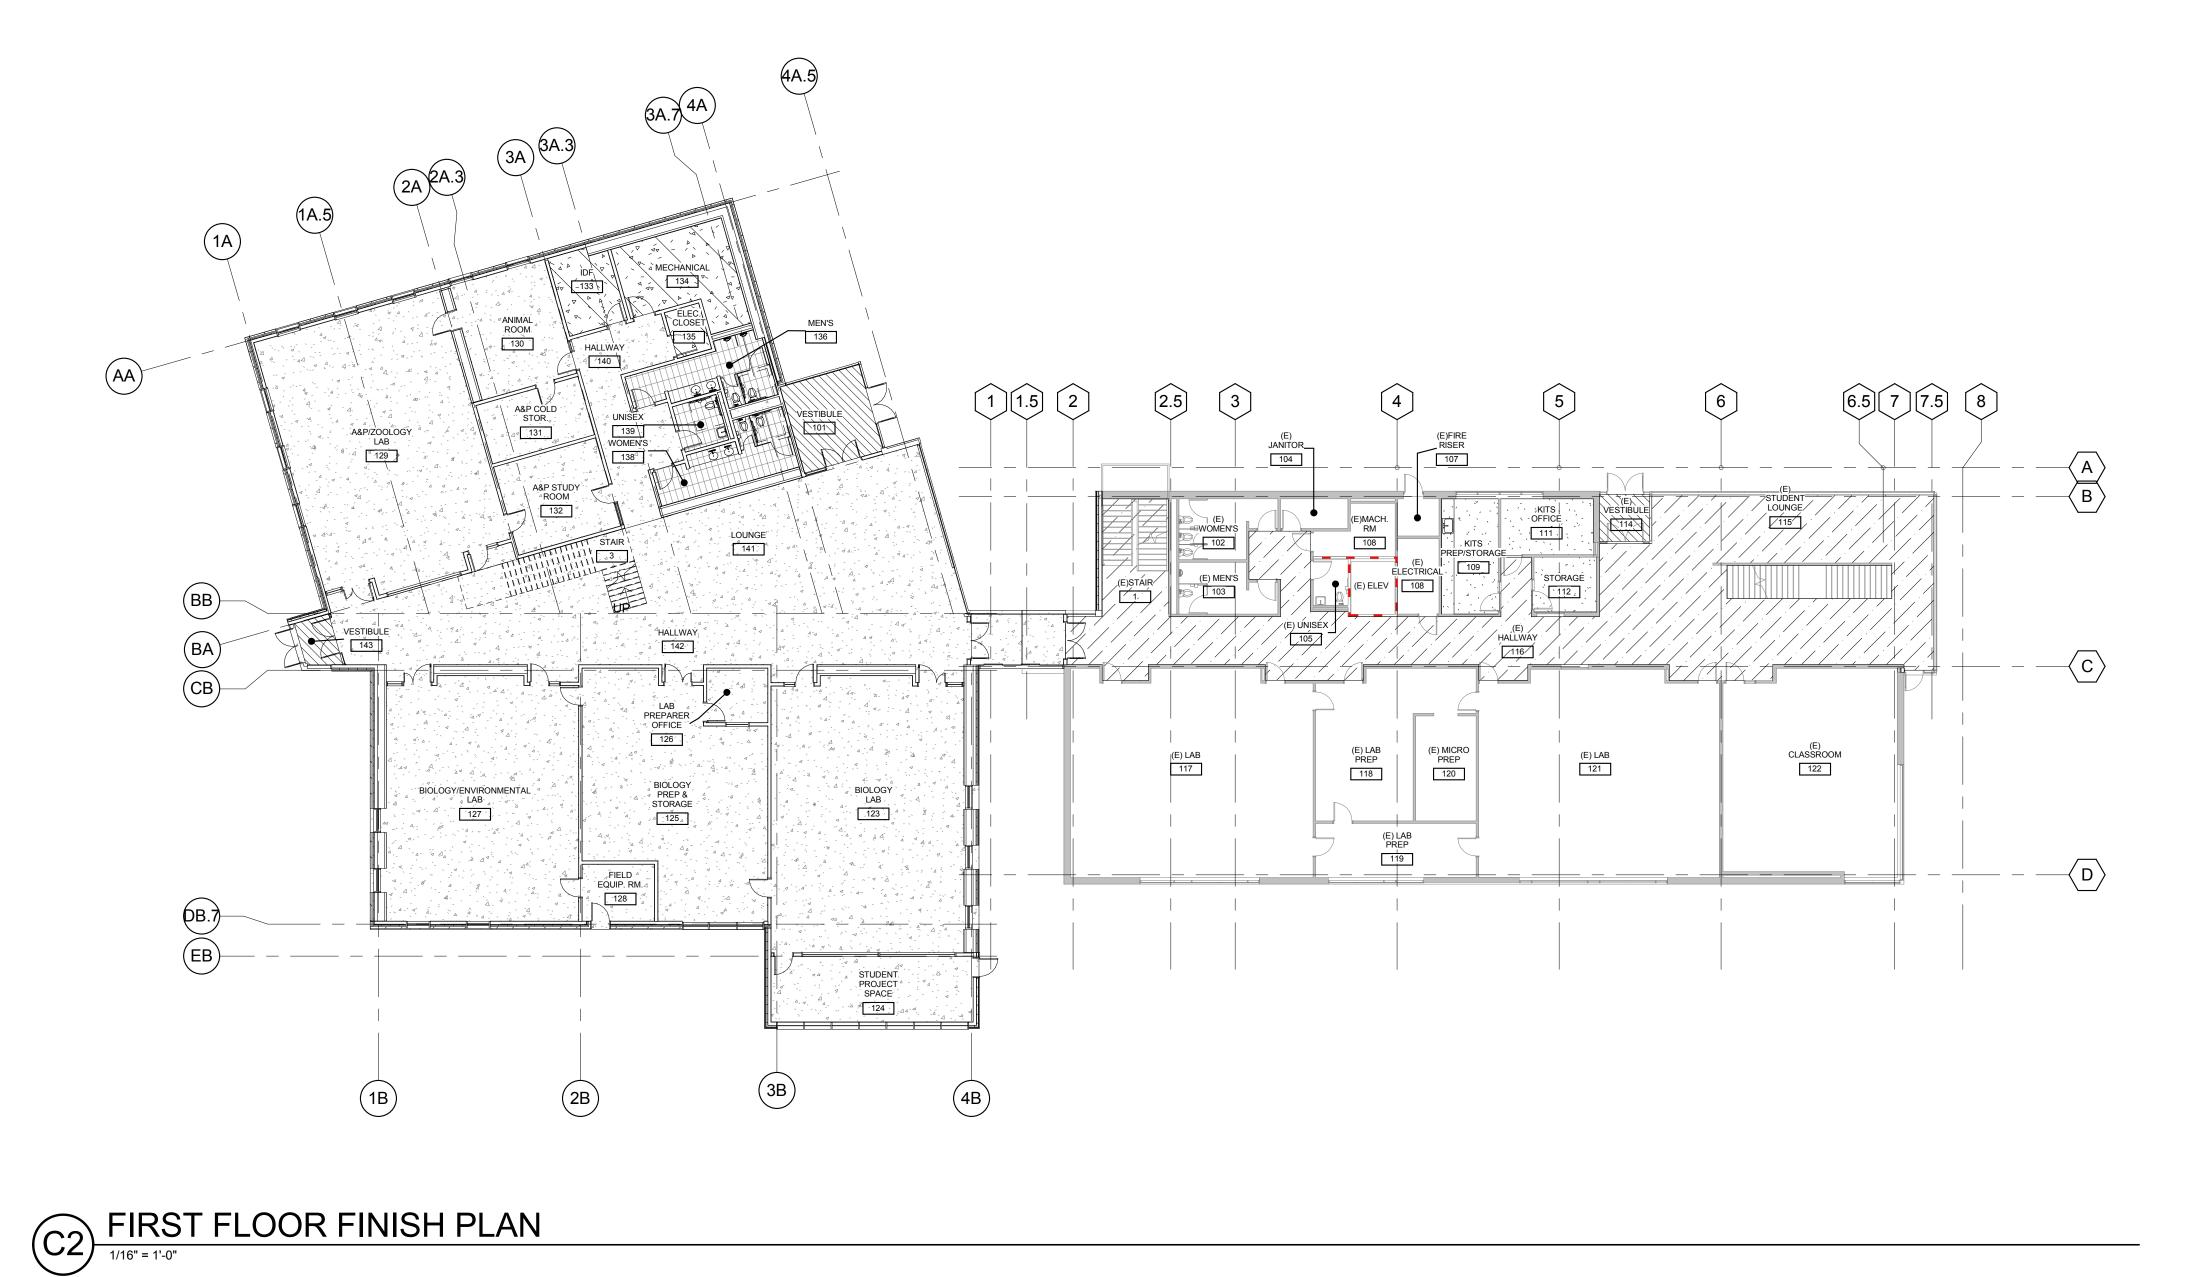

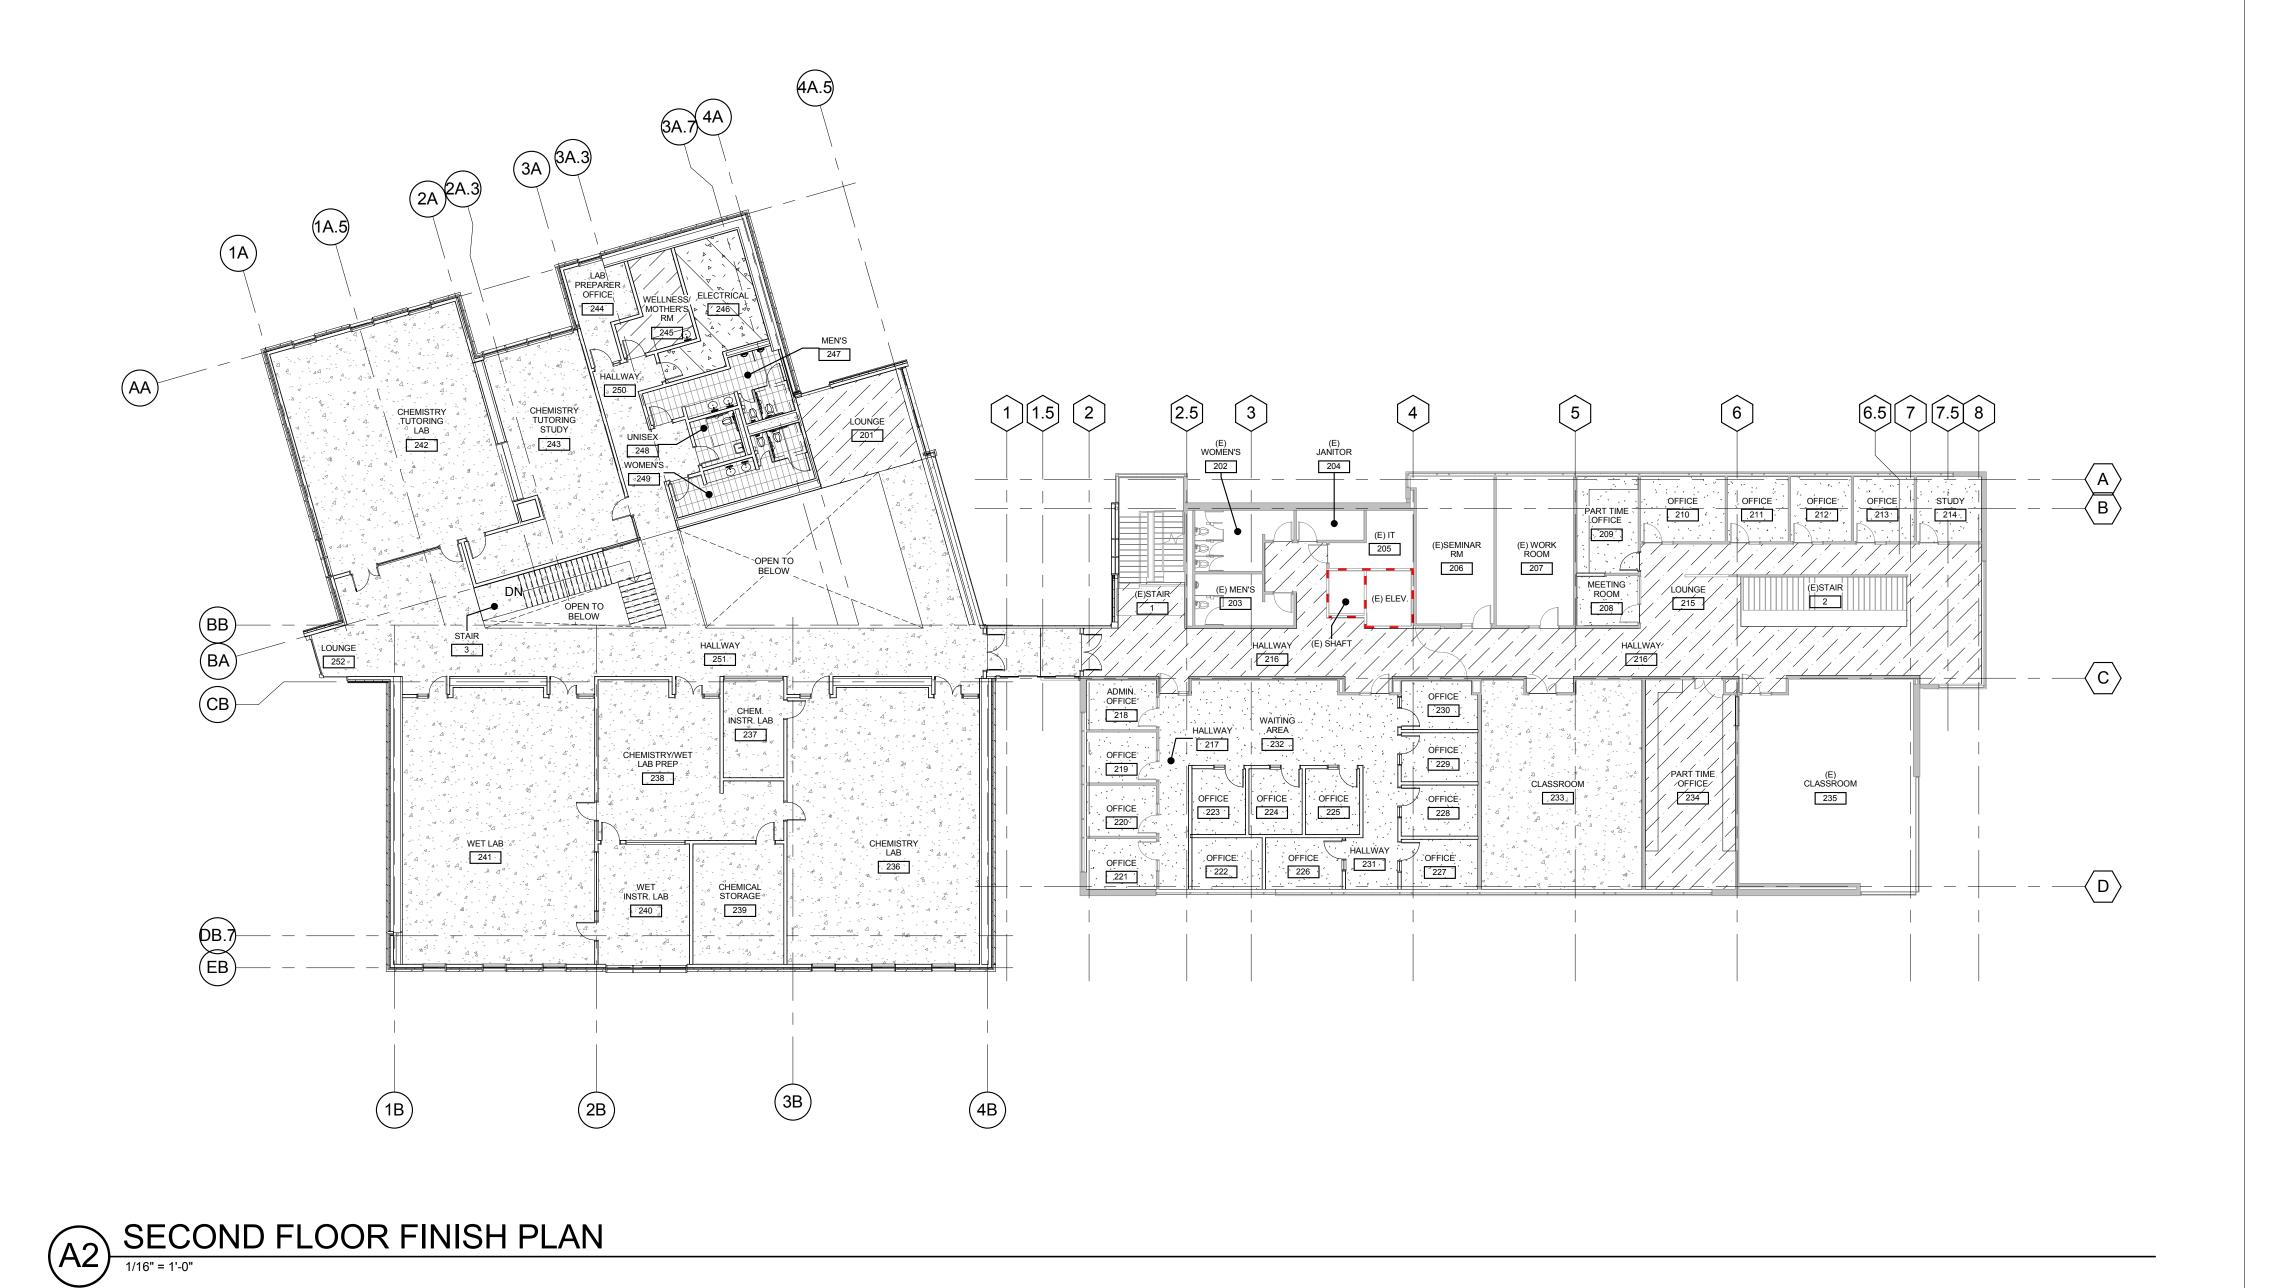

GENERAL NOTES

 FLOOR FINISH PATTERNS ARE NOT REPRESENTATIVE OF ACTUAL MATERIAL PATTERN, SCALE, OR DIRECTION.

MATERIAL LEGEND

SEATTLE WA 98104 (206) 441-4151 OFFICE (206) 441-0478 FAX

71 COLUMBIA | FLOOR 4

(503) 224-4032 OFFICE (503) 224-0918 FAX

MAHLUM ARCHITECTS INC

PORTLAND OR 97209

1231 NW HOYT | SUITE 102

PORCELAIN TILE

CONCRETE

03 30 00 POLISHED CONCRETE

03 30 00 POLISHED CONCRETE

09 00 00 SEALED CONCRETE

CARPET

09 68 00 CARPET TILE (CPT-1)

09 68 00 CARPET TILE (CPT-2)

09 00 00 WALK OFF MAT (WOM-1)

FOR REFERENCE



CLACKAMAS COMMUNITY COLLEGE DEJARDIN ADDITION/RENOVATION

19600 MOLALLA AVE. OREGON CITY, OR 97045

MARK DATE DESCRIPTION

ISSUE DATE: AUGUST 23,2017

ISSUE: SCHEMATIC DESIGN


PROJECT NO: 2017401


DRAWN BY: KF

CHECKED BY: KO

COPYRIGHT MAHLUM ARCHITECTS, INC. 2011 ORIGINAL SHEET SIZE: 30"x42"

FINISH FLOOR PLANS

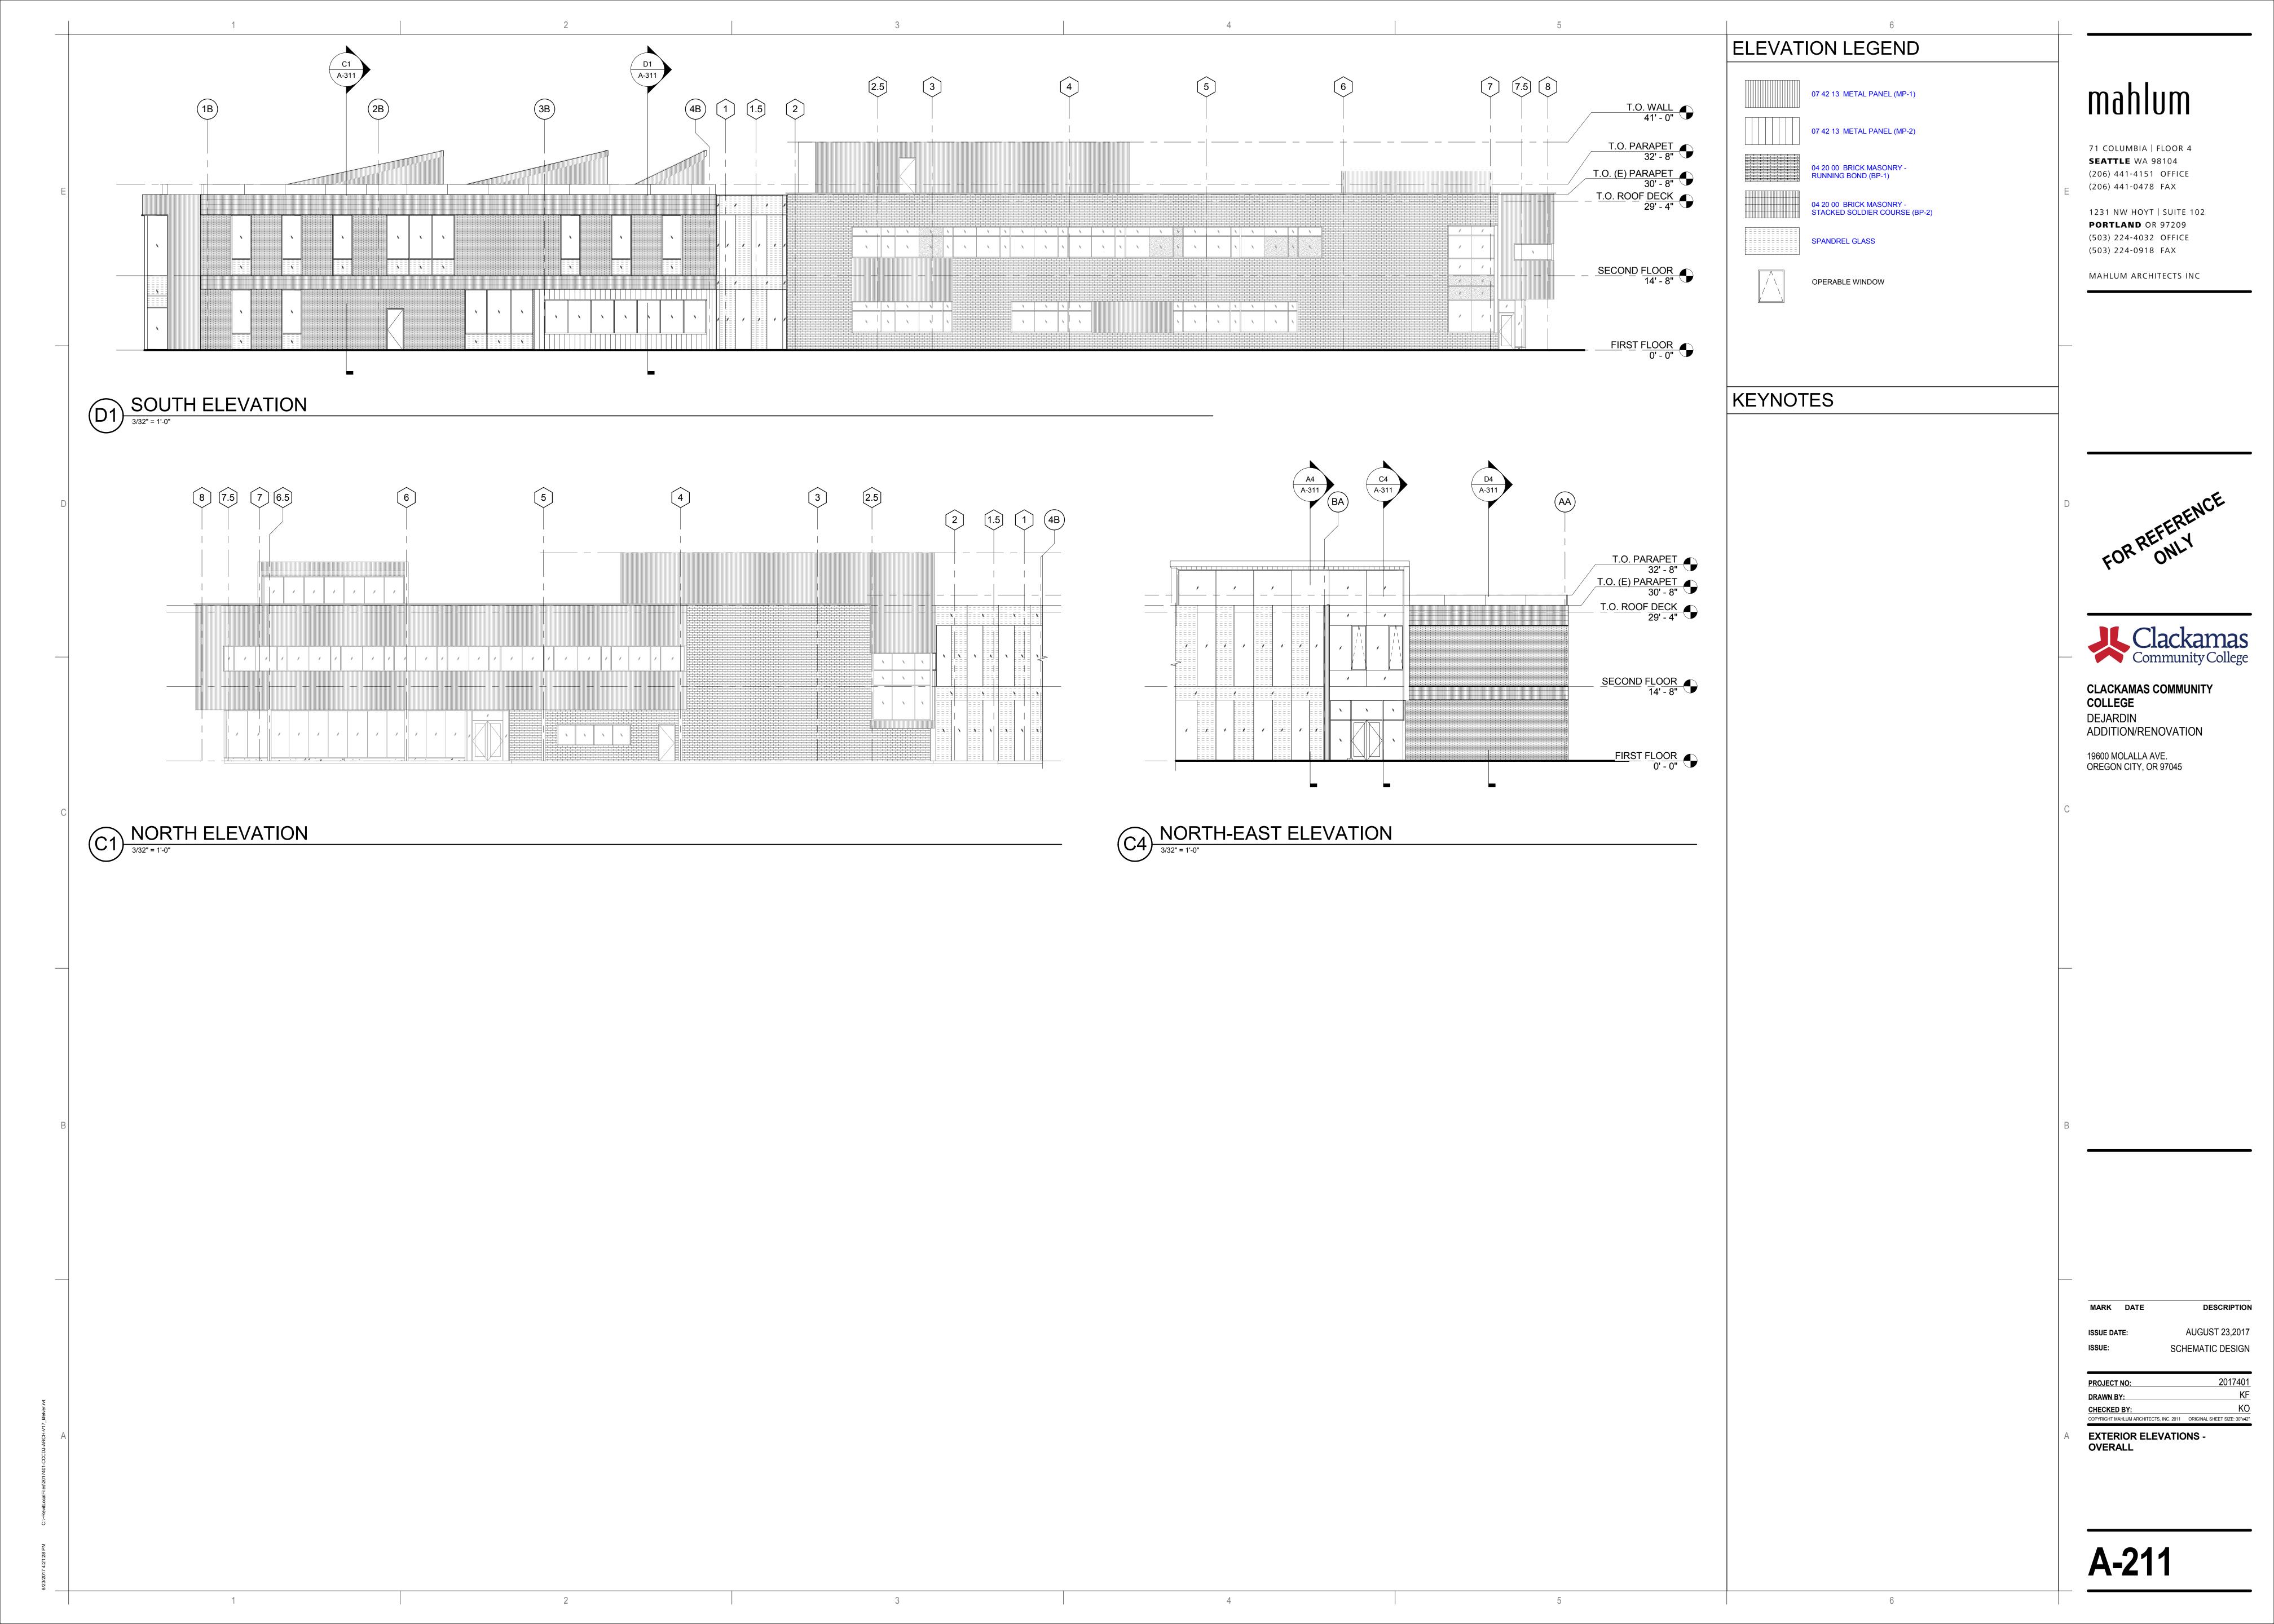

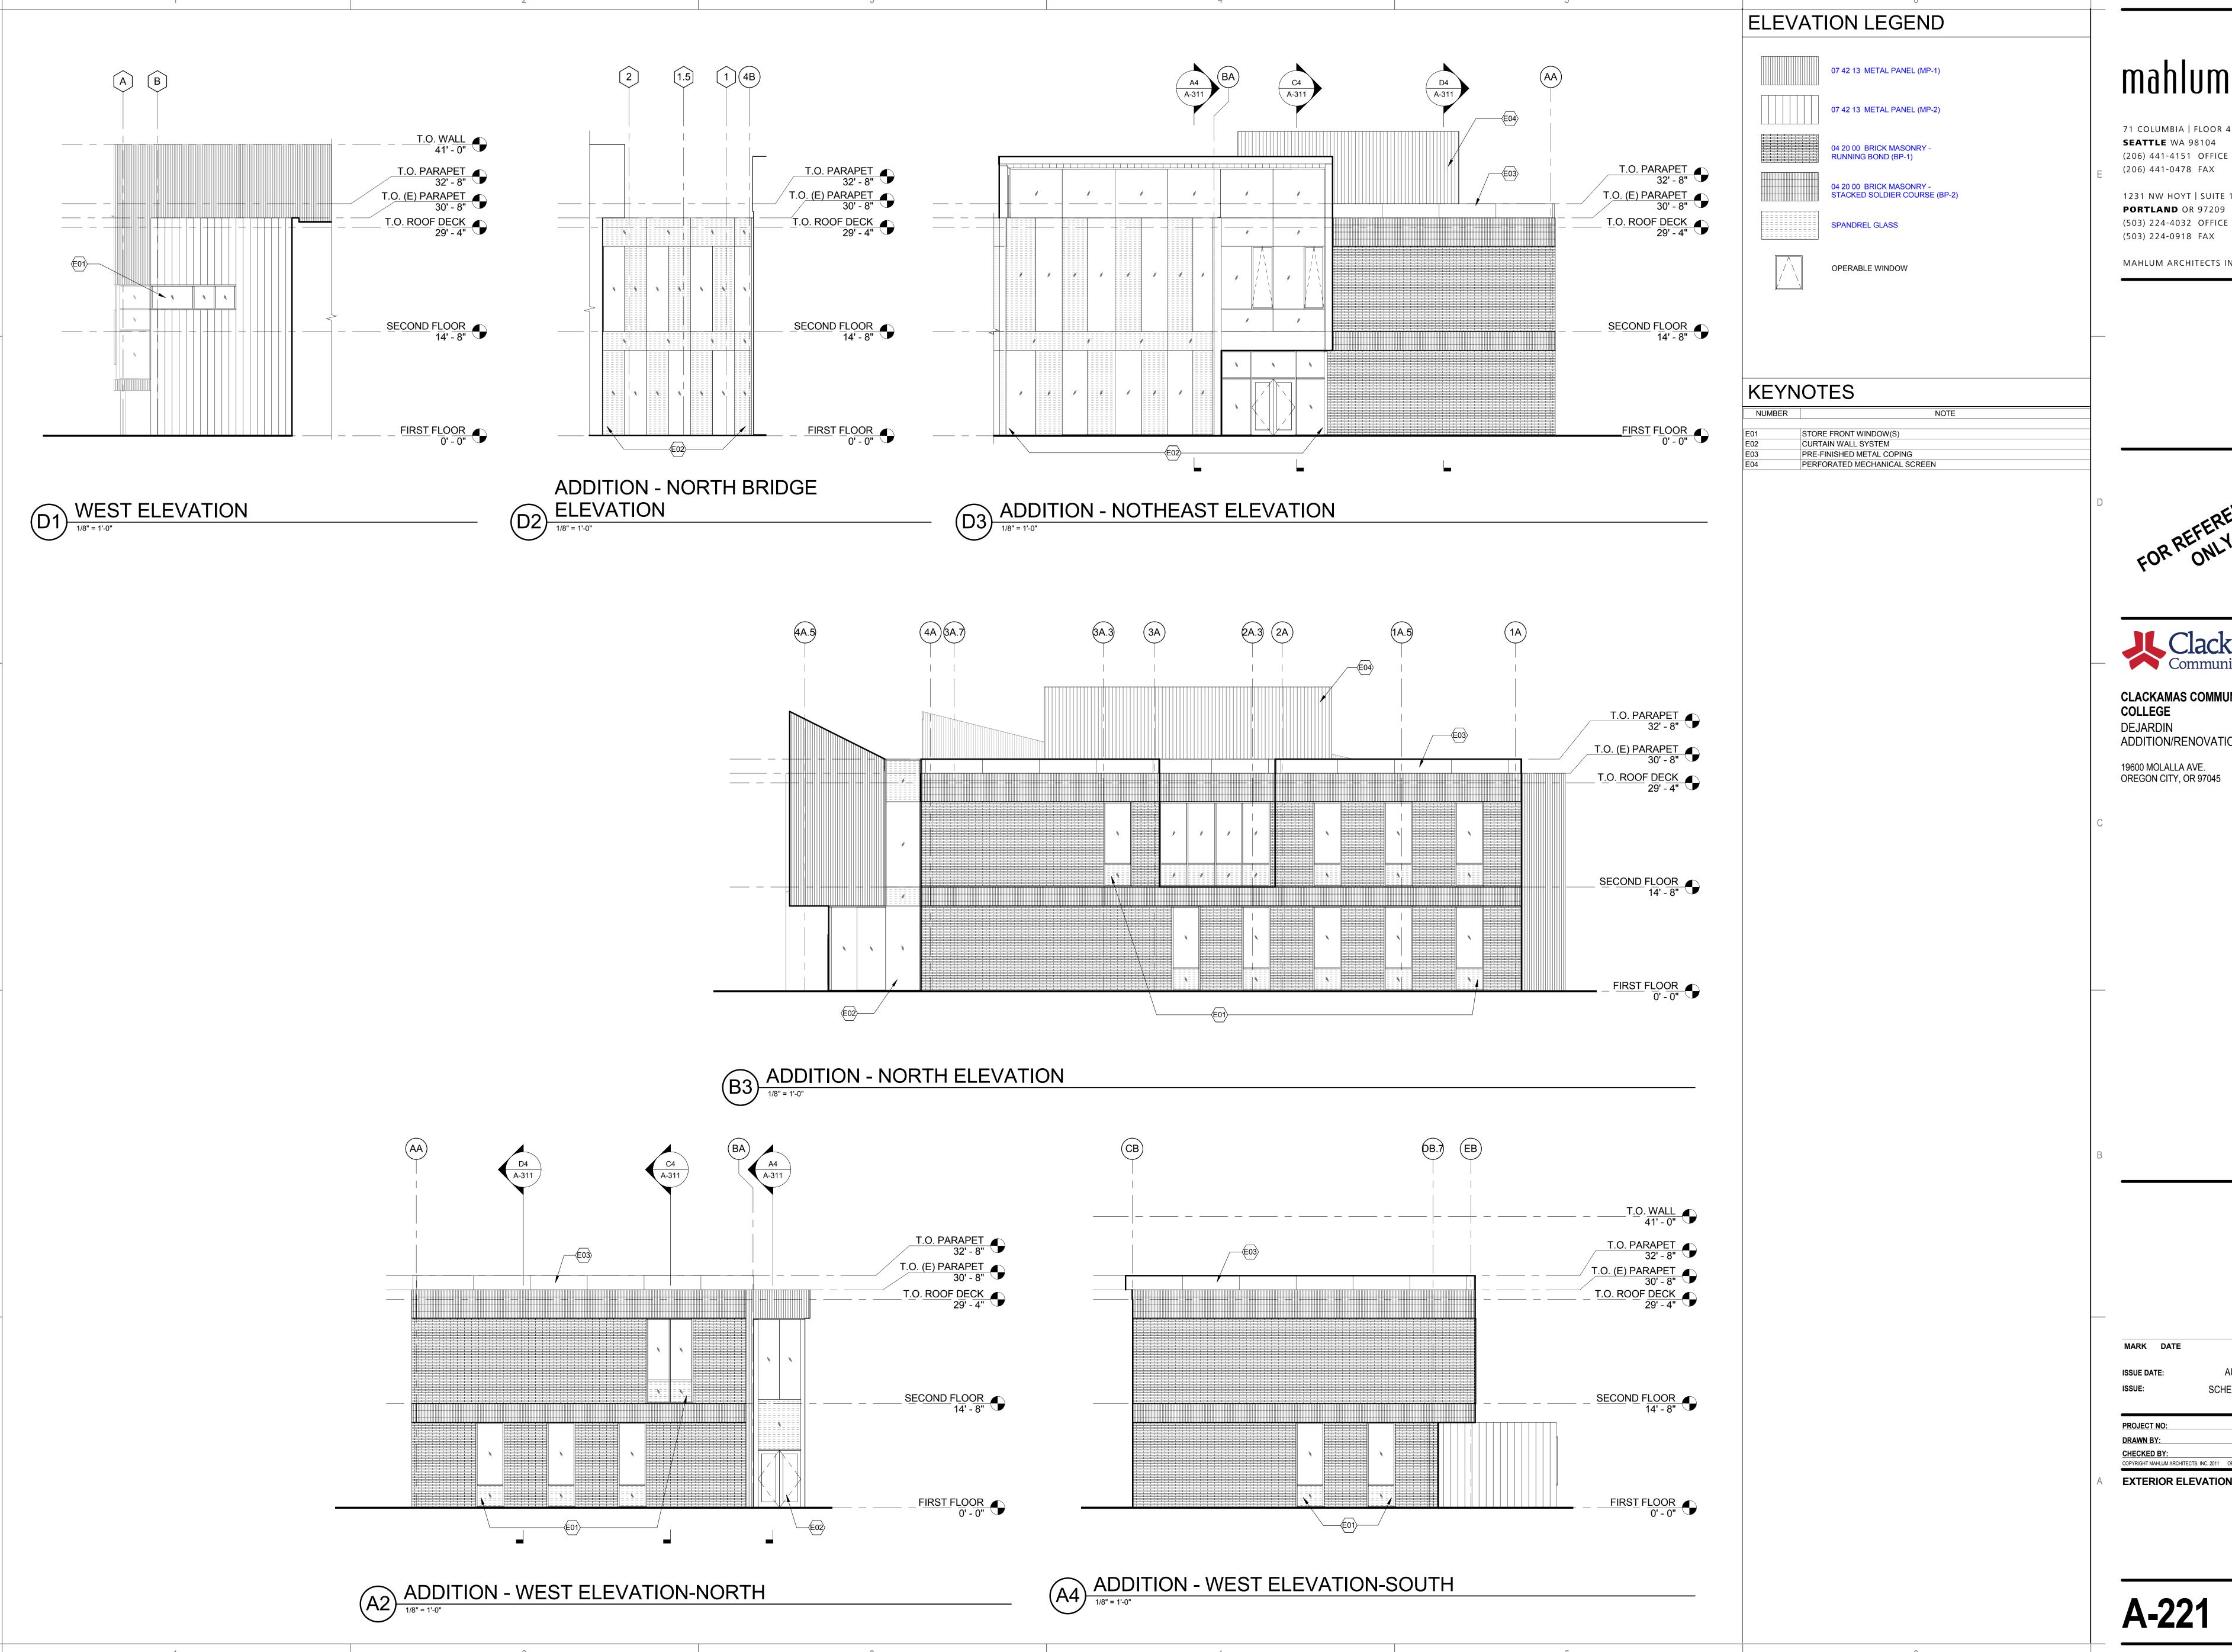

mahlum

71 COLUMBIA | FLOOR 4 SEATTLE WA 98104 (206) 441-4151 OFFICE

1231 NW HOYT | SUITE 102 PORTLAND OR 97209

MAHLUM ARCHITECTS INC



CLACKAMAS COMMUNITY COLLEGE DEJARDIN ADDITION/RENOVATION


19600 MOLALLA AVE. OREGON CITY, OR 97045

DESCRIPTION AUGUST 23,2017 SCHEMATIC DESIGN

2017401


EXTERIOR ELEVATIONS

A-221

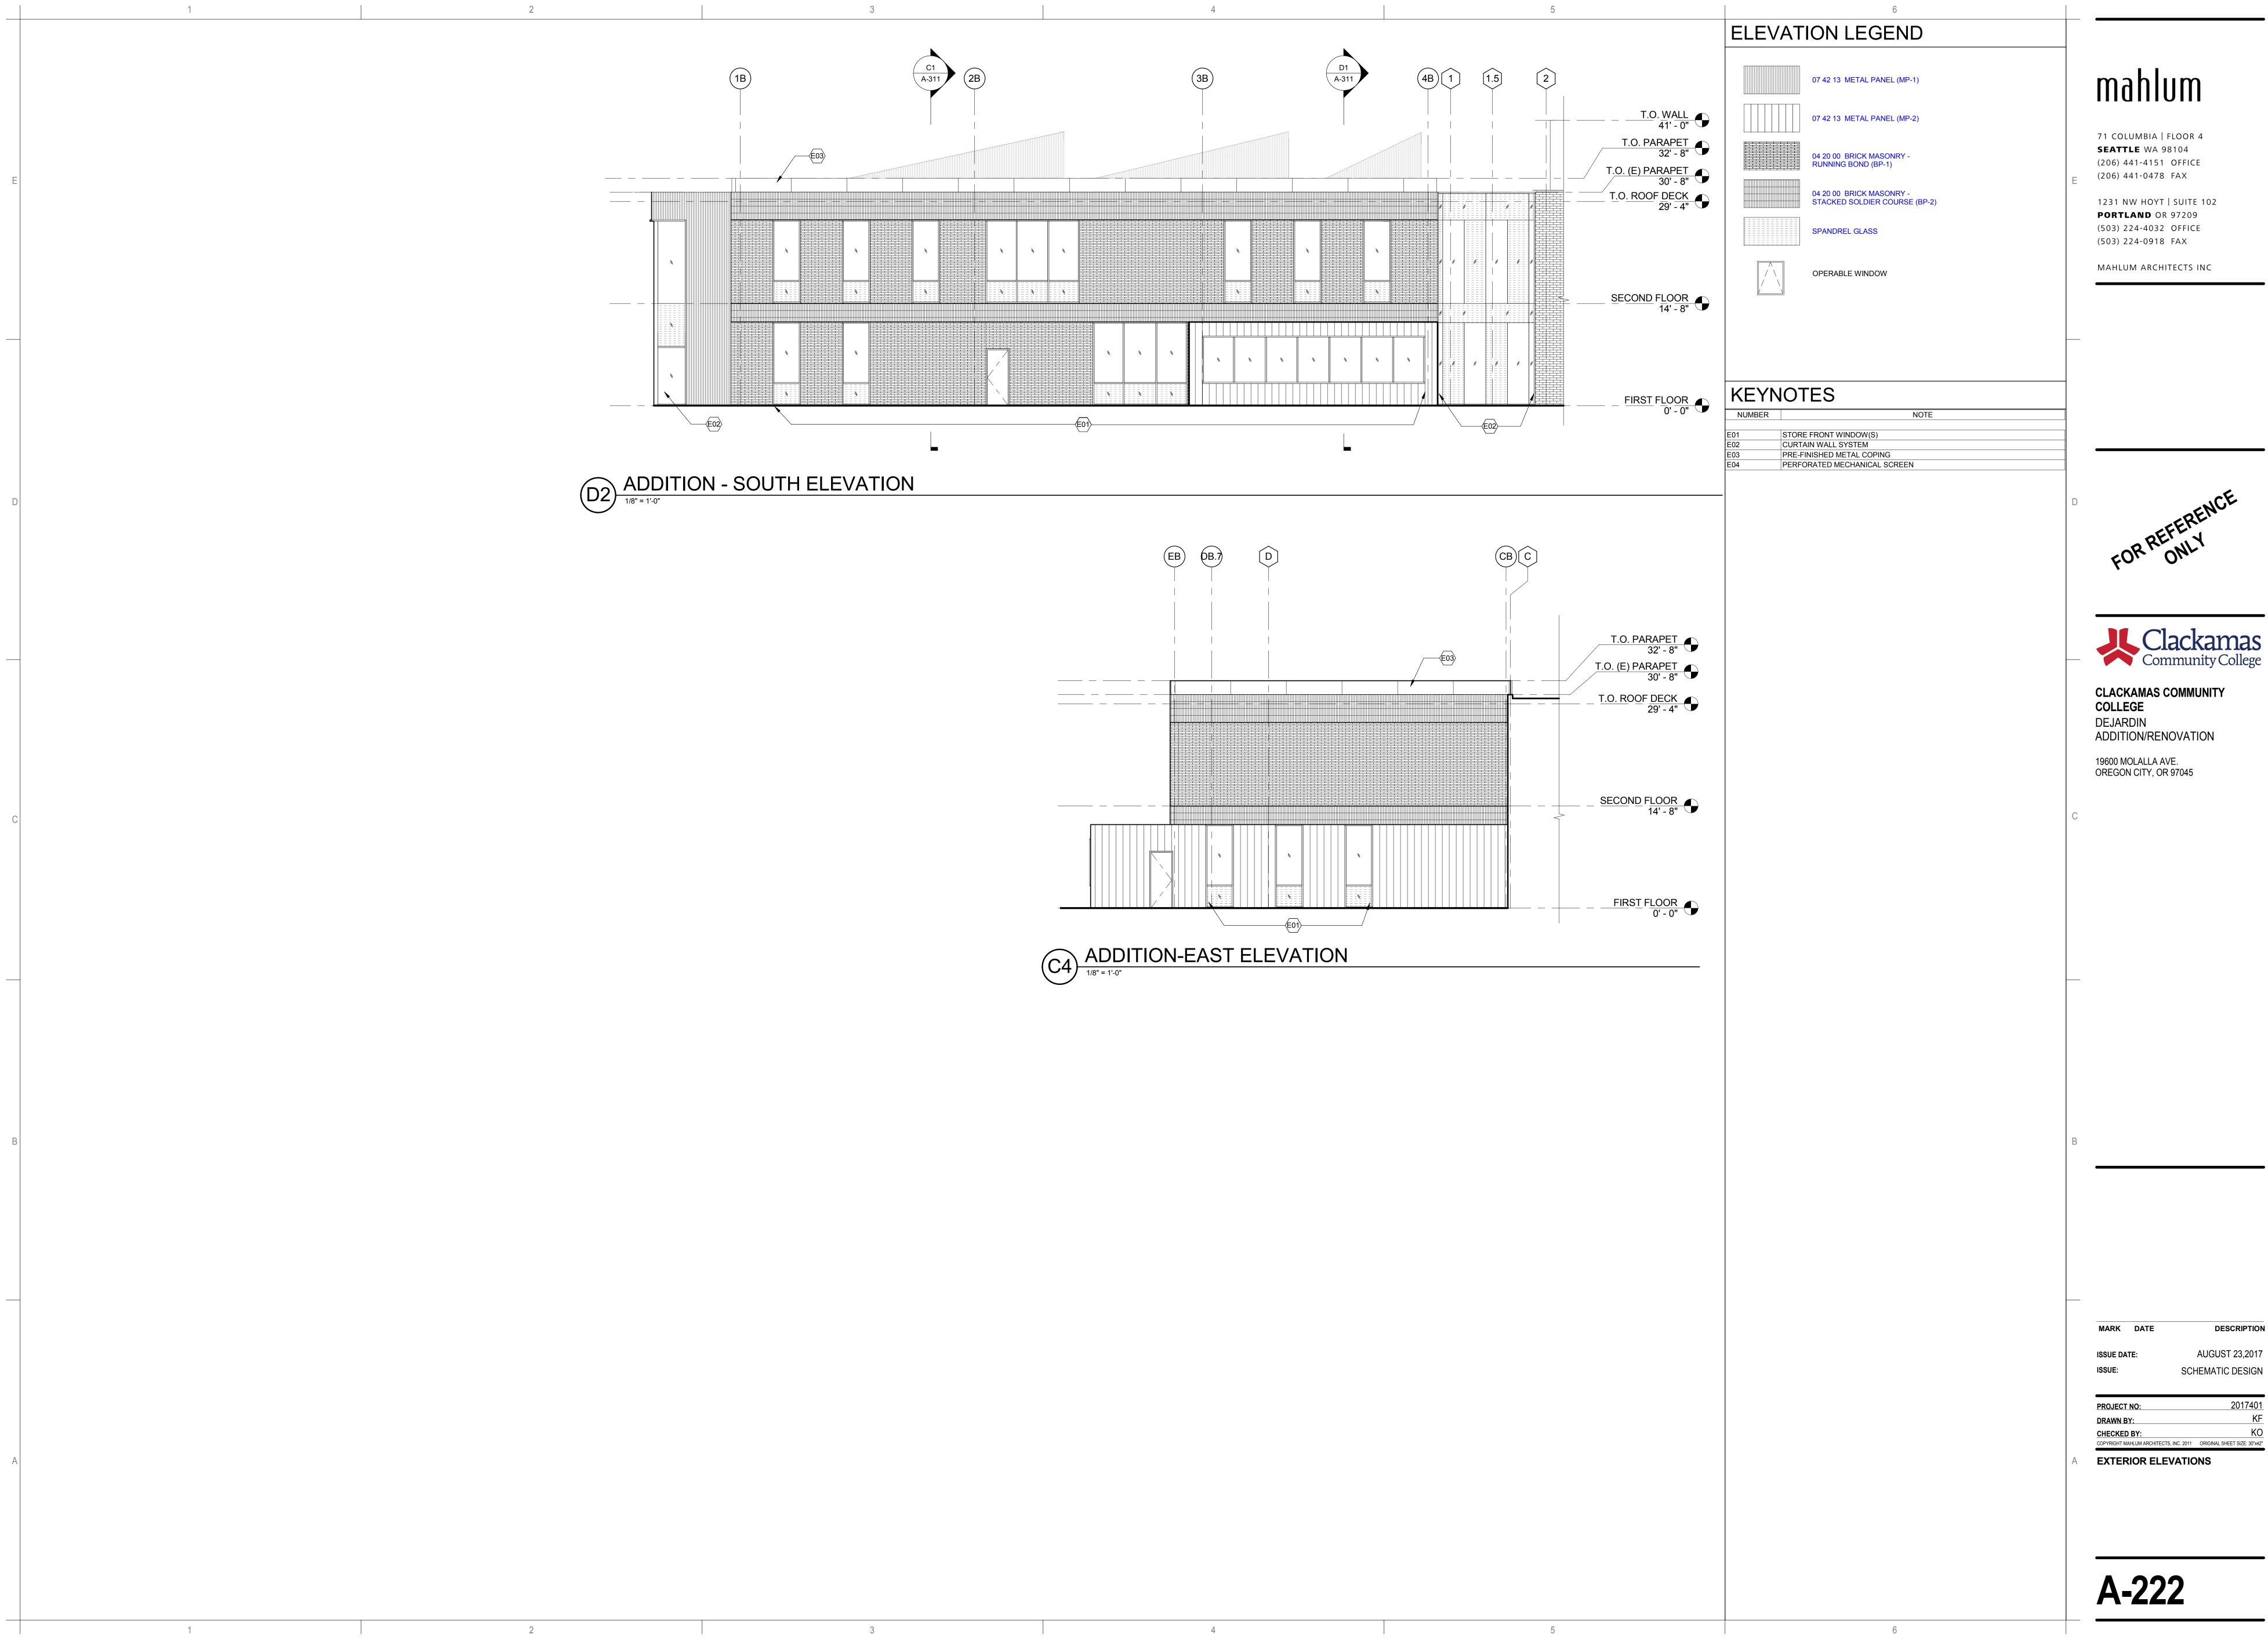


AUGUST 23,2017 SCHEMATIC DESIGN

2017401 COPYRIGHT MAHLUM ARCHITECTS, INC. 2011 ORIGINAL SHEET SIZE: 30"x42"

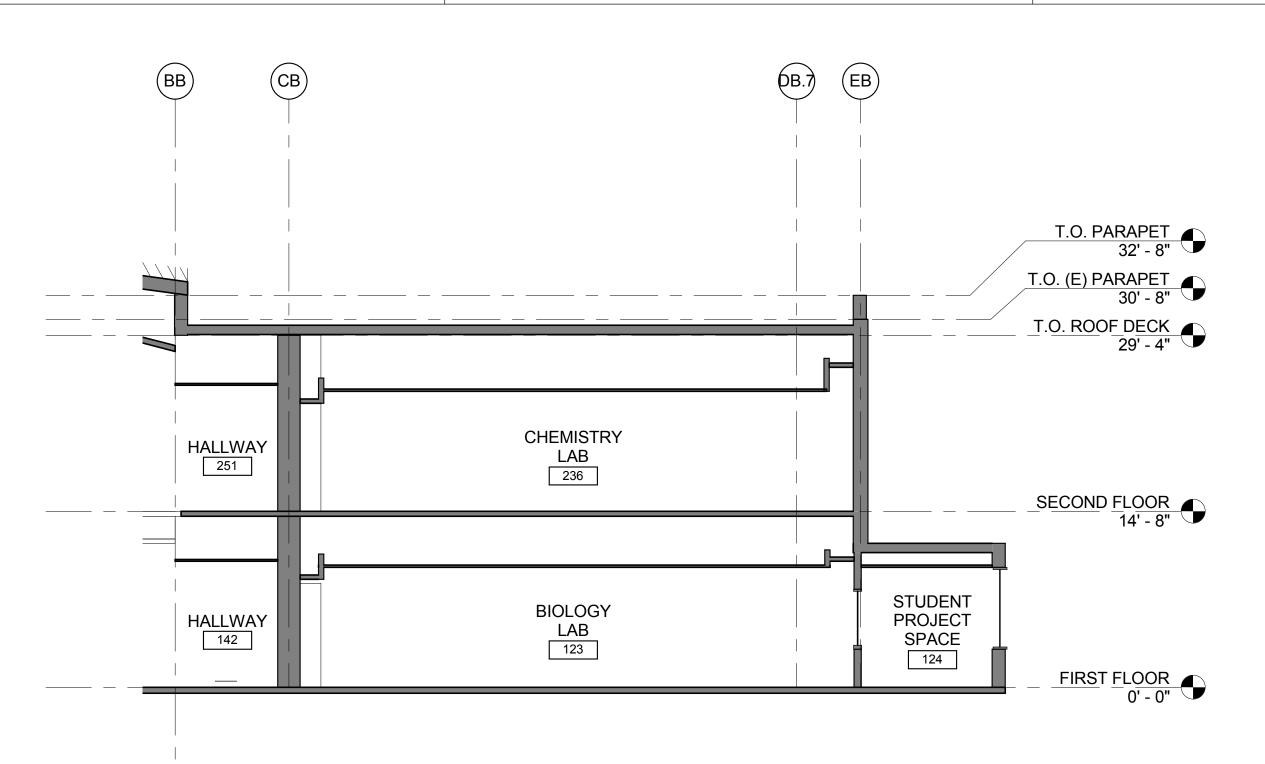


D1 ADDITION - NS SECTION THROUGH BUILDING EXTENSION

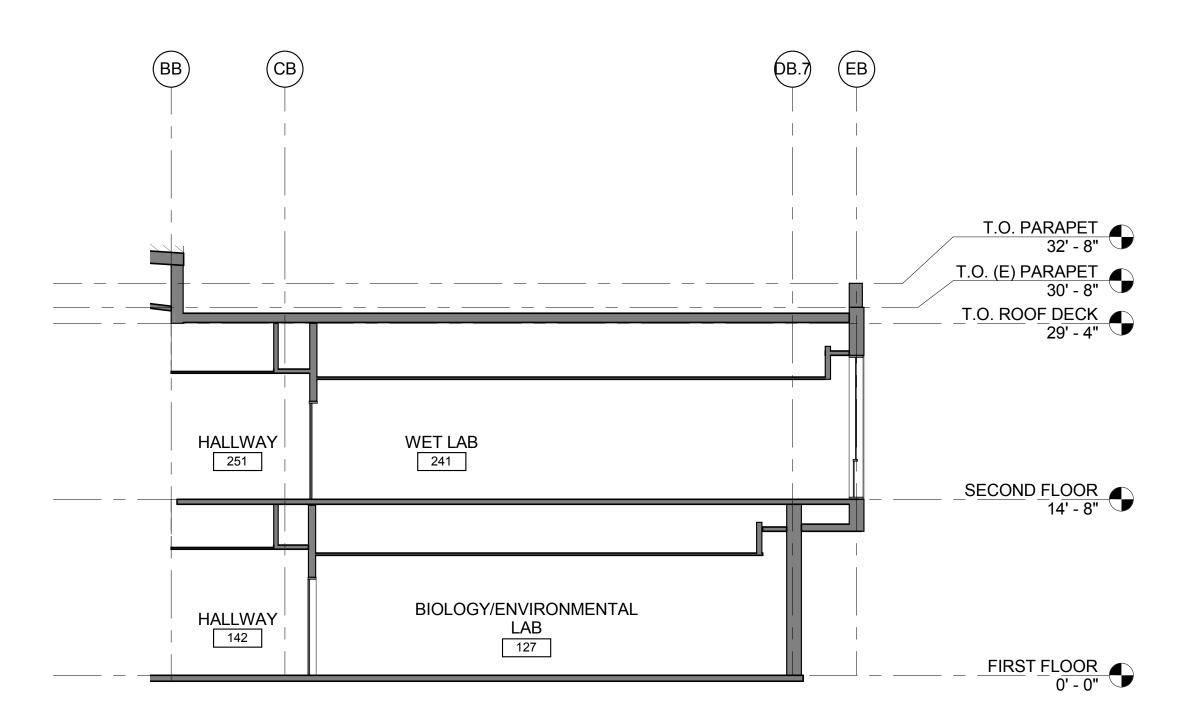


ADDITION - NS SECTION THROUGH BUILDING OVERHANG

1/8" = 1'-0"

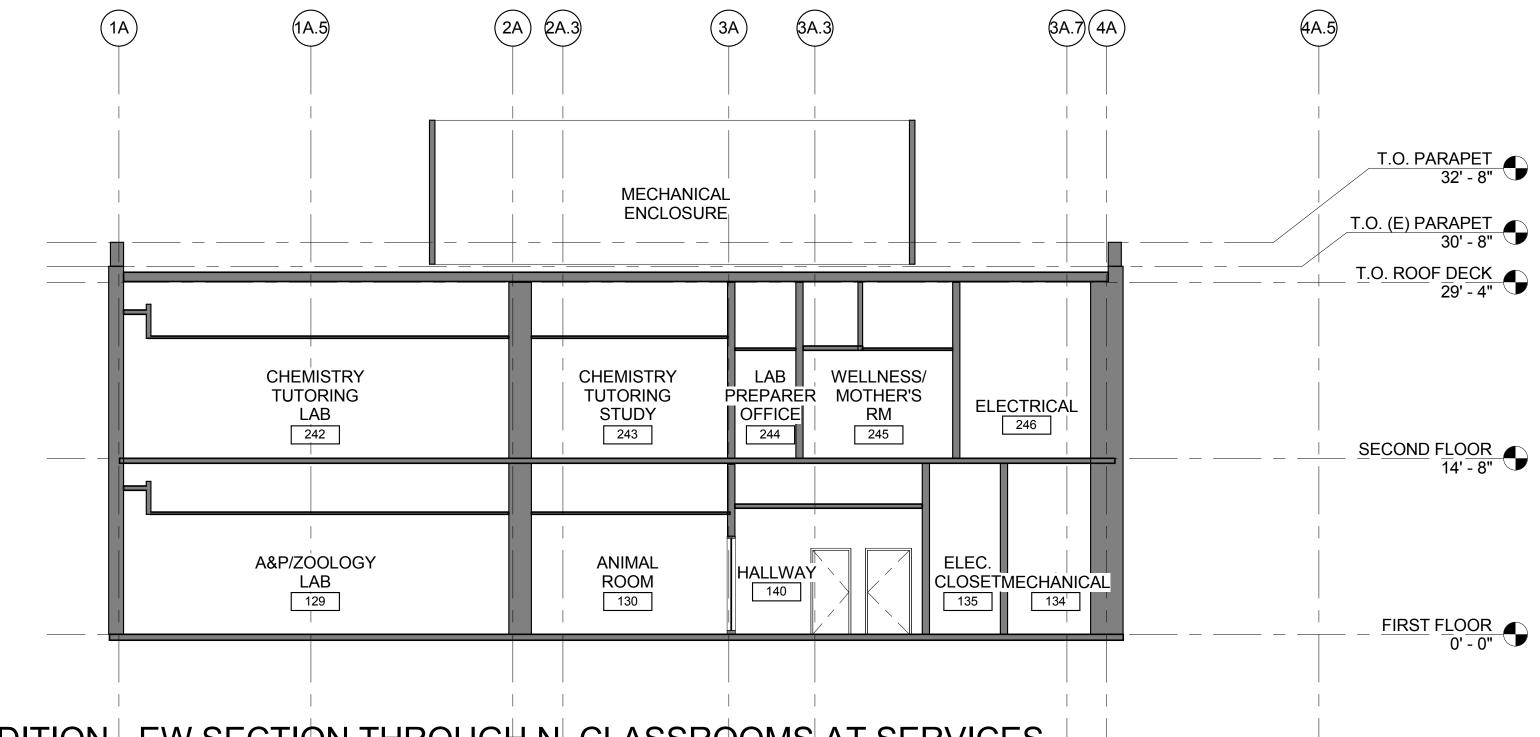


ADDITION - EW SECTION THROUGH N. CLASSROOMS AT SERVICES

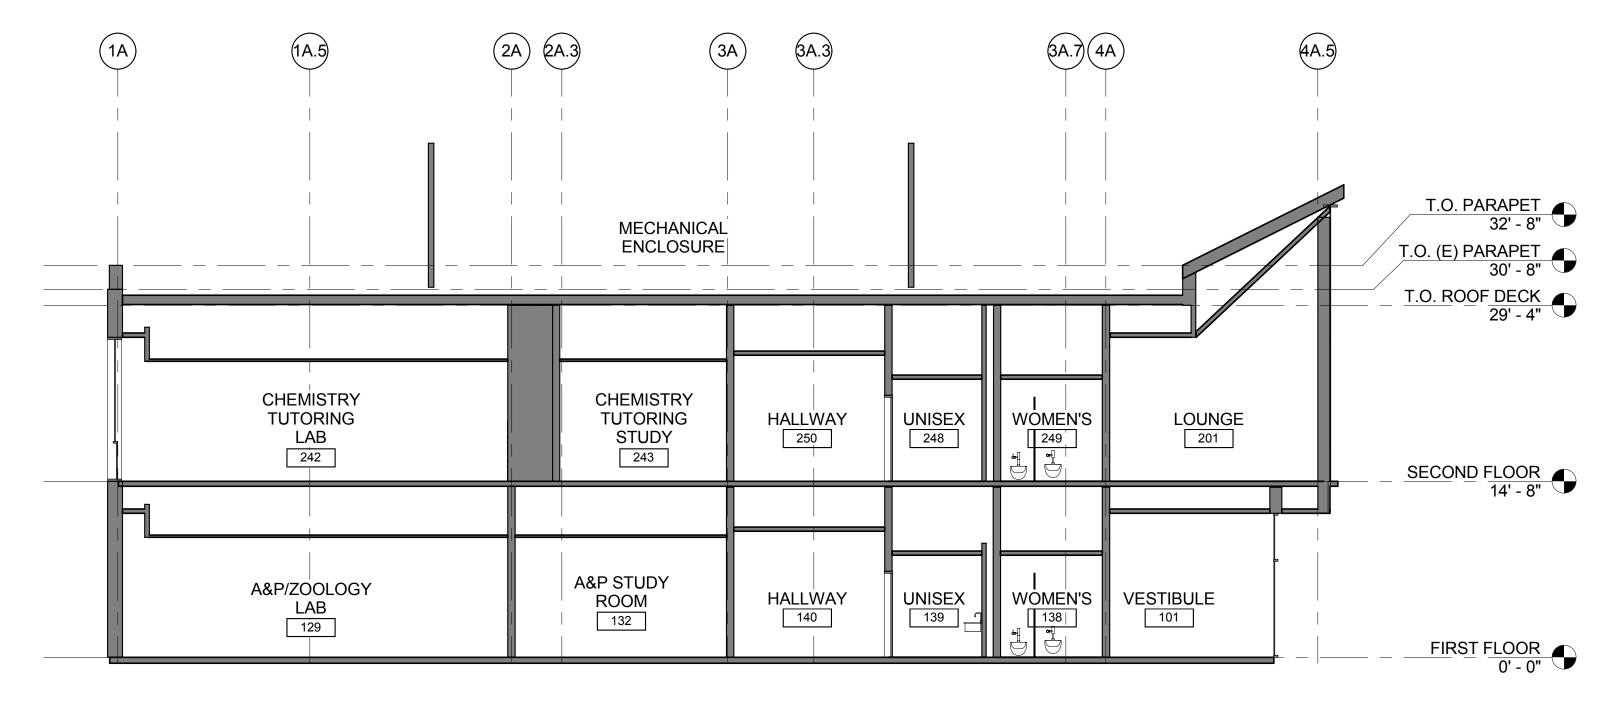

ADDITION - EW SECTION THROUGH N. CLASSROOMS AT ENTRY

1/8" = 1'-0"

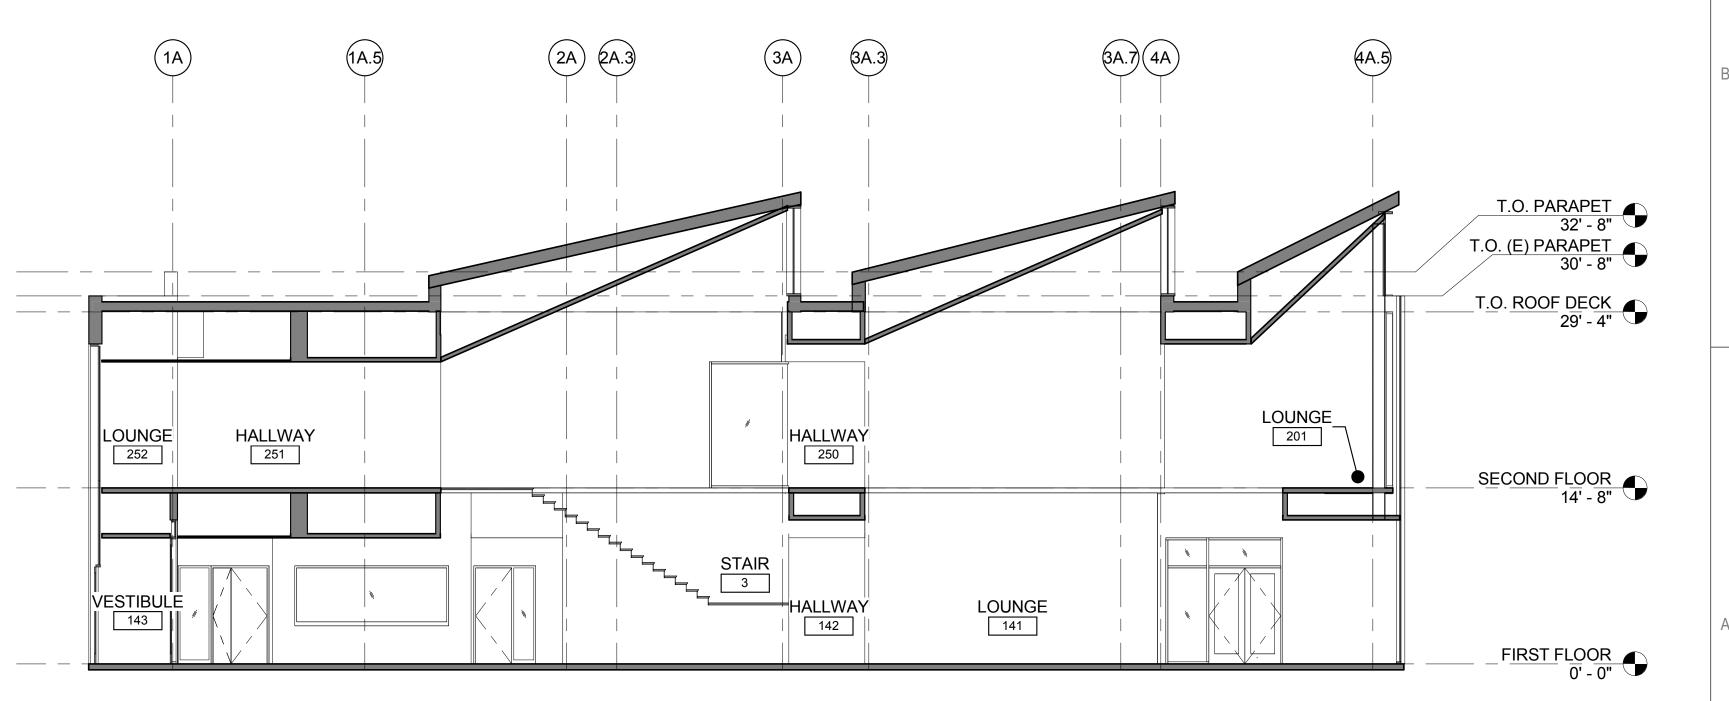

ADDITION - EW SECTION THROUGH MONITORS

1/8" = 1'-0"


mahlum

71 COLUMBIA | FLOOR 4 **SEATTLE** WA 98104
(206) 441-4151 OFFICE
(206) 441-0478 FAX

1231 NW HOYT | SUITE 102 **PORTLAND** OR 97209 (503) 224-4032 OFFICE

MAHLUM ARCHITECTS INC

(503) 224-0918 FAX

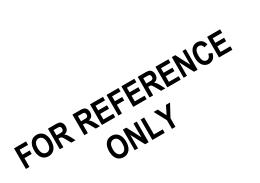



CLACKAMAS COMMUNITY COLLEGE DEJARDIN ADDITION/RENOVATION

19600 MOLALLA AVE. OREGON CITY, OR 97045

MARK DATE DESCRIPTION


ISSUE DATE: AUGUST 23,2017
ISSUE: SCHEMATIC DESIGN

PROJECT NO: 2017401
DRAWN BY: KF

COPYRIGHT MAHLUM ARCHITECTS, INC. 2011 ORIGINAL SHEET SIZE: 30"x42"

A-311

BUILDING SECTIONS

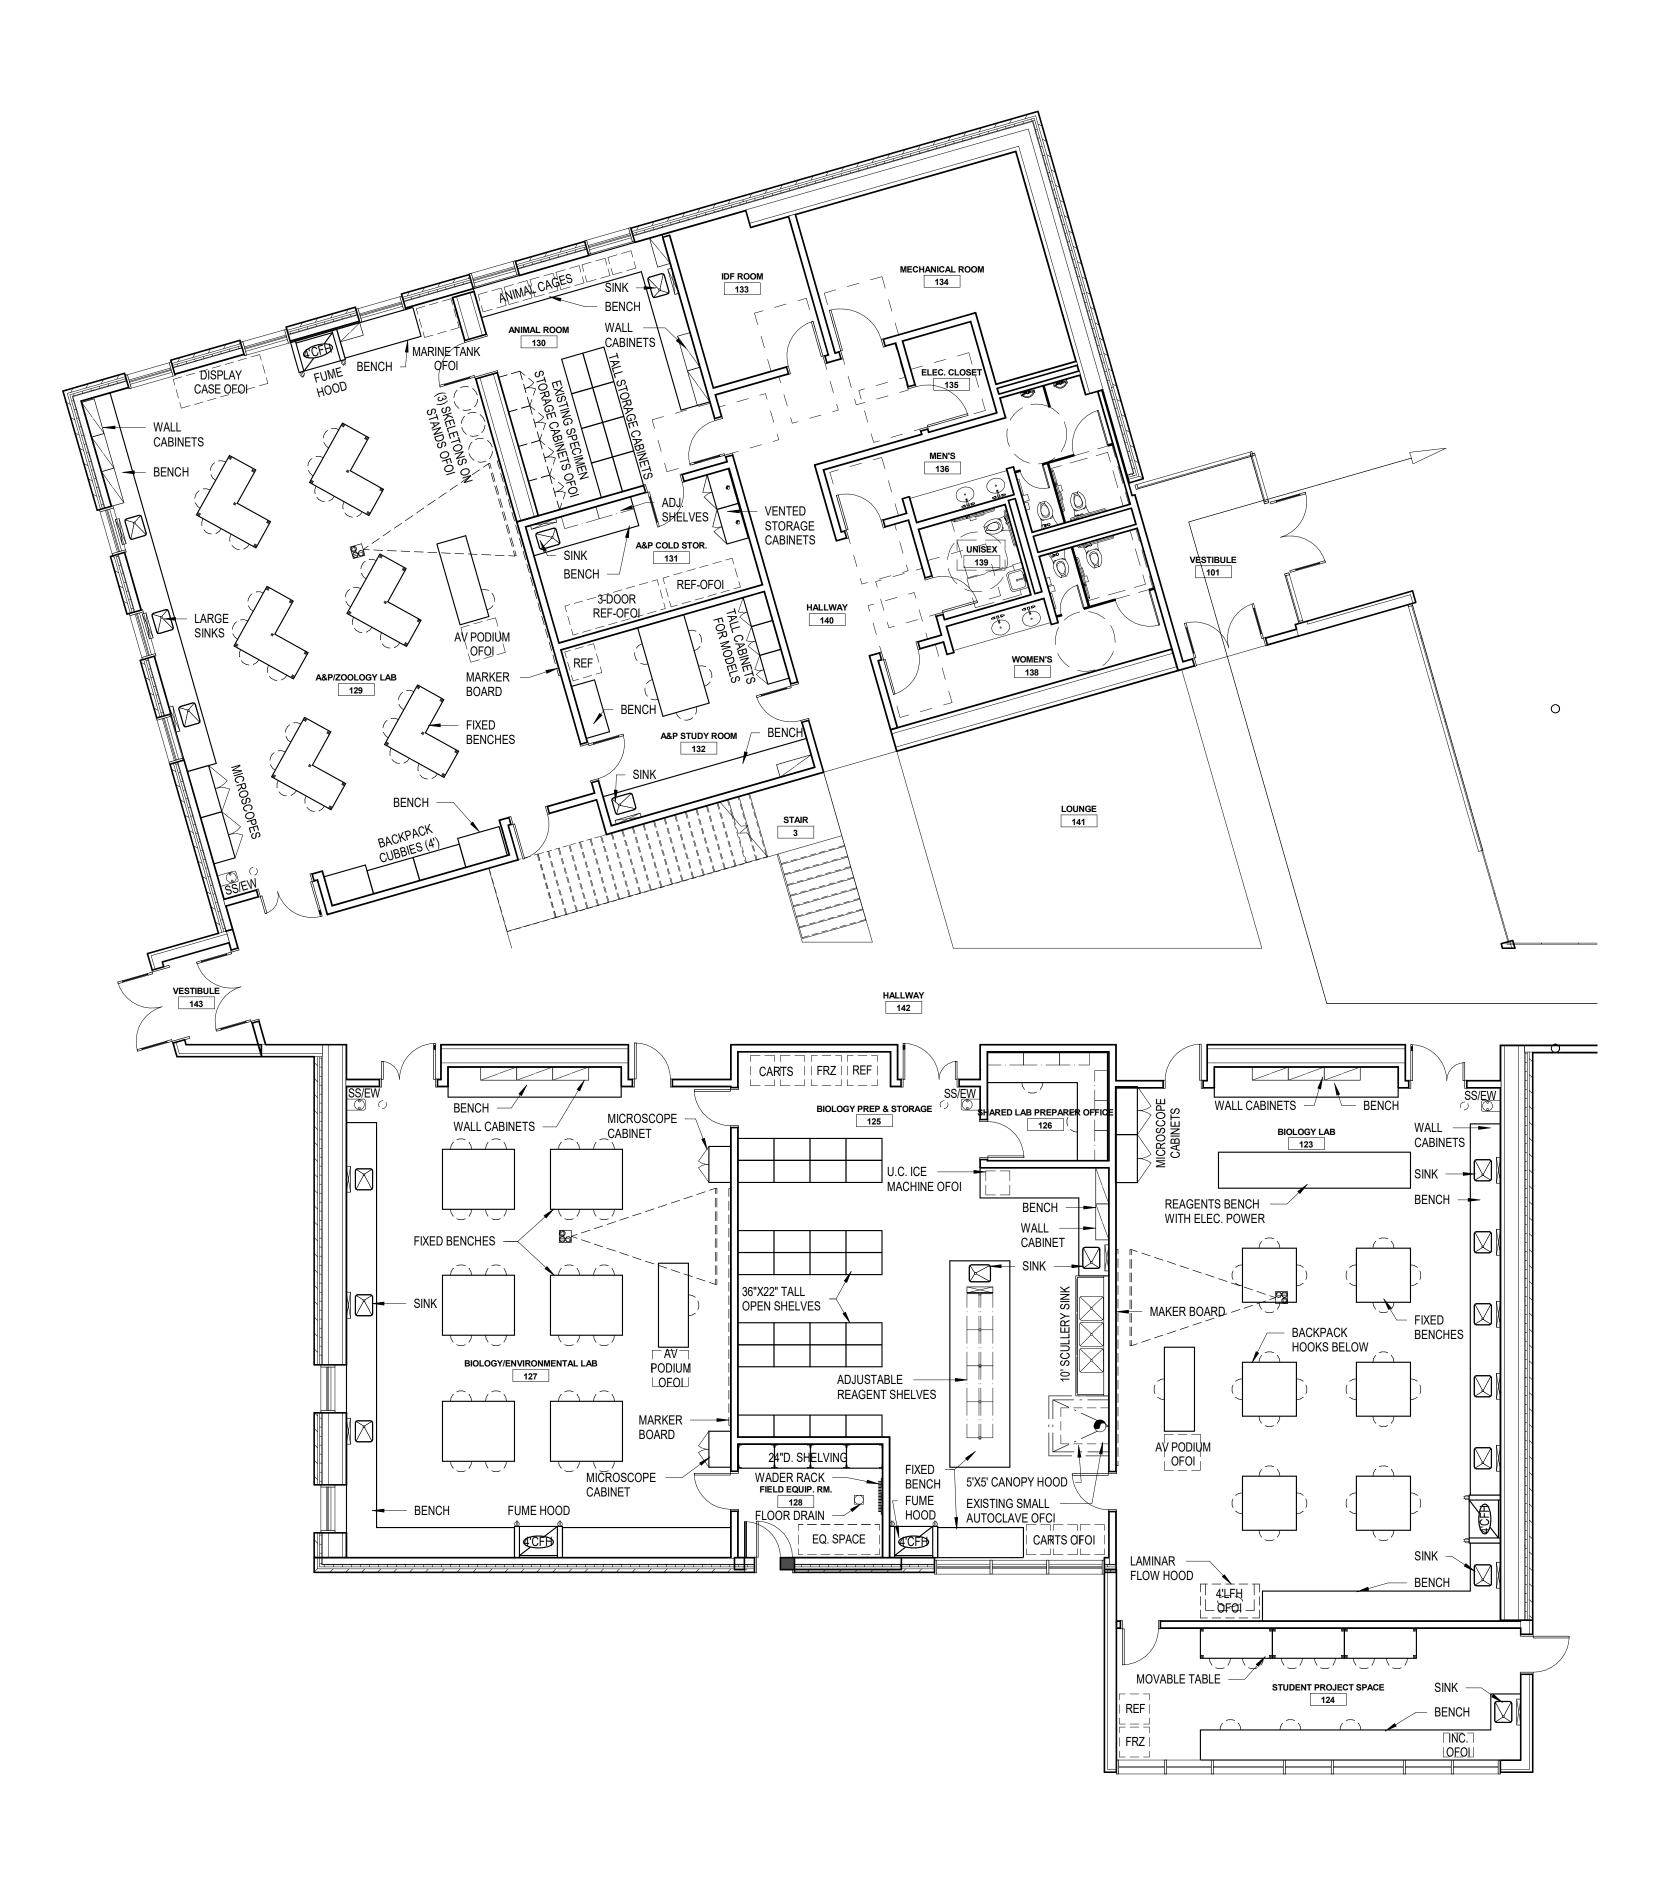

1) Level 1-PARTIAL PLAN 1/8" = 1'-0"

mahlum

71 COLUMBIA | FLOOR 4

SEATTLE WA 98104
(206) 441-4151 OFFICE
(206) 441-0478 FAX

1231 NW HOYT | SUITE 102 **PORTLAND** OR 97209 (503) 224-4032 OFFICE

MAHLUM ARCHITECTS INC

(503) 224-0918 FAX



RESEARCH FACILITIES DESIGN 3965 Fifth Avenue, Suite 400 San Diego, California 92103 TEL 619-297-0159 FAX 619-294-4901





Owne

Project Name

Enter address here

С

MARK DATE DESCRIPTION

ISSUE DATE: 8/22/1

PROJECT NO: Project Number


DRAWN BY: IM

CHECKED BY: MR

COPYRIGHT MAHLUM ARCHITECTS, INC. 2011 ORIGINAL SHEET SIZE: 30"x42"

A FIRST FLOOR PLAN - SECTOR 01
- LAB

LF-121A

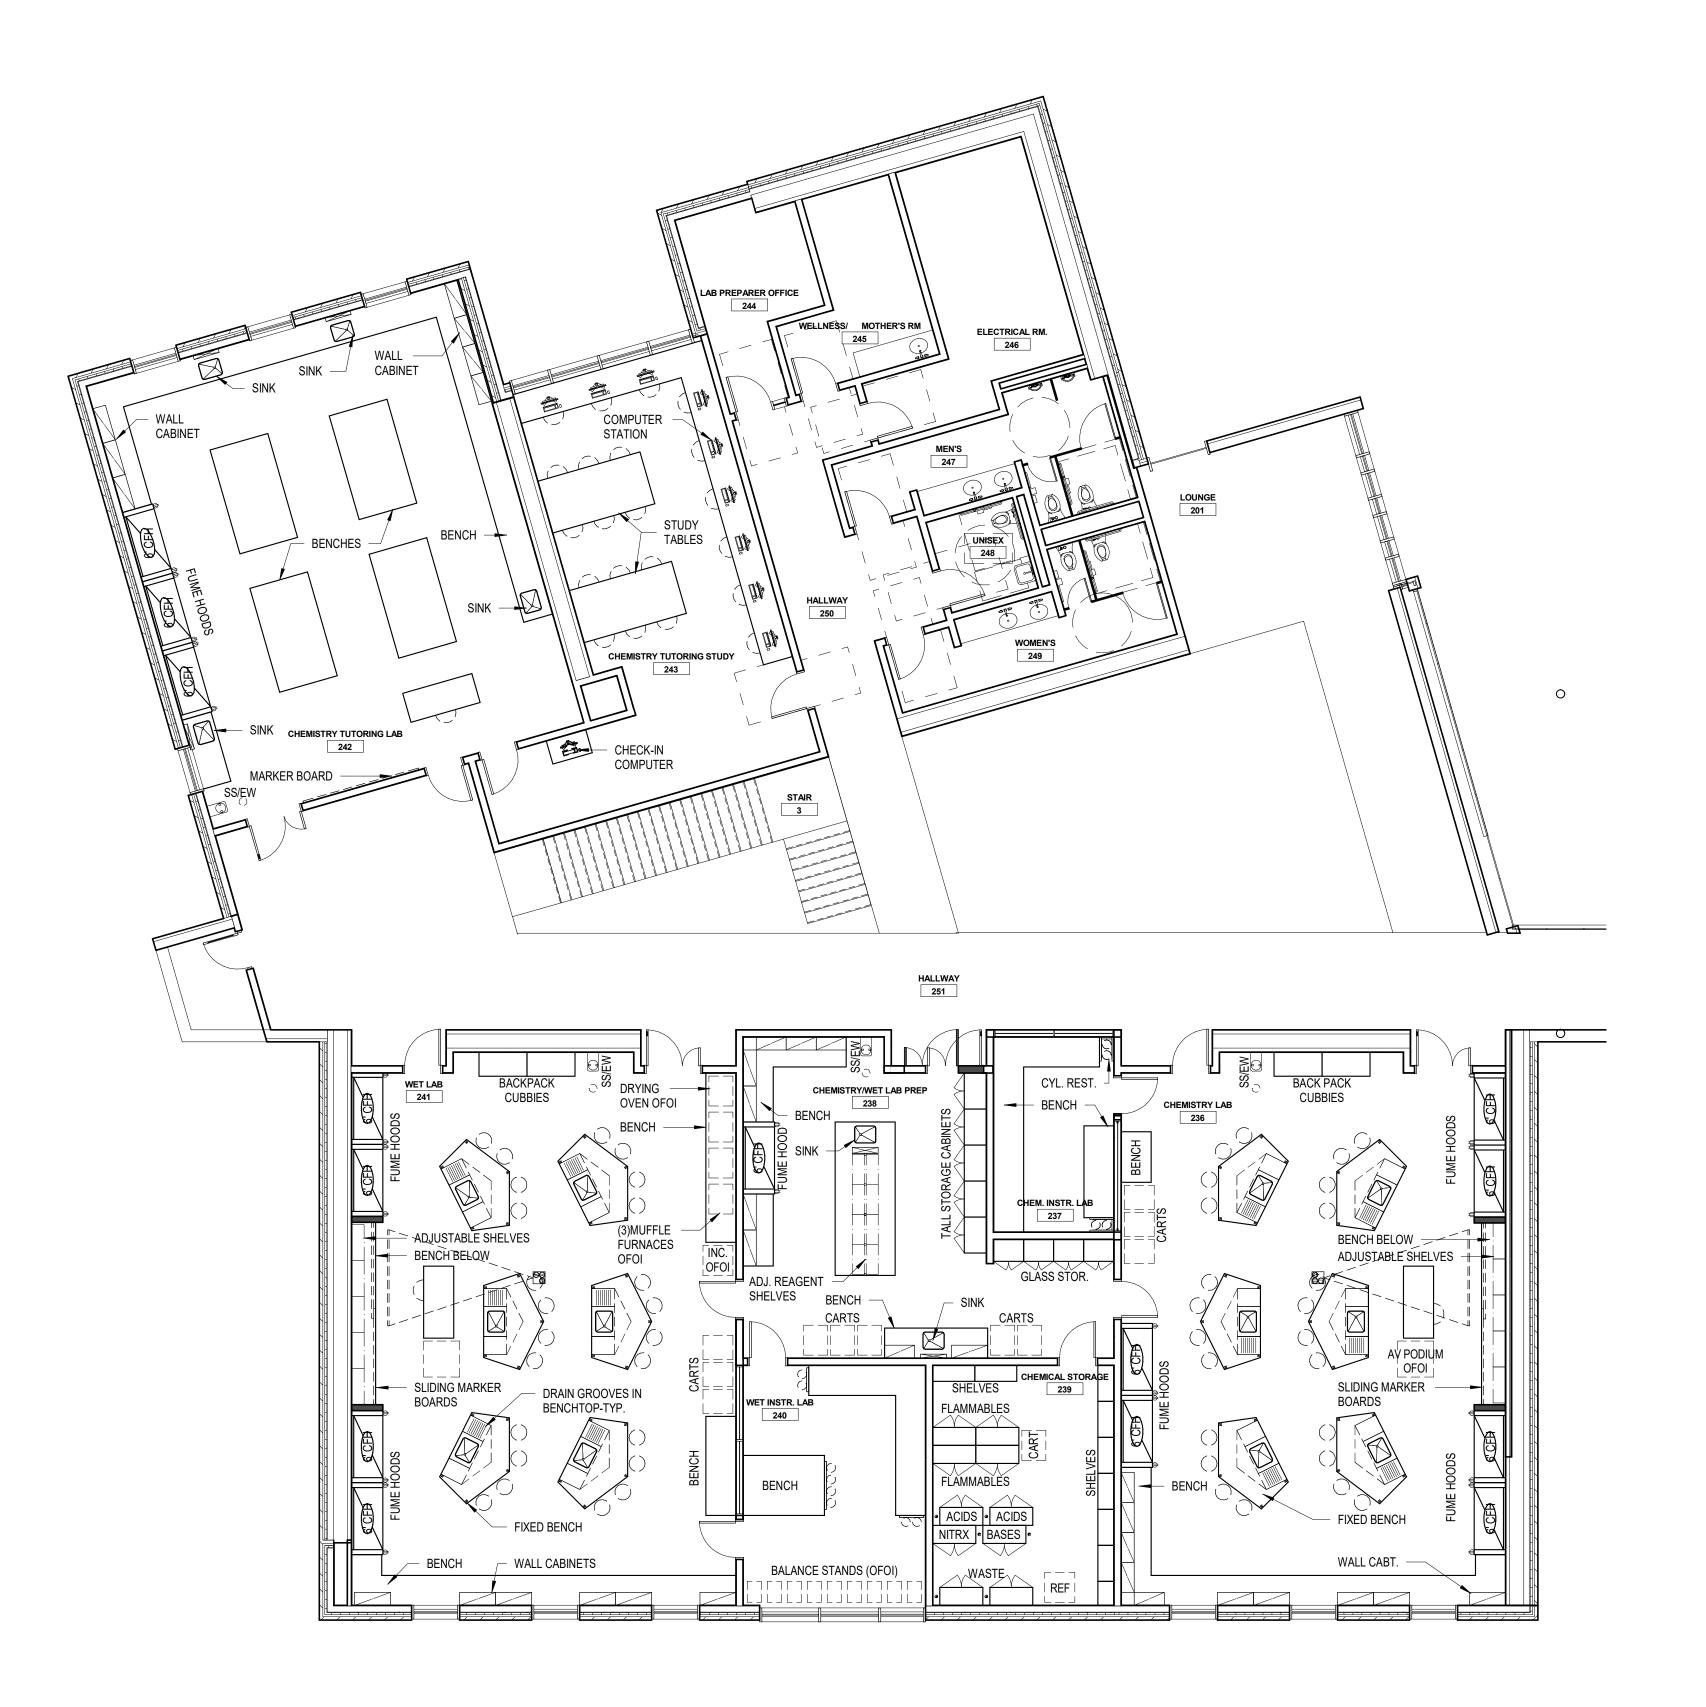

1 Level 2-PARTIAL PLAN
1/8" = 1'-0"

mahlum

71 COLUMBIA | FLOOR 4

SEATTLE WA 98104
(206) 441-4151 OFFICE
(206) 441-0478 FAX

1231 NW HOYT | SUITE 102 **PORTLAND** OR 97209 (503) 224-4032 OFFICE (503) 224-0918 FAX

MAHLUM ARCHITECTS INC



RESEARCH FACILITIES DESIGN 3965 Fifth Avenue, Suite 400 San Diego, California 92103 TEL 619-297-0159 FAX 619-294-4901





Owr

Project Name

Enter address here

ISSUE DATE: 8/22/

PROJECT NO: Project Number


DRAWN BY: Author

CHECKED BY: Checker

COPYRIGHT MAHLUM ARCHITECTS, INC. 2011 ORIGINAL SHEET SIZE: 30"x42"

SECOND FLOOR PLAN - SECTOR 01 - LAB

LF-122A

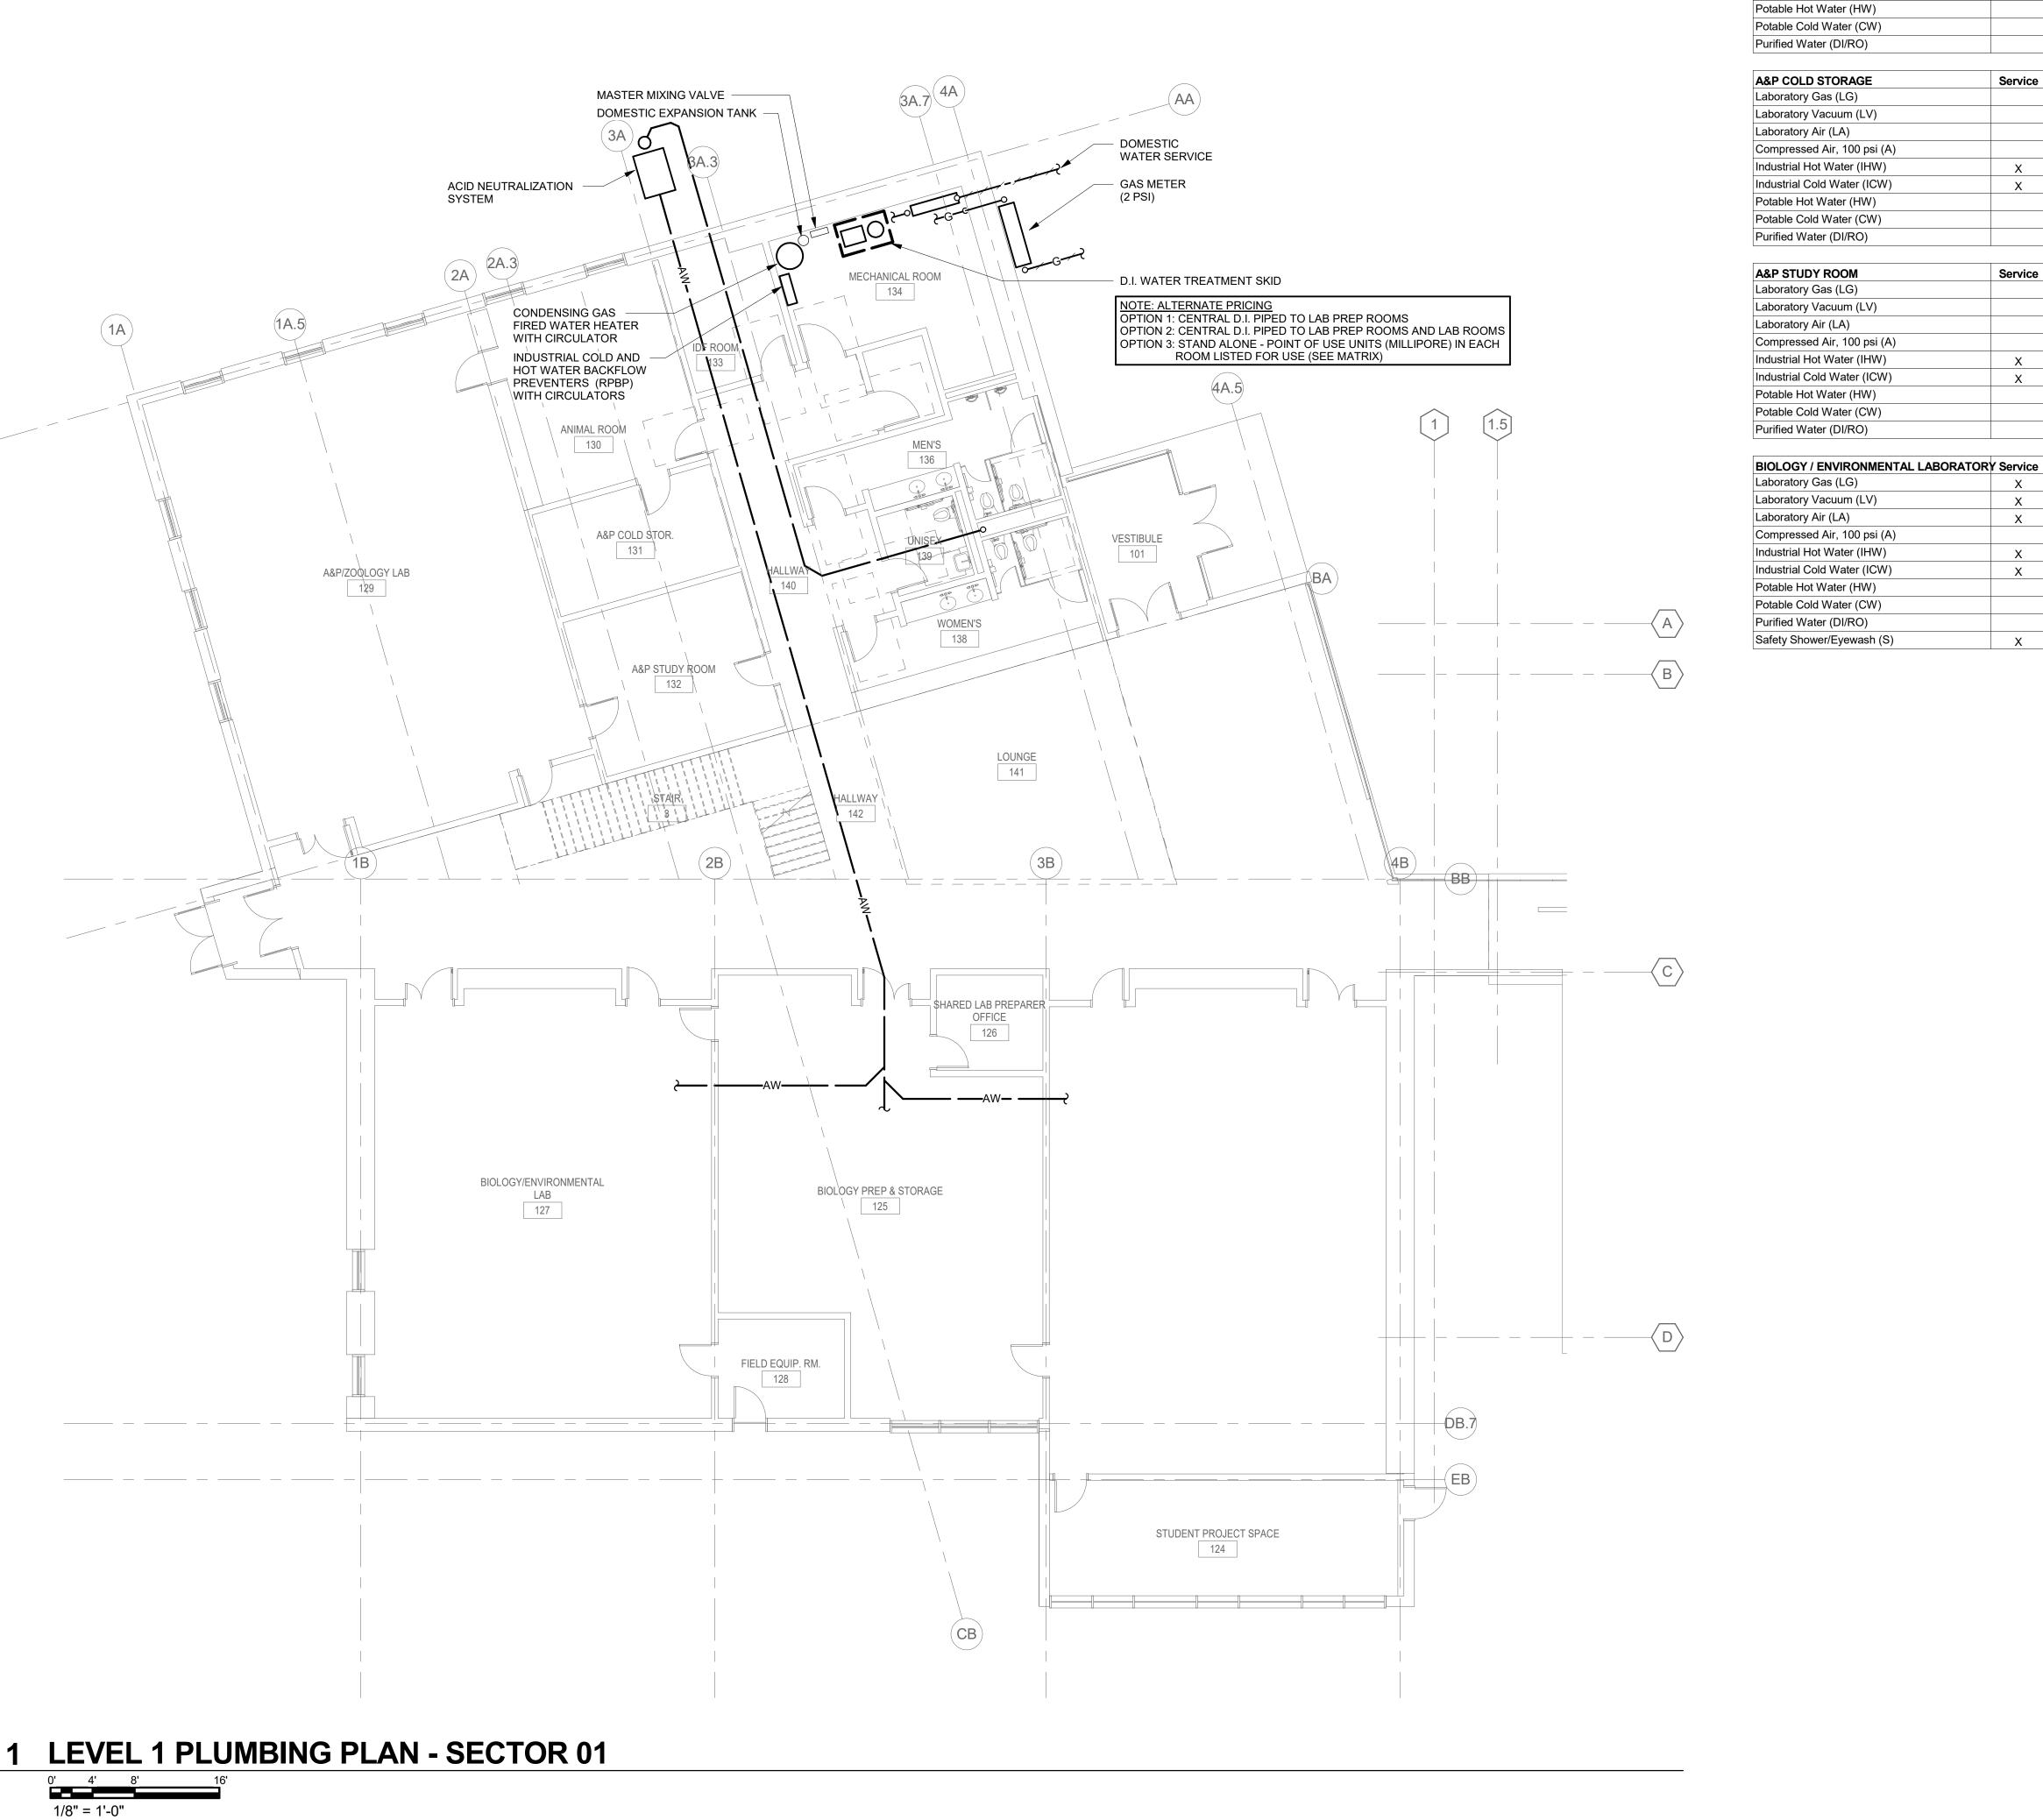

A&P / ZOOLOGY LABORATORY	Service
Laboratory Gas (LG)	Х
Laboratory Vacuum (LV)	Х
Laboratory Air (LA)	Х
Compressed Air, 100 psi (A)	
Industrial Hot Water (IHW)	Х
Industrial Cold Water (ICW)	Х
Potable Hot Water (HW)	
Potable Cold Water (CW)	
Purified Water (DI/RO)	
Safety Shower/Eyewash (S)	Х
A&P STORAGE / LIVE ANIMAL ROOM	
Laboratory Gas (LG)	
Laboratory Vacuum (LV)	
Laboratory Air (LA)	
Compressed Air, 100 psi (A)	
Industrial Hot Water (IHW)	X
Industrial Cold Water (ICW)	X
Potable Hot Water (HW)	
Potable Cold Water (CW)	
Purified Water (DI/RO)	
A&P COLD STORAGE	Service
Laboratory Gas (LG)	
Laboratory Vacuum (LV)	
Laboratory Air (LA)	
Compressed Air, 100 psi (A)	
Industrial Hot Water (IHW)	X
Industrial Cold Water (ICW)	X
Potable Hot Water (HW)	
Potable Cold Water (CW)	
Purified Water (DI/RO)	
A&P STUDY ROOM	Service
Laboratory Gas (LG)	
Laboratory Vacuum (LV)	
Laboratory Air (LA)	
0 14: 400 : (4)	
Compressed Air, 100 psi (A)	
Industrial Hot Water (IHW) Industrial Cold Water (ICW)	Х

FIELD EQUIPMENT Floor drain	
-loor drain	X
BIOLOGY PREP & STORAGE	Service
Laboratory Gas (LG)	X
Autoclave	X
Laboratory Air (LA)	Х
Compressed Air, 100 psi (A)	
Industrial Hot Water (IHW)SOFT Autoclave	X
Industrial Cold Water (ICW)	X
Potable Hot Water (HW)	
Potable Cold Water (CW)	
Purified Water (DI/RO)	Х
Safety Shower/Eyewash (S)	X
BIOLOGY LABORATORY	Service
Laboratory Gas (LG)	X
Laboratory Vacuum (LV)	X
Laboratory Air (LA)	X
Compressed Air, 100 psi (A)	
Industrial Hot Water (IHW)	X
Industrial Cold Water (ICW)	X
Potable Hot Water (HW)	
Potable Cold Water (CW)	
Purified Water (DI/RO)	X
Safety Shower/Eyewash (S)	X
DIOLOGY OTHER TO STORE	
BIOLOGY STUDENT PROJECTS Laboratory Gas (LG)	Service
Laboratory Vacuum (LV)	
Laboratory Air (LA)	
Compressed Air, 100 psi (A)	
Industrial Hot Water (IHW)	
<u> </u>	X
Industrial Cold Water (ICW)	X
Potable Hot Water (HW)	

Potable Cold Water (CW)

Safety Shower/Eyewash (S)

Purified Water (DI/RO)



71 COLUMBIA | FLOOR 4 **SEATTLE** WA 98104 (206) 441-4151 OFFICE (206) 441-0478 FAX

(503) 224-0918 FAX

www.interfaceengineering.com


1231 NW HOYT | SUITE 102 PORTLAND OR 97209 (503) 224-4032 OFFICE

MAHLUM ARCHITECTS INC

PROJECT 2017-0180
CONTACT Scott Holum

INTERFACE
ENGINEERING

100 SW Main St.
Suite 1600
Portland, OR 97204
TEL 503.382.2266
FAX 503.382.2262

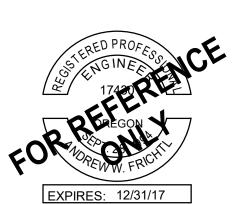



CLACKAMAS COMMUNITY COLLEGE DEJARDIN ADDITION/RENOVATION

19600 MOLALLA AVE. OREGON CITY, OR 97045

MARK DATE

ISSUE DATE: AUGUST 23, 2017
ISSUE: SCHEMATIC DESIGN

DESCRIPTION

PROJECT NO: Project Number

DRAWN BY: Author


CHECKED BY: Checker

COPYRIGHT MAHLUM ARCHITECTS, INC. 2011 ORIGINAL SHEET SIZE: 30"x42"

FIRST FLOOR PLAN - SECTOR 01 -

FIRST FLOOR PLAN - SECTOR 01 - PLUMBING

P-211A

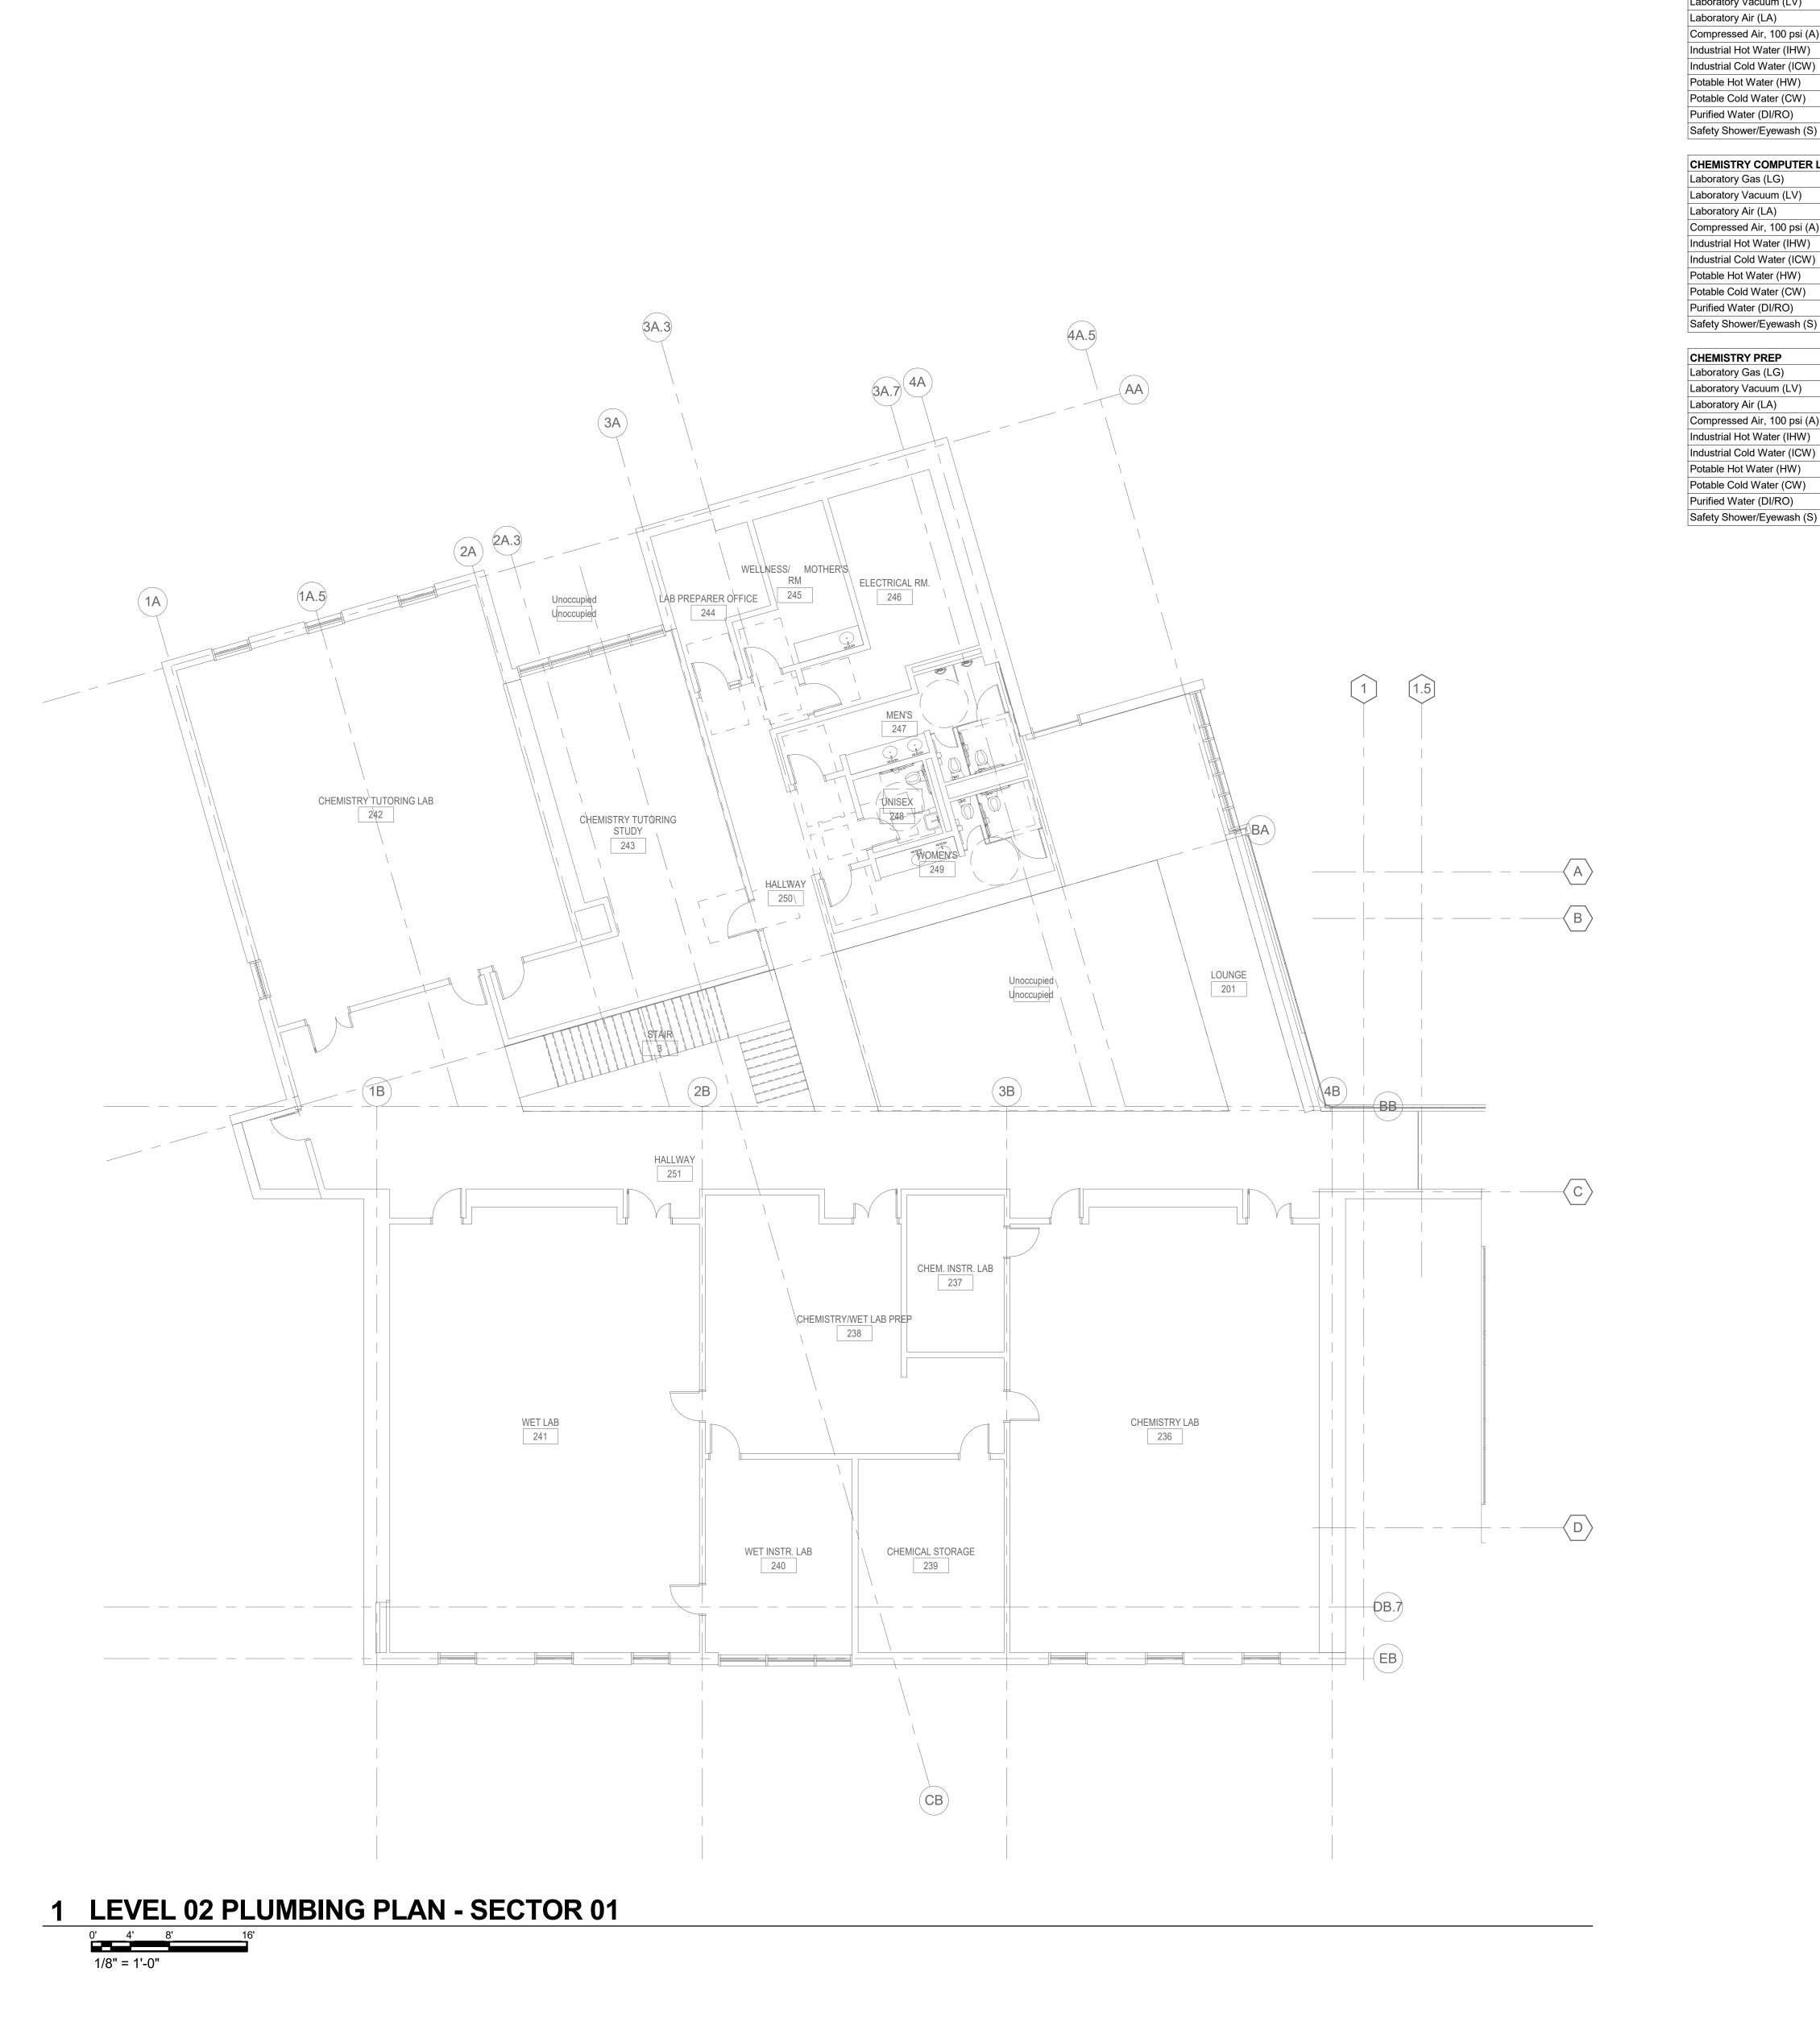

CHEMISTRY TUTOR LABORATORY

Laboratory Gas (LG)

Laboratory Vacuum (LV)

Laboratory Air (LA)

Compressed Air, 100 psi (A)

Industrial Hot Water (IHW)

Industrial Cold Water (ICW)

Potable Hot Water (HW)

Potable Cold Water (CW)

Purified Water (DI/RO)

Safety Shower/Eyewash (S)

CHEMISTRY COMPUTER LABORATORY	Service
aboratory Gas (LG)	Х
_aboratory Vacuum (LV)	Х
_aboratory Air (LA)	Х
Compressed Air, 100 psi (A)	
ndustrial Hot Water (IHW)	
ndustrial Cold Water (ICW)	Х
Potable Hot Water (HW)	
Potable Cold Water (CW)	
Purified Water (DI/RO)	Х
Safety Shower/Eyewash (S)	

Safety Snower/Eyewash (S)	
CHEMISTRY PREP	Service
aboratory Gas (LG)	X
aboratory Vacuum (LV)	X
aboratory Air (LA)	X
Compressed Air, 100 psi (A)	
ndustrial Hot Water (IHW)	Х
ndustrial Cold Water (ICW)	X
Potable Hot Water (HW)	
Potable Cold Water (CW)	
Purified Water (DI/RO)	Х
2-f-t-0l	

CHEMISTRY INSTRUMENT ROOM	Service
CYLINDER GASES - INTERT	Х
CYLINDER GASES - FLAMMABLE	Х
Laboratory Air (LA)	Х
Compressed Air, 100 psi (A)	
Industrial Hot Water (IHW)	
Industrial Cold Water (ICW)	
Potable Hot Water (HW)	
Potable Cold Water (CW)	
Purified Water (DI/RO)	
Safety Shower/Eyewash (S)	

	X Laboratory Gas (LG) X Laboratory Vacuum (LV) X Laboratory Air (LA)	
ATORY	Service	WET LABORATORY
	X	Laboratory Gas (LG)
	X	Laboratory Vacuum (LV)
	X	Laboratory Air (LA)
		Compressed Air, 100 psi (A)
		Industrial Hot Water (IHW)
	X	Industrial Cold Water (ICW)
		Potable Hot Water (HW)
		Potable Cold Water (CW)
	X	Purified Water (DI/RO)
		Safety Shower/Eyewash (S)

WET INSTRUMENT ROOM	Service
CYLINDER GASES - INTERT	X
CYLINDER GASES - FLAMMABLE	X
Laboratory Air (LA)	X
Compressed Air, 100 psi (A)	
Industrial Hot Water (IHW)	
Industrial Cold Water (ICW)	
Potable Hot Water (HW)	
Potable Cold Water (CW)	
Purified Water (DI/RO)	
Safety Shower/Evewash (S)	



71 COLUMBIA | FLOOR 4 **SEATTLE** WA 98104 (206) 441-4151 OFFICE (206) 441-0478 FAX

1231 NW HOYT | SUITE 102 **PORTLAND** OR 97209 (503) 224-4032 OFFICE

MAHLUM ARCHITECTS INC

PROJECT 2017-0180 CONTACT Scott Holum

www.interfaceengineering.com

(503) 224-0918 FAX

INTERFACE ENGINEERING

100 SW Main St.
Suite 1600
Portland, OR 97204
TEL 503.382.2266
FAX 503.382.2262





CLACKAMAS COMMUNITY COLLEGE DEJARDIN ADDITION/RENOVATION

19600 MOLALLA AVE. OREGON CITY, OR 97045

MARK DAT

AUGUST 23, 2017 SCHEMATIC DESIGN

PROJECT NO: Project Number


DRAWN BY: Author

CHECKED BY: Checker

COPYRIGHT MAHLUM ARCHITECTS, INC. 2011 ORIGINAL SHEET SIZE: 30"x42"

SECOND FLOOR PLAN - SECTOR 01 - PLUMBING

P-221A

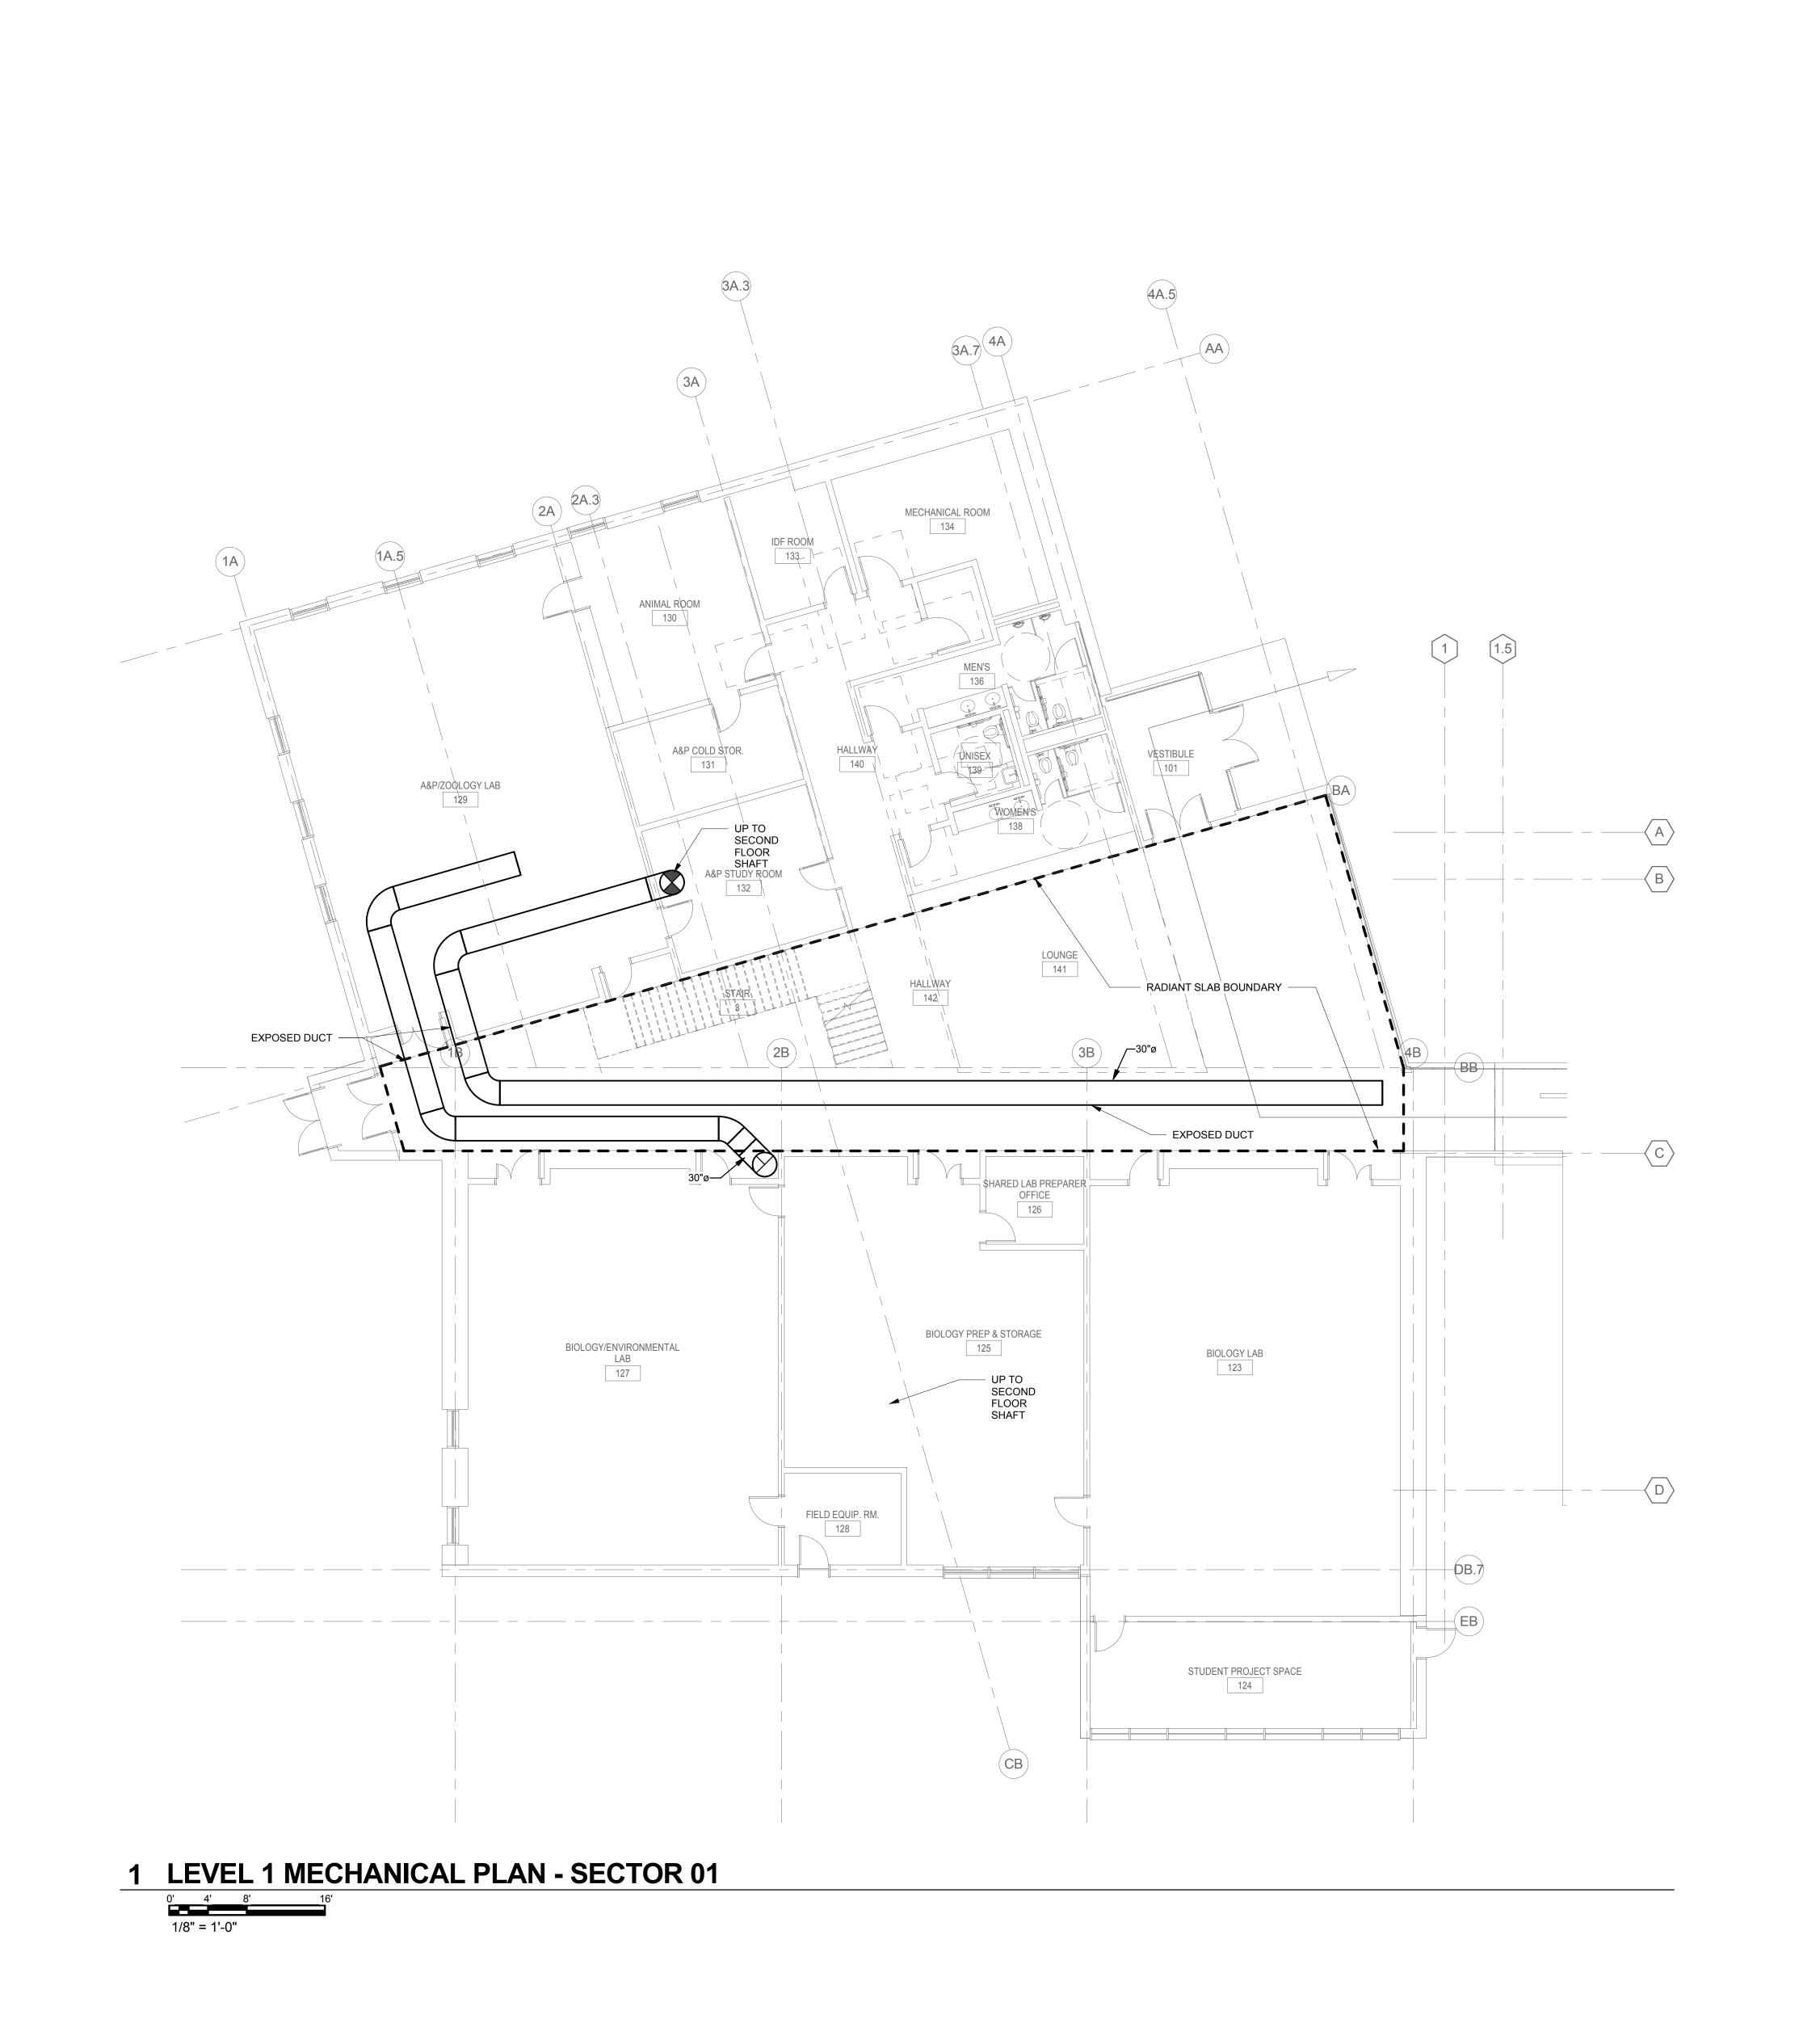

mahlum

71 COLUMBIA | FLOOR 4 **SEATTLE** WA 98104 (206) 441-4151 OFFICE (206) 441-0478 FAX

1231 NW HOYT | SUITE 102 **PORTLAND** OR 97209 (503) 224-4032 OFFICE

MAHLUM ARCHITECTS INC

(503) 224-0918 FAX

PROJECT 2017-0180
CONTACT Shem Heiple

INTERFACE
ENGINEERING

100 SW Main St.
Suite 1600
Portland, OR 97204
TEL 503.382.2266
FAX 503.382.2262
www.interfaceengineering.com





CLACKAMAS COMMUNITY COLLEGE DEJARDIN ADDITION/RENOVATION

19600 MOLALLA AVE. OREGON CITY, OR 97045

MARK DATE

UE DATE: AUGUST 23, 2
UE: SCHEMATIC DES

PROJECT NO: Project Number


DRAWN BY: Author

CHECKED BY: Checker

COPYRIGHT MAHLUM ARCHITECTS, INC. 2011 ORIGINAL SHEET SIZE: 30"x42"

FIRST FLOOR PLAN - SECTOR 01 - MECHANICAL

M-211A

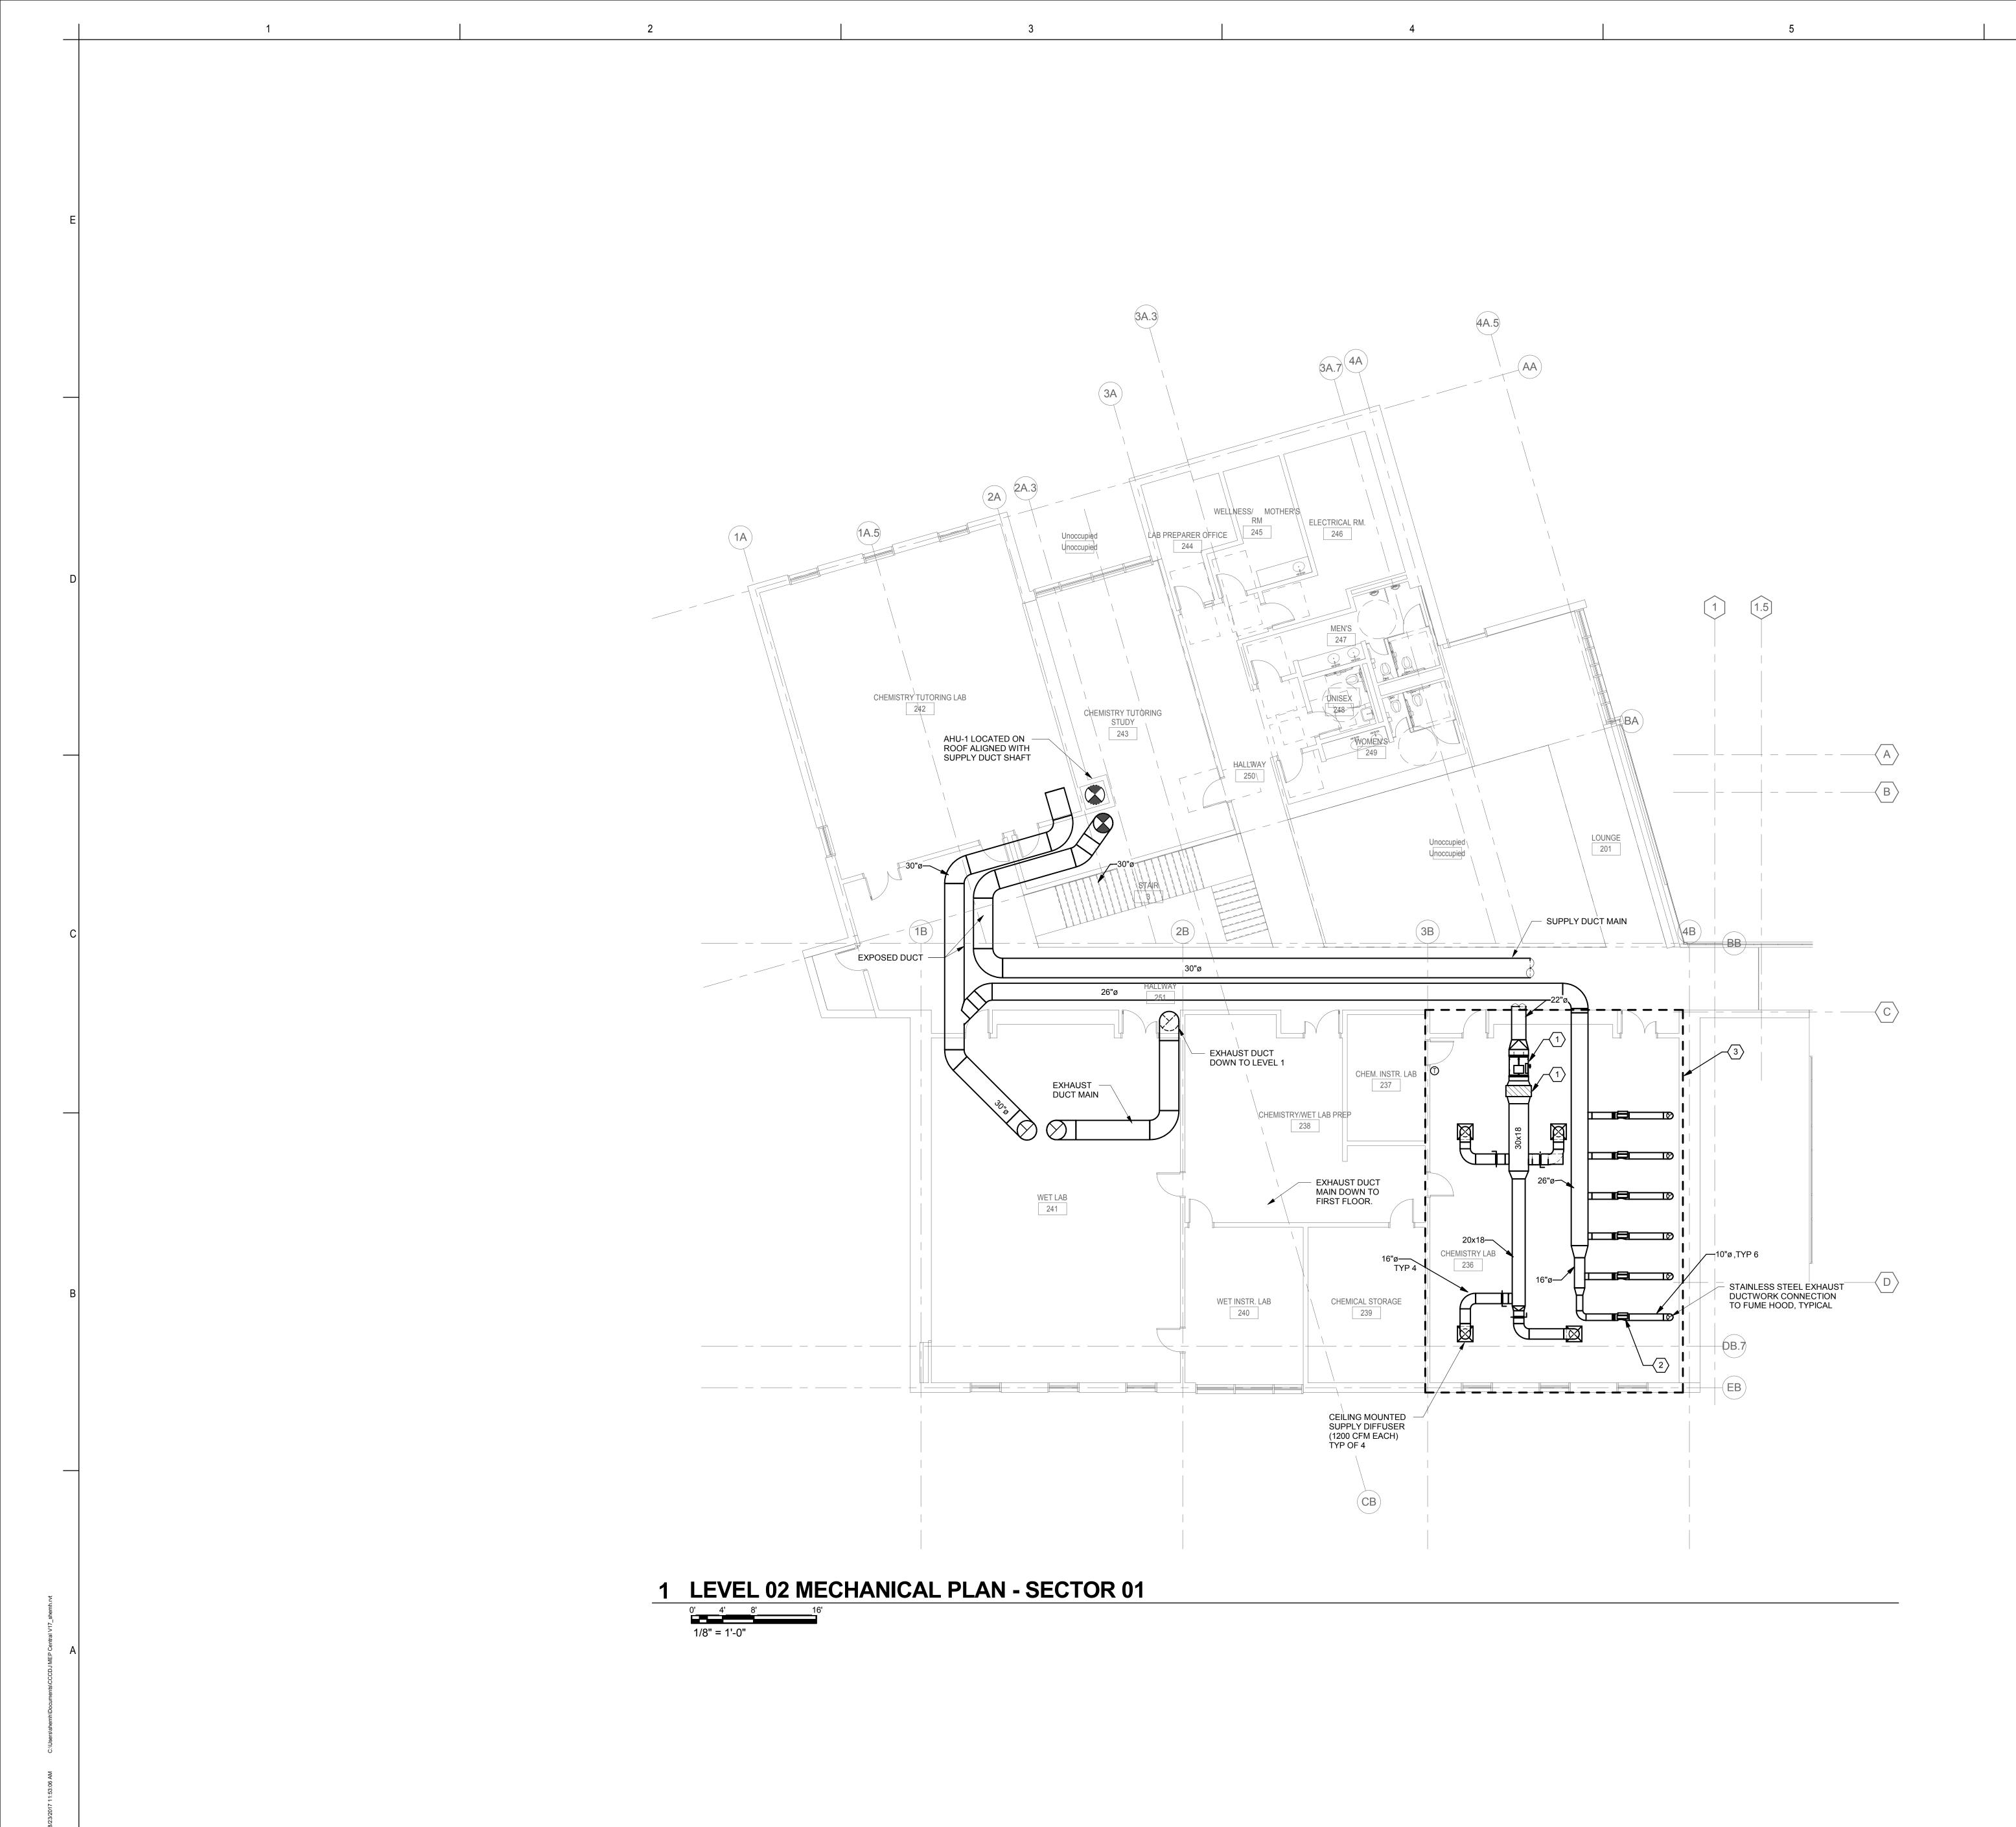

○ SHEET KEYNOTES

- 1 SUPPLY AIR VALVE (PHOENIX) WITH HW REHEAT COIL, TYPICAL.
- 2 EXHAUST AIR VALVE (PHOENIX).
- 3 TYPICAL LAB HVAC LAYOUT.

mahlum

71 COLUMBIA | FLOOR 4 **SEATTLE** WA 98104 (206) 441-4151 OFFICE (206) 441-0478 FAX

1231 NW HOYT | SUITE 102 **PORTLAND** OR 97209 (503) 224-4032 OFFICE

MAHLUM ARCHITECTS INC

PROJECT 2017-0180
CONTACT Shem Heiple

(503) 224-0918 FAX

INTERFACE
ENGINEERING

100 SW Main St.
Suite 1600
Portland, OR 97204
TEL 503.382.2266
FAX 503.382.2262
www.interfaceengineering.com





CLACKAMAS COMMUNITY COLLEGE DEJARDIN ADDITION/RENOVATION

19600 MOLALLA AVE. OREGON CITY, OR 97045

MARK DATE

ISSUE DATE: AUGUST 23, 2017
ISSUE: SCHEMATIC DESIGN

DESCRIPTION

PROJECT NO: Project Number


DRAWN BY: Author

CHECKED BY: Checker

COPYRIGHT MAHLUM ARCHITECTS, INC. 2011 ORIGINAL SHEET SIZE: 30"x42"

SECOND FLOOR PLAN - SECTOR 01 - MECHANICAL

M-221A

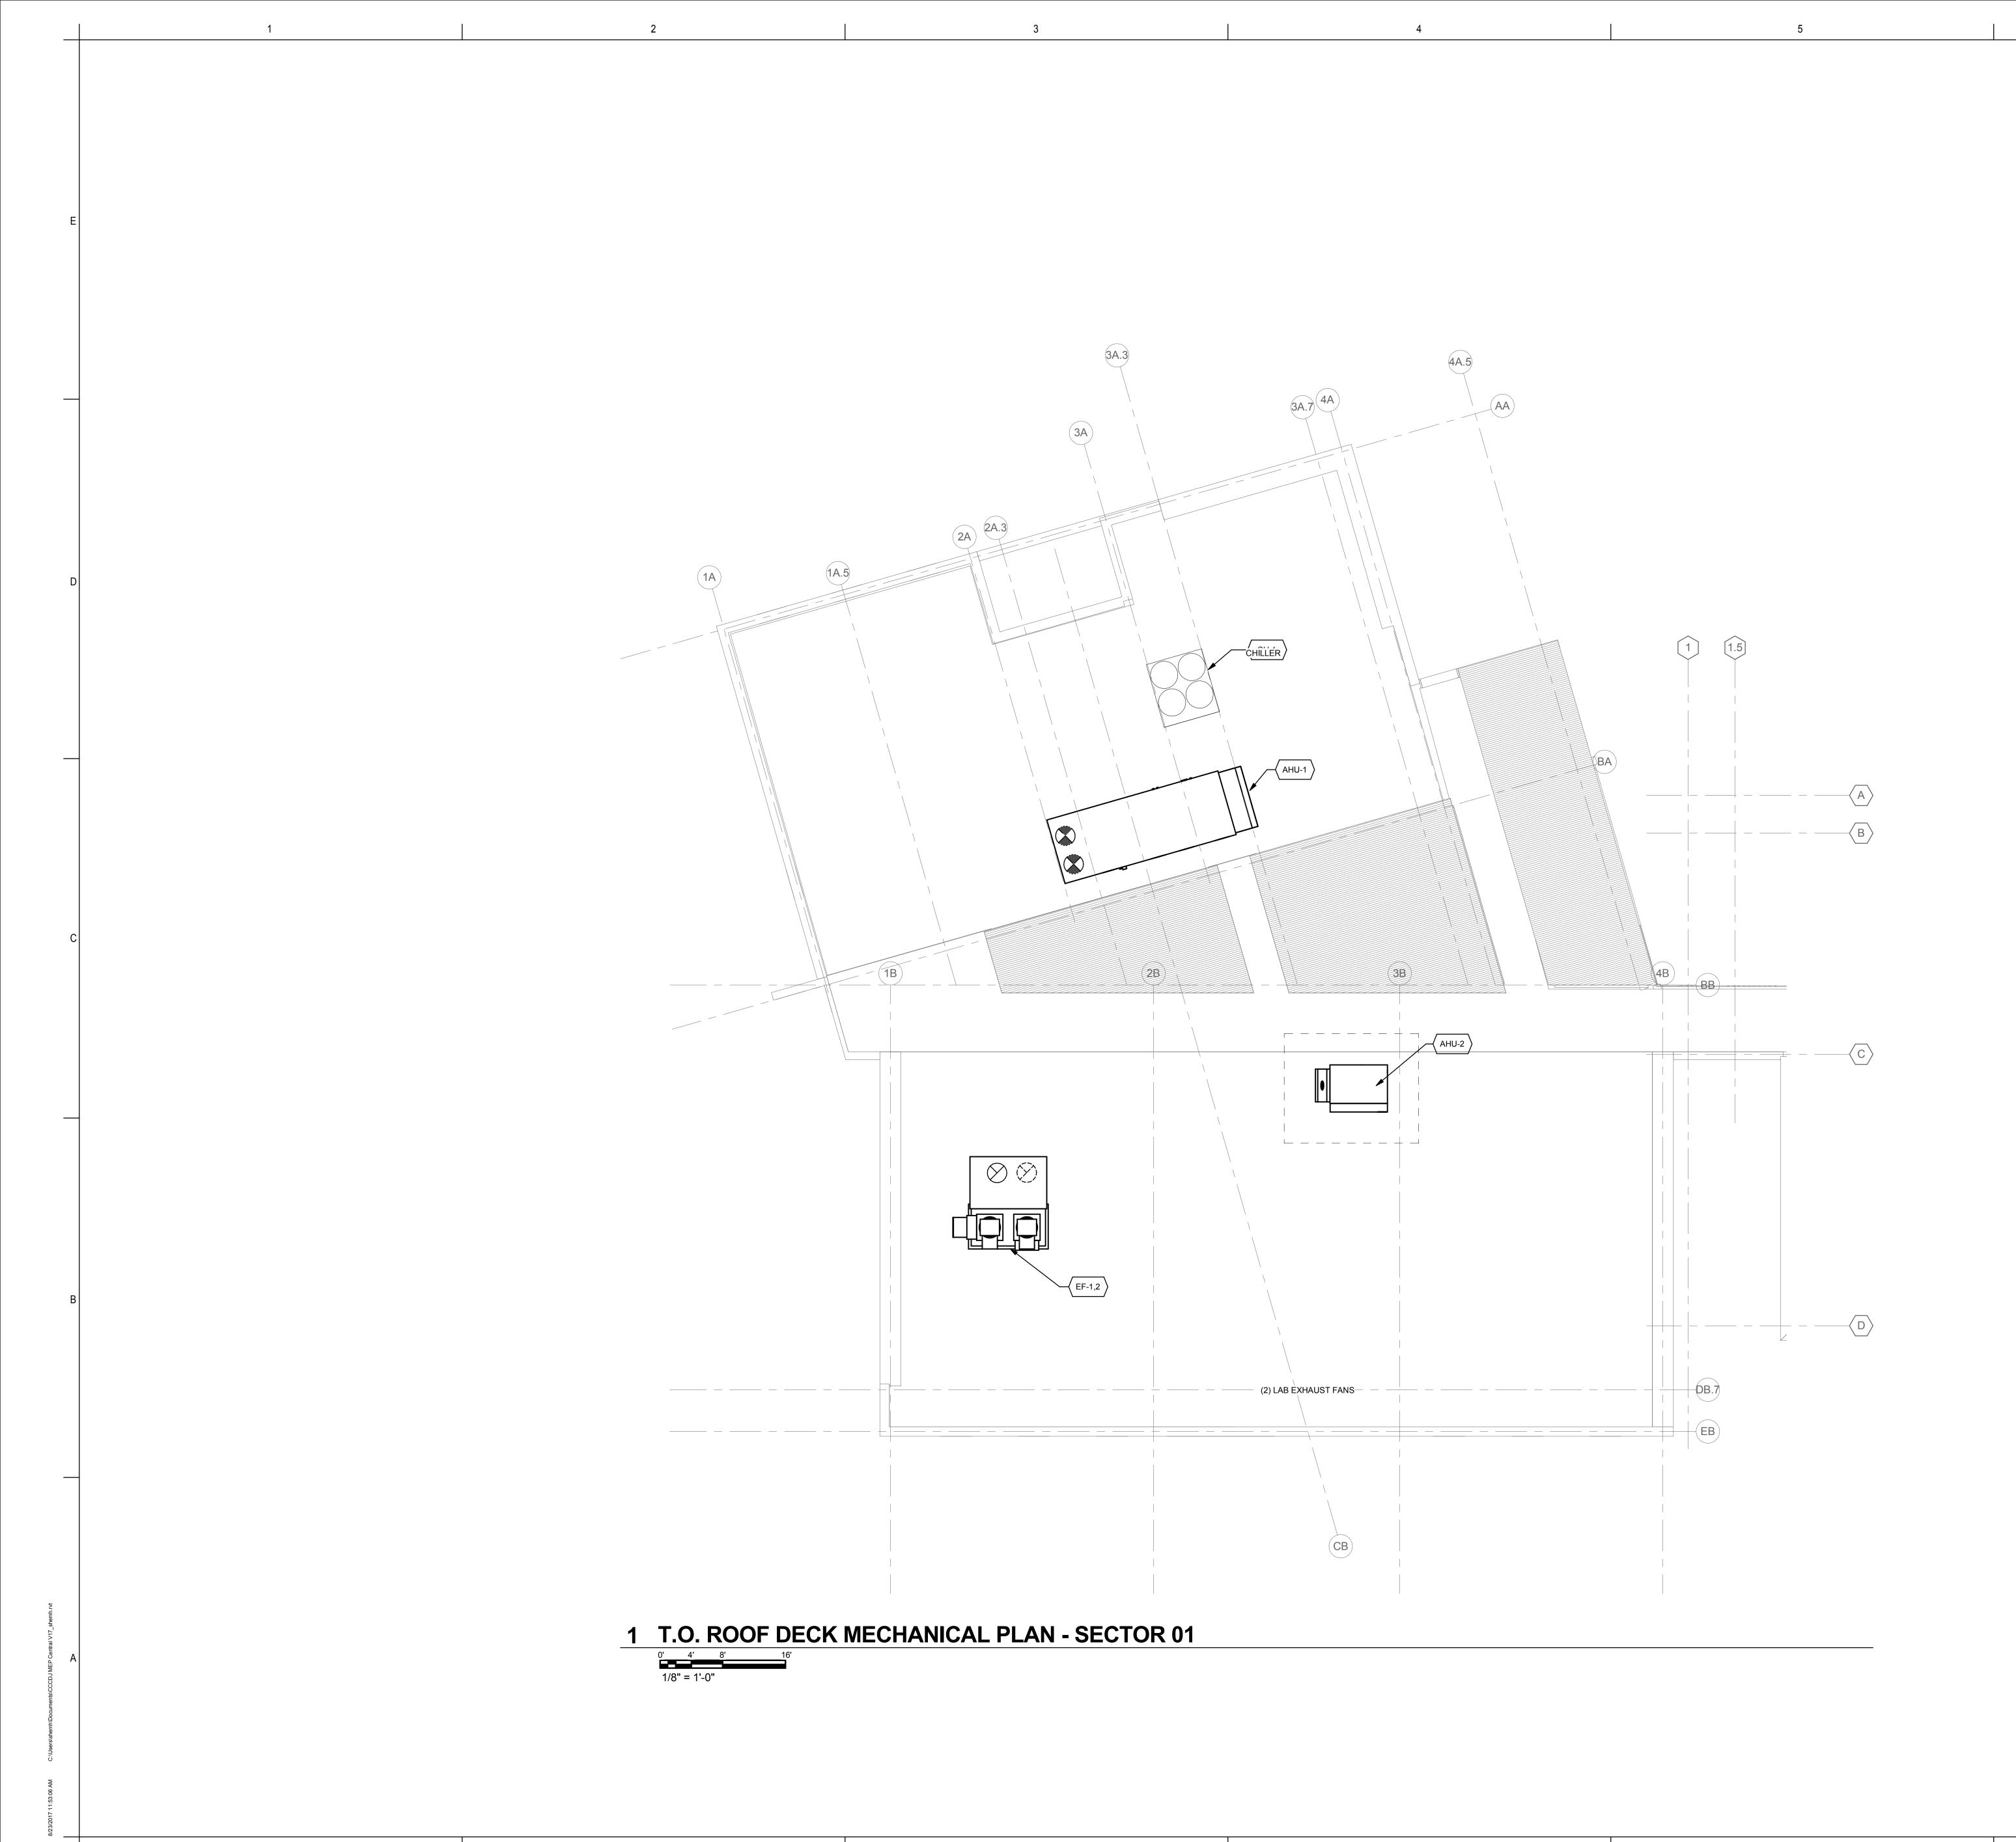

mahlum

71 COLUMBIA | FLOOR 4 **SEATTLE** WA 98104 (206) 441-4151 OFFICE (206) 441-0478 FAX

1231 NW HOYT | SUITE 102 **PORTLAND** OR 97209 (503) 224-4032 OFFICE

MAHLUM ARCHITECTS INC

(503) 224-0918 FAX

PROJECT 2017-0180 CONTACT Shem Heiple

INTERFACE
ENGINEERING

100 SW Main St.
Suite 1600
Portland, OR 97204
TEL 503.382.2266
FAX 503.382.2262
www.interfaceengineering.com

TERED PROFESSOR CE 17420 PROFESSOR 17420 PROFE



CLACKAMAS COMMUNITY COLLEGE DEJARDIN ADDITION/RENOVATION

19600 MOLALLA AVE. OREGON CITY, OR 97045

MARK DATE

AUGUST 23, 20 SCHEMATIC DESI

PROJECT NO: Project Number


DRAWN BY: Author

CHECKED BY: Checker

COPYRIGHT MAHLUM ARCHITECTS, INC. 2011 ORIGINAL SHEET SIZE: 30"x42"

ROOF PLAN - SECTOR 01 - MECHANICAL

M-231A

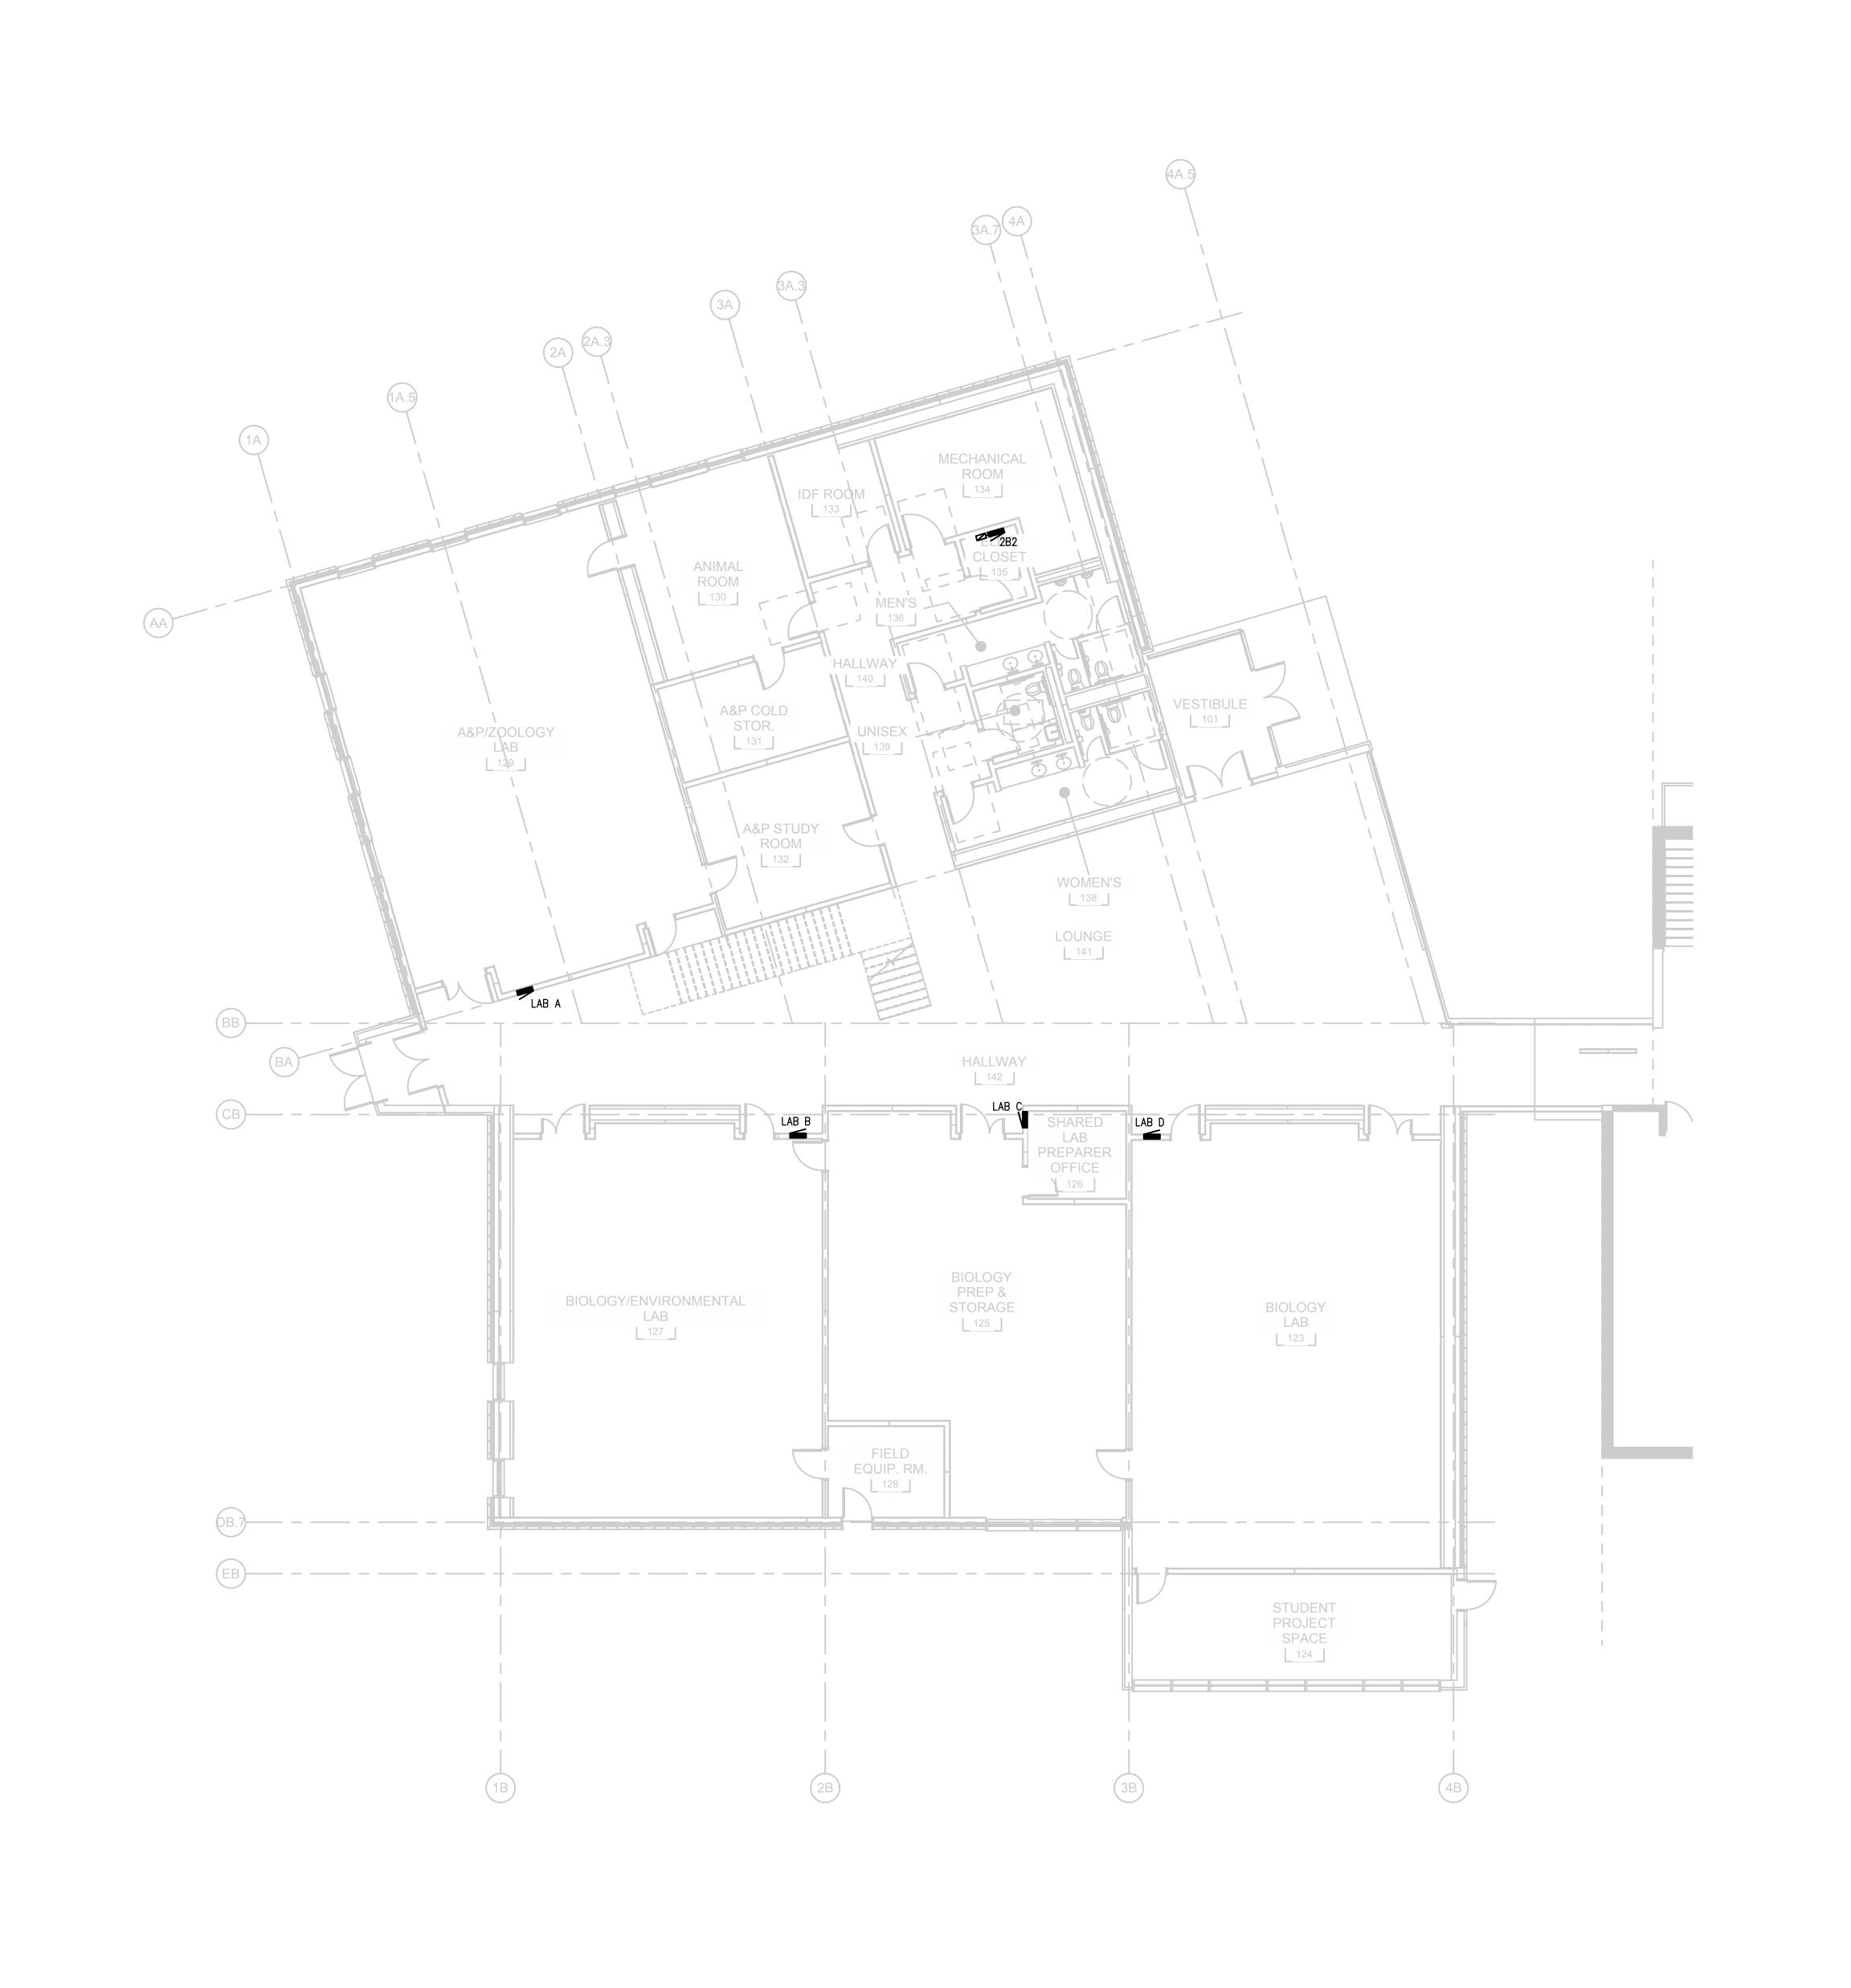



71 COLUMBIA | FLOOR 4 SEATTLE WA 98104 (206) 441-4151 OFFICE (206) 441-0478 FAX

1231 NW HOYT | SUITE 102 PORTLAND OR 97209 (503) 224-4032 OFFICE

(503) 224-0918 FAX

MAHLUM ARCHITECTS INC



733 SW Oak Street Suite 200 Portland Oregon 97205-3710 (503) 273-0060





CLACKAMAS COMMUNITY COLLEGE DEJARDIN ADDITION/RENOVATION

19600 MOLALLA AVE. OREGON CITY, OR 97045


AUGUST 23, 2017 SCHEMATIC DESIGN

2017401

PROJECT NO: **DRAWN BY:** COPYRIGHT MAHLUM ARCHITECTS, INC. 2011 ORIGINAL SHEET SIZE: 30"x42"

FIRST FLOOR POWER PLAN - SECTOR 01

E-121A

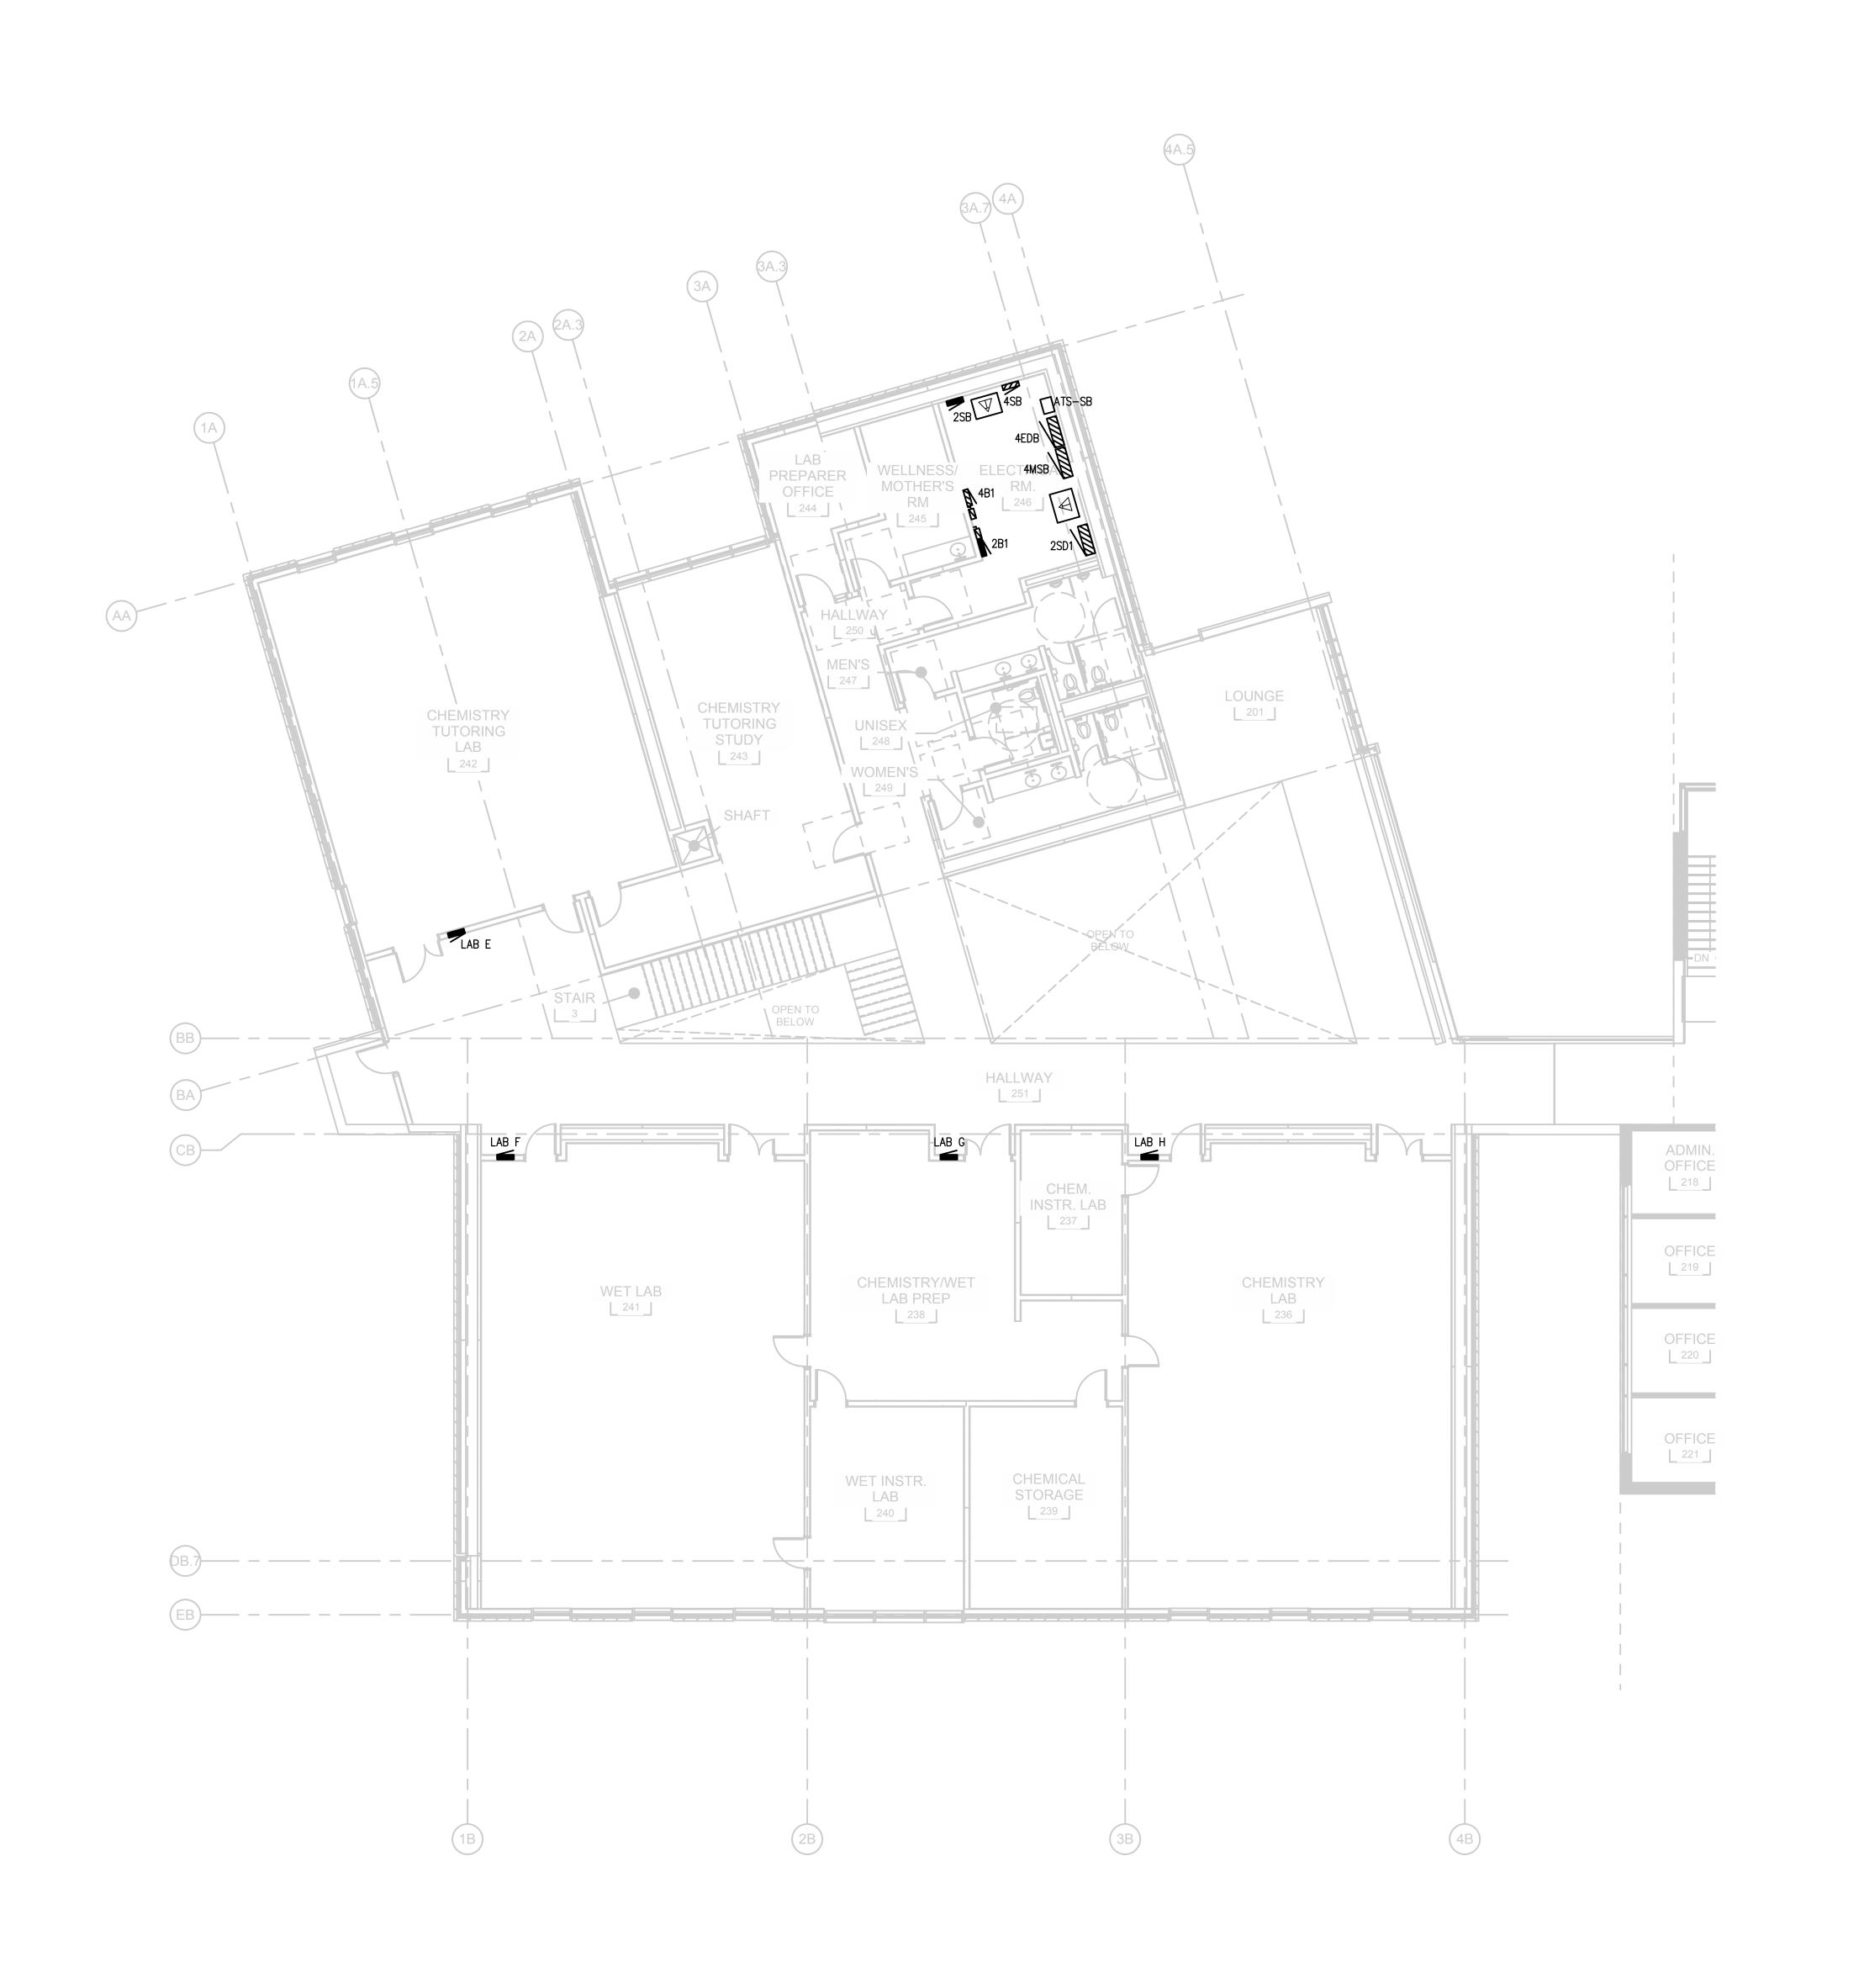

mahlum

71 COLUMBIA | FLOOR 4 **SEATTLE** WA 98104 (206) 441-4151 OFFICE (206) 441-0478 FAX

1231 NW HOYT | SUITE 102 **PORTLAND** OR 97209 (503) 224-4032 OFFICE

(503) 224-0918 FAX

MAHLUM ARCHITECTS INC



733 SW Oak Street Suite 200 Portland Oregon 97205-3710 (503) 273-0060





CLACKAMAS COMMUNITY COLLEGE DEJARDIN ADDITION/RENOVATION

19600 MOLALLA AVE. OREGON CITY, OR 97045

MARK DATE

UE DATE:AUGUST 23, 2017UE:SCHEMATIC DESIGN

PROJECT NO: 2017401

DRAWN BY: DLR

CHECKED BY: KAG

COPYRIGHT MAHLUM ARCHITECTS, INC. 2011 ORIGINAL SHEET SIZE: 30"x42"

SECOND FLOOR POWER PLAN - SECTOR 01

PLAN NORTH

E-122A

GENERATOR SIZE TBD BASED ON CAMPUS WIDE GENERATOR ASSESSMENT UNDERWAY

mahlum

71 COLUMBIA | FLOOR 4 **SEATTLE** WA 98104 (206) 441-4151 OFFICE (206) 441-0478 FAX


(503) 224-0918 FAX

1231 NW HOYT | SUITE 102 **PORTLAND** OR 97209 (503) 224-4032 OFFICE

MAHLUM ARCHITECTS INC



733 SW Oak Street Suite 200 Portland Oregon 97205-3710 (503) 273-0060

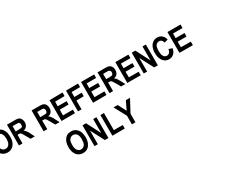



CLACKAMAS COMMUNITY COLLEGE DEJARDIN ADDITION/RENOVATION

19600 MOLALLA AVE. OREGON CITY, OR 97045

MARK DATE DESCRIPTION

ISSUE DATE: AUGUST 23, 2017
ISSUE: SCHEMATIC DESIGN

PROJECT NO: 2017401

DRAWN BY: DLR

CHECKED BY: KAG

COPYRIGHT MAHLUM ARCHITECTS, INC. 2011 ORIGINAL SHEET SIZE: 30"x42"

ONE-LINE DIAGRAM

PLAN ORTH